

Bureau of Environmental Health

7178 Gateway Drive (410) 313-2640 Columbia, MD 21046 Fax (410) 313-2648

TDD (410) 313-2323

Toll Free 1-866-313-6300

website: www.hchealth.org


Maura J. Rossman, M.D., Health Officer


RECEIPT DATE: 8/14/14 ONSITE	SEWAGE DISPOSAL SYST	EM	Р	554581
INSTALLATION APPROVAL DATE: 12/4/2014	PERMIT		А	
000000000000000000000000000000000000000	CONSTRUCTION			
PROPERTY ADDRESS: 4807 River Crossing Co	The state of the s	74	TAVID	
	LOT:			
CONTRACTOR: Fogle's Septic Clean Inc.	EMAIL:			
CONTRACTOR ADDRESS: 580 Obrecht Road			PHONE:	410-795-5670
PROPERTY OWNER: Toll MD V LP	EMAIL:		DUONE	440.072.0405
OWNER ADDRESS: 7164 Columbia Gateway	/ Drive, IMD 21045		_ PHONE:	410-872-9105
BAT UNIT MODEL: ECOPOD E609CA	BATI	JNIT SIZE	: <u>600GP</u>	D
PUMP CHAMBER CAPACITY (GALLONS):	PUMP SIZE:			and the second of the second o
NUMBER OF BEDROOMS: 4				
DISTRIBUTION SYSTEM: GRAVITY FED				
LINEAR FEET REQUIRED: SEE B.	AT PLAN 84	INI	ET DEPTH:	SEE BAT PLAN 4
TRENCHES: TRENCH WIDTH: SEE B.	AT PLAN 3' MAXIMU	и вотто	OM DEPTH:	8
MINIMUM SPACE BETWEEN TRENCHES: SEE B.	AT PLAN EFFECTIVE AREA	BEGINNI	NG DEPTH:	5
LOCATION: PER APPROVED SITE PLAN. SEWAG SURVEYOR PRIOR TO PRE-CONSTR	GE DISPOSAL AREA AND BAT UNIT LOC SUCTION INSPECTION.	ATION M	UST BE STAI	KED BY LICENSED
Set BAT unit per plan. 2×42	Trenches		· ·	
NOTES:		* ,		
ISSUED BY: Andrew Geisert	ISSUE DATE:	EXP	IRATION DA	ATE:
NOTE: CONTRACTOR MUST SCHEDULE A PRE-CO	ONSTRUCTION INSPECTION PRIOR TO I	BEGINNIN	IG ANY INST	ALLATION
NOTE: CONTRACTOR MUST SCHEDULE AN INSPE				
NOTE: STONE MUST BE APPROVED BY HEALTH D NOTE: WATERT!GHT SEPTIC TANKS REQUIRED	EPARTMENT AND GRAVEL TICKET MUS	T BE AVA	ILABLE FOR	REVIEW.
NOTE: ALL PARTS OF SEPTIC SYSTEM SHALL BE A	T LEAST 100 FEET DOWNGRADIENT FRO	M ANY V	VATER WELL	
NOTE: MANHOLE RISERS REQUIRED ON ALL SEPTINGTE: AN ELECTRICAL PERMIT IS REQUIRED FOR		OMBONE	NTS OF THE	CVCTEM
NOTE: AN ELECTRICAL PERMIT IS REQUIRED FOR NEITHER THE HOWARD COUNTY COL				

NEITHER THE HOWARD COUNTY COUNCIL NOR THE HEALTH DEPARTMENT IS RESPONSIBLE FOR THE SUCCESSFUL OPERATION OF ANY SYSTEM.

PERMITTEE RESPONSIBLE FOR OBTAINING FINAL APPROVAL ON THIS PERMIT. CALL 410-313-1771 TO SCHEDULE INSPECTIONS.

NOT TO SCALE	TRENCH/DRAINFIELD DATA WIDTH INLET BOTTOM 3 4 8
	NUMBER OF TRENCHES 2 TOTAL LENGTH 84'
	ABSORPTION AREA 252+51 de W
	DISTRIBUTION BOX LEVEL-CV 2 CV
	DISTRIBUTION BOX BAFFLE (CS
	DISTRIBUTION BOX PORT Yes
	SEPTIC TANK DATA
	SEPTIC TANK 1 LEVEL YES MANUFACTURER SABYLONI
	CAPACITY 2000 GAL
	SEAM LOC TOD
A D : 11 D : A	TANK LID DEPTH /-3'
See As-Built Drawing Un)	BAFFLES /-ront
See As-Built Drawing On Separate Sheet	MANHOLE LOC Front + Rear
Separate sheet	6" PORT LOC Middle
	WATERTIGHT TEST No
	SLOTTED_N/A
	DATE ON LID Dry
	RUMP/SEPTIC TANK LEVÉL N/A
	MANUFACTURER
	CARACITYGAL
	SEAM LOC
	BAFFLES
·	BAFFLE FILTER
	MANHOLE LOC
	WAZERTIGHT TEST
	SCOTTED
ROAD NAME	DATE ON LID
PRE-CONSTRUCTION: 9/12/2014 Connot law out trenches True	and being nemared
brown a a sement and A one a a sement stake	a have been torn
out. O. K. to set tank as shown on plan	1. (BB)
9/16/2014 French Originat done (BB)	
·// ·	
INSTALLATION: 9/17/2014 need house connection.	Jank and dist box
set, 133	
9/18/2014 Desten finished except for he	ruse connection
and approval from Babulan BB	
10/30/14- SHC inspection completed - connection good . ok +	backfill (P)
B B.	VAL 12/4/2014
FINAL INSPECTOR $\mathcal{V}_{\mathcal{O}}$, $\mathcal{O}_{\mathcal{O}}$ DATE OF APPRO	VAL 121712019 .

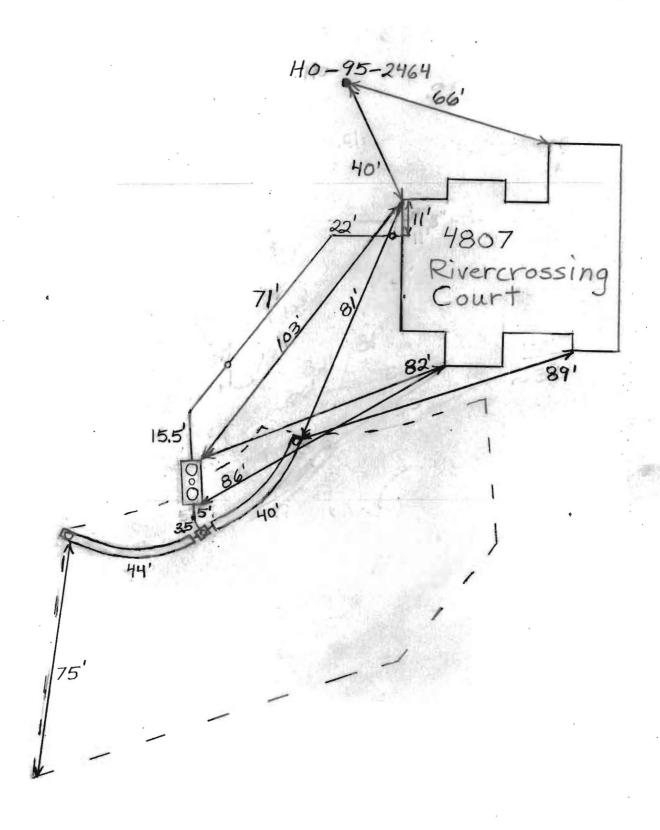

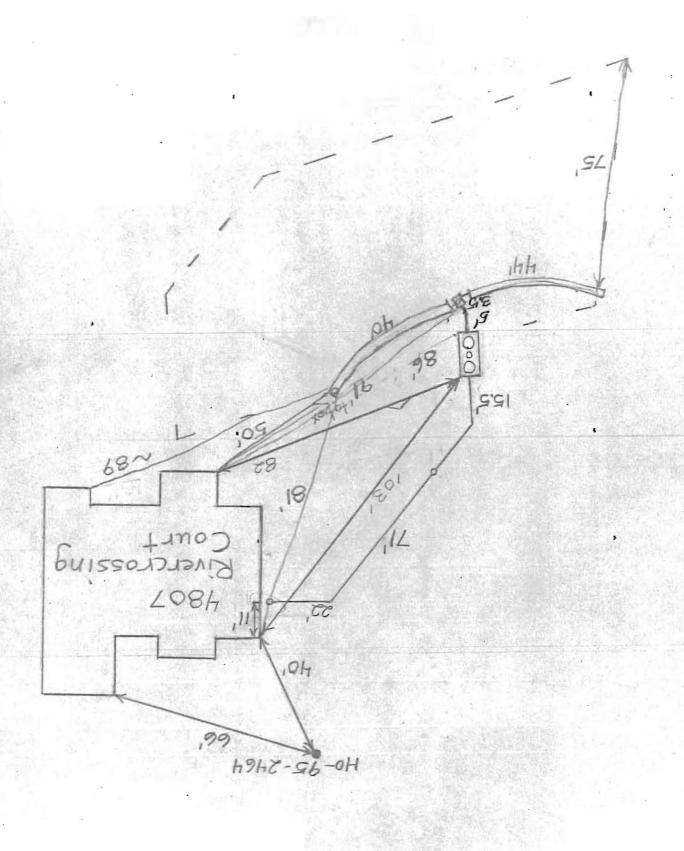

PROFESSIONAL CERTIFICATION: I HEREBY CERTIFY THAT THESE DOCUMENTS WERE PREPARED BY ME OR UNDER MY RESPONSIBLE CHARGE, AND THAT I AM A DULY LICENSED PROFESSIONAL LAND SURVEYOR UNDER THE LAWS OF THE STATE OF MARYLAND, LICENSE NO. 21328, EXPIRATION DATE 1/8/15. LEGEND: SHADED AREA OF HOUSE HAS NO FLOOR BELOW IT - IT IS THE ACTUAL LOWEST LEVEL OF THE BUILDING (WALKOUT CONDITIONS AT THE REAR). BRL BUILDING RESTRICTION LINE TOP OF WALL CLOSEST WALL TO SEPTIC RESERVE AREA IS 10.0' AWAY AS SHOWN. ELEV. ELEVATION W.ZEASII. W NON-BUILDABLE PRESERVATION PARCEL K OWNER: HOMEOWNER'S ASSOCIATION EASEMENT HOLDER: HOWARD COUNTY, MARYLAND wall check okay 919/14.40. LOT 72 SEPTIC SETBACK 20' SEPTIC SETBACK POURED CONCRETE WALLS W. ELEV. = 384.59' T.W. ELEV. , k⁹.5'* 10' PUBLIC TREE AND MAINTENANCE EASEMENT /50'_BRI RIVERCROSSING COURT BUILDING SETBACKS (B.R.L.'s) SHOWN HEREON PER SITE DEVELOPEMENT PLAN SETBACK DISTANCES SHOWN HEREON AS "±" HAVE AN ACCURACY OF ±0.1' FOOT. 4807 RIVERCROSSING COURT ADDRESS: ELLICOTT CITY, MD 21042 SURVEYOR'S CERTIFICATE WALLCHECK THIS WALLCHECK WAS PREPARED WITHOUT THE BENEFIT OF A CURRENT TITLE REPORT. THIS PROPERTY IS SUBJECT TO ANY AND ALL EASEMENTS, RIGHT—OF—WAYS, COVENANTS, AND RESTRICTIONS, ETC. OF RECORD, SOME OR LOT 71 HOMEWOO CROSSING ALL OF WHICH MAY OR MAY NOT BE SHOWN AND/OR REFERENCED HEREON.
BEARINGS AND DISTANCES OF THE PROPERTY BOUNDARY LINES SHOWN HEREON
ARE PER AVAILABLE RECORDS AND HAVE NOT BEEN FIELD VERIFIED.
THIS IS NOT A "LOCATION DRAWING" AND IS NOT TO BE USED FOR LIBER 9808, FOLIO 204 PLAT NO. 18243 SETTLEMENT PURPOSES. ELECTION DISTRICT NO. 5 09/08/ HOWARD COUNTY, MARYLAND 21328 SIGNATURE: MICHAEL JOE BOYCE ESE Consultants Inc. Land Planning 4101 Ritchie Marlboro Rd. Engineering Upper Marlboro, MD 20772 Tel: 301-627-8504 Land Surveying Fax: 301-627-7985

DATE: 09/08/14

CHK'D: M.J.B.

FILE: WC LOT 71_rev1

DRAWN: R.C.K.

SCALE: 1"=50

JOB NO: 1214

MEMBER N. C. B. V. A.

MEMBER P. C. B. V. A.



Burial Vaults - Septic Tanks

925 Wakefield Valley Road New Windsor, MD 21776

PHONE:

410-848-0393

Fax:

410-848-3551

Five Year	Initial Service Policy
On Site Wast	ewater Treatment Sys
The state of the s	

Off Office 11:	asterater reatment bystem
Brand Name: Ecopoo	Model Number: ECOPOD 66
Purchase Date: 9/11/19	Serial Number: FGEN - CR 160 CA

INITIAL POLICY:

A five (5) year service policy shall be furnished to the user by the Installer.

This policy is included in the original purchase price and shall provide the following:

- 1. An inspection/service call every six months which includes inspections, adjustment and servicing of the mechanical and electrical component parts as necessary to ensure proper function for the first year. And once a year there after.
- 2. An effluent quality inspection every six months consisting of a visual check for color, turbidity, seum overflow, and an examination for odors for the first year. And then once a year there after.
- 3. A sample shall be pulled from the aeration tank once a year as described in the "Solids Removal" Section to determine if there is an excess of solids in the treatment plant. If the test results determine if there is an excess of solids in the treatment plant. If the rest results determine a need for solids removal, the user will bear the cost and responsibility for doing so.
- 4. If any improper operation is observed which cannot be corrected at that time, the user shall be notified immediately in writing of the conditions and the estimated date of correction.

Violations of Warranty including shutting off the electric current to the system for more than 24 hours, disconnecting the alarm system restricting ventilation to the aerator, overloading the system above its rated capacity, or introducing excessive amounts of harmful matter into the system, or any other form of unusual abuse.

THIS POLICY DOES NOT INCLUDE PUMPING SLUDGE FROM UNIT IF NECESSARY

PERMITTING AUTHORITY: HOW JORD COUNTY	SYSTEM OWNER:
NSTALLATION LOCATION: 4811 Rivers Crossing Ct Ellicott City MD 2104)	Babulas Vout Co 925 Wakefred Valley Rd New Windsop MD 21776
Installer: Focle Soptie Object t Rd Sykswille MD 21184	SERVICE COMPANY: Baby box Vau H Co Service Operators License Number: Stavent Koonty G. M.
agree to abide by the service policy as stated above: Witness:	

TO SEPTIC SETBACK

CONCRETE WALLS

T.W. ELEV. = 384.59. 30 WELL SETBACK

SET SO OF POLICY SETBACK

ON SEPTIC SETBACK

ON SEPTIC

BUILDING SETBACKS (B.R.L.'s) SHOWN HEREON PER SITE DEVELOPEMENT PLAN SETBACK DISTANCES SHOWN HEREON AS " \pm " HAVE AN ACCURACY OF \pm 0.1' FOOT.

ADDRESS: 4807 RIVERCROSSING COURT ELLICOTT CITY, MD 21042

SURVEYOR'S CERTIFICATE

THIS WALLCHECK WAS PREPARED WITHOUT THE BENEFIT OF A CURRENT TITLE REPORT. THIS PROPERTY IS SUBJECT TO ANY AND ALL EASEMENTS, RIGHT-OF-WAYS, COVENANTS, AND RESTRICTIONS, ETC. OF RECORD, SOME OR ALL OF WHICH MAY OR MAY NOT BE SHOWN AND/OR REFERENCED HEREON. BEARINGS AND DISTANCES OF THE PROPERTY BOUNDARY LINES SHOWN HEREON ARE PER AVAILABLE RECORDS AND HAVE NOT BEEN FIELD VERIFIED. THIS IS NOT A "LOCATION DRAWING" AND IS NOT TO BE USED FOR SETTLEMENT PURPOSES.

SIGNATURE: MICHAEL JOE BOYCE

21328 24/

DA

6/11

WALLCHECK LOT 71

HOMEWOO CROSSING

LIBER 9808, FOLIO 204
PLAT NO. 18243
ELECTION DISTRICT NO. 5
HOWARD COUNTY, MARYLAND

10909D-

ESE

Land Planning Engineering Land Surveying ESE Consultants Inc. 4101 Ritchie Marlboro Rd. Upper Marlboro, MD 20772 Tel: 301-627-8504 Fax: 301-627-7985

DATE: 09/08/14 CHK'D: M.J.B.

SCALE: 1"=50' JOB NO: 1214 FILE: WC LOT 71_rev1 DRAWN: R.C.K.

	02 Fn.:	11.6	
	e3 Environmental	LLC	
	302-725-0788 www e300016 000 ECOPOD-N Completion Statem		
Installation Information		ient	
Owners Name	<u>n</u>	7	
Street	11611 0	# of Bedrooms / GPD	_600
City	4811 River Crossing Ct	1	
State	Ellicott City	Repair	
Zip	MD	New Construction	X
	2042	1	
Installation Company			
Company	Fooles	Installed Date	9/11/14
Certified Installer	James Deavers	Startup Date	16/14/14 6/18/14
Street	Obsecht Rd		
City	Syksuille	1	
State	mo		
Zip	21784		
ECODOD 'N			•
ECOPOD-N			
Model # '	Serial #	1	
E50			
E60 X	E 60 N- 62160 CA	1	
E75 E100			
		1	
E150		}	
Blower Voltage	Good]	
Blower Running Amps	Good		
Inches of water over			
media with blower	1		
turned off	Ztaches		
Vent Installed	y es		
Tanks and Risers Water			
tight	yes		
Alarm Functional	UCS]	
	,		
11. 1	FOODOR II		
I herby certify that the ECOPOD-N wastewater treatment system has been installed and			
started up in accordance with the construction permit and is in compliance with the			
manufacturers recommendations			

Company	Baby-low	Vault Co.	Date 1/14/19
Signature	Staven P	Kont	
Printed Name		Kcontz	

Geisert, Andrew

From:

Geisert, Andrew

Sent:

Monday, May 05, 2014 3:58 PM

To:

'mboyce@eseeng.com'

Subject:

Homewood Crossing Lot 71 BAT Plan review

Michael,

The following are corrections for the BAT Plan review for Lot 71.

Only a TRUE deck can be within 20 feet of a sewage disposal area. Even a portion of the house on a crawl space
must maintain a 20 foot setback from the easement. Please adjust the location of the house to maintain a 20
septic setback and still maintaining a 30 foot well setback.

Andrew Geisert Environmental Sanitarian Supervisor Howard County Health Department Bureau of Environmental Health Office: 410-313-6287

Fax: 410-313-2648

ageisert@howardcountymd.gov

CONFIDENTIALITY NOTICE

This message and the accompanying documents are intended only for the use of the individual or entity to which they are addressed and may contain information that is privileged, confidential, or exempt from disclosure under applicable law. If the reader of this email is not the intended recipient, you are hereby notified that you are strictly prohibited from reading, disseminating, distributing, or copying this communication. If you have received this email in error, please notify the sender immediately and destroy the original transmission.

Geisert, Andrew

From:

Geisert, Andrew

Sent:

Tuesday, May 06, 2014 10:46 AM

To:

'Michael Boyce' Davis, Michael J

Cc: Subject:

RE: Homewood Crossing Lot 71 BAT Plan review

Michael,

I spoke with Mike following your e-mail response. A 10 foot setback will work for the crawlspace.

Andrew Geisert
Environmental Sanitarian Supervisor
Howard County Health Department
Bureau of Environmental Health
Office: 410-313-6287

Office: 410-313-6287 Fax: 410-313-2648

ageisert@howardcountymd.gov

CONFIDENTIALITY NOTICE

This message and the accompanying documents are intended only for the use of the individual or entity to which they are addressed and may contain information that is privileged, confidential, or exempt from disclosure under applicable law. If the reader of this email is not the intended recipient, you are hereby notified that you are strictly prohibited from reading, disseminating, distributing, or copying this communication. If you have received this email in error, please notify the sender immediately and destroy the original transmission.

From: Michael Boyce [mailto:MBOYCE@eseeng.com]

Sent: Tuesday, May 06, 2014 8:31 AM

To: Geisert, Andrew Cc: Davis, Michael J

Subject: RE: Homewood Crossing Lot 71 BAT Plan review

I have had this conversation in the past with Mike Davis.

My understanding of the 20' setback is to keep the easement away from the basement. We have done this in the past where we allowed a crawl space to be within the 20' setback.

As you can see, there is not any room to adjust the house and stay out of the well setback.

All of the trenches, primary, second and third (not shown) will be more than 20' from the house and 2' below basement floor or better.

Michael Boyce

Regional Director

ESE Consultants, Inc.

7164 Columbia Gateway Dr. | Suite230 | Columbia MD 21046

P: 410-381-3058 | C: 410-365-4175

mboyce@eseeng.com

From: Geisert, Andrew [mailto:ageisert@howardcountymd.gov]

Sent: Monday, May 05, 2014 3:58 PM

To: Michael Boyce

Subject: Homewood Crossing Lot 71 BAT Plan review

Michael,

The following are corrections for the BAT Plan review for Lot 71.

Only a TRUE deck can be within 20 feet of a sewage disposal area. Even a portion of the house on a crawl space
must maintain a 20 foot setback from the easement. Please adjust the location of the house to maintain a 20
septic setback and still maintaining a 30 foot well setback.

Andrew Geisert Environmental Sanitarian Supervisor Howard County Health Department Bureau of Environmental Health Office: 410-313-6287

Fax: 410-313-2648

ageisert@howardcountymd.gov

CONFIDENTIALITY NOTICE

This message and the accompanying documents are intended only for the use of the individual or entity to which they are addressed and may contain information that is privileged, confidential, or exempt from disclosure under applicable law. If the reader of this email is not the intended recipient, you are hereby notified that you are strictly prohibited from reading, disseminating, distributing, or copying this communication. If you have received this email in error, please notify the sender immediately and destroy the original transmission.

Williams, Jeffrey

From:

Williams, Jeffrey

Sent:

Thursday, March 13, 2014 11:57 AM

To:

'Michael Boyce'

Subject: RE: Septic data sheets

Here is data for the lots in question. I am working on a new form to provide this data, but for now here are the numbers. You can plug them into the following equations:

#of bedrooms x 150gpd / application rate = square footage absorption area needed. Divide by width of trench used to get linear length of trench needed

Sidewall credit: $(W+2)/(W+1+2D) \times 100$, where W is width of trench and D is depth in feet between effective depth and bottom depth.

Meriwether lot 5: app rate-0.6, effective depth-4', bottom-5.5'

Homewood Xing lot 71: app rate-1.2, eff depth-5', bottom-8'

Edgewood Farm lot 57: app rate-0.8, eff depth-5', bottom-8'

Meriwether lot 24: app rate-1.2, eff depth-4', bottom-6'

Homewood xing lot 77: app rate-1.2, eff depth-4.5', bottom-7'

Homewood xing lot 44: ***This lot has a condition to put the initial septic system in the farthest part of the area from the wells on lots 66 and 67***

App rate-0.6, eff depth-7', bottom-8'

From: Michael Boyce [mailto:MBOYCE@eseeng.com]

Sent: Thursday, March 13, 2014 9:27 AM

To: Williams, Jeffrey

Subject: Septic data sheets

Reminder to send the data sheets from the list I dropped off on Tuesday.

thanks

Michael Boyce


Regional Director


ESE Consultants, Inc.


7164 Columbia Gateway Dr. | Suite203 | Columbia MD 21046


P: 410-872-3058 | C: 410-365-4175

mboyce@eseeng.com

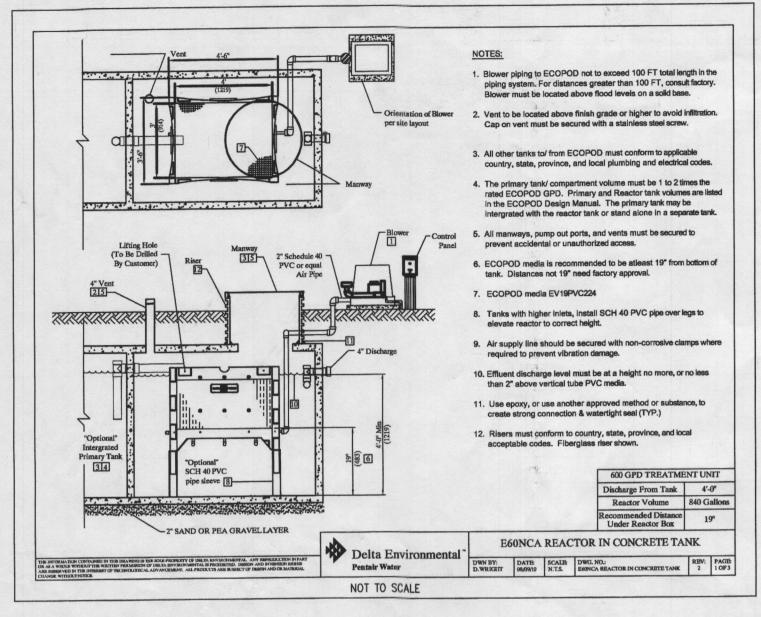

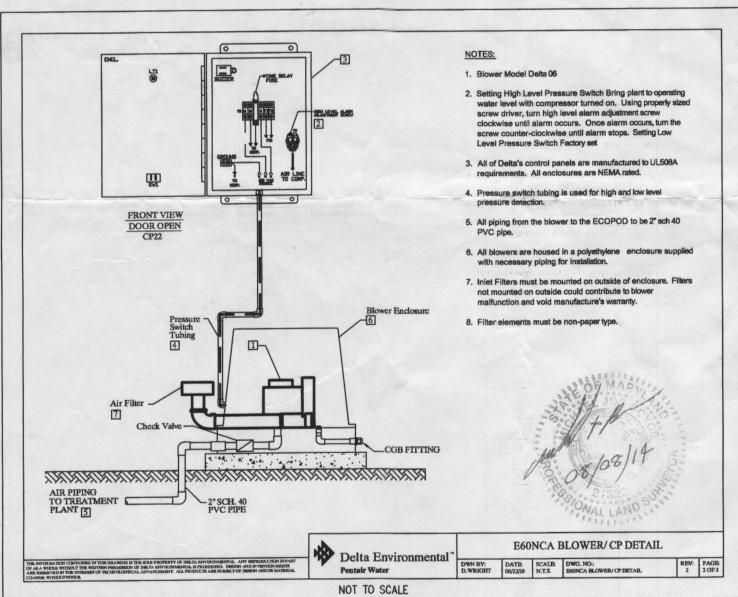

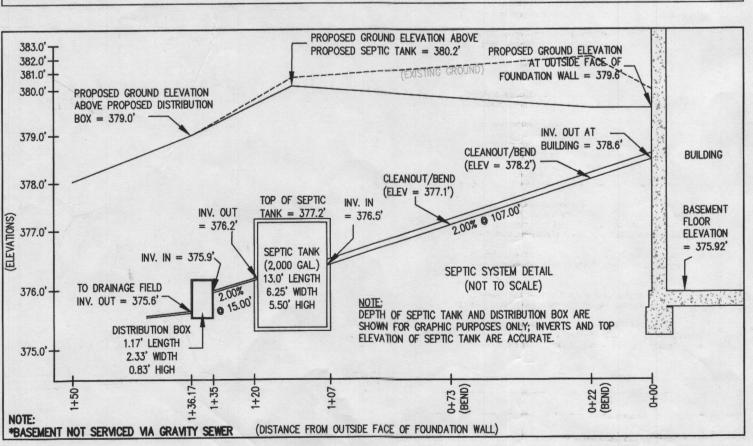

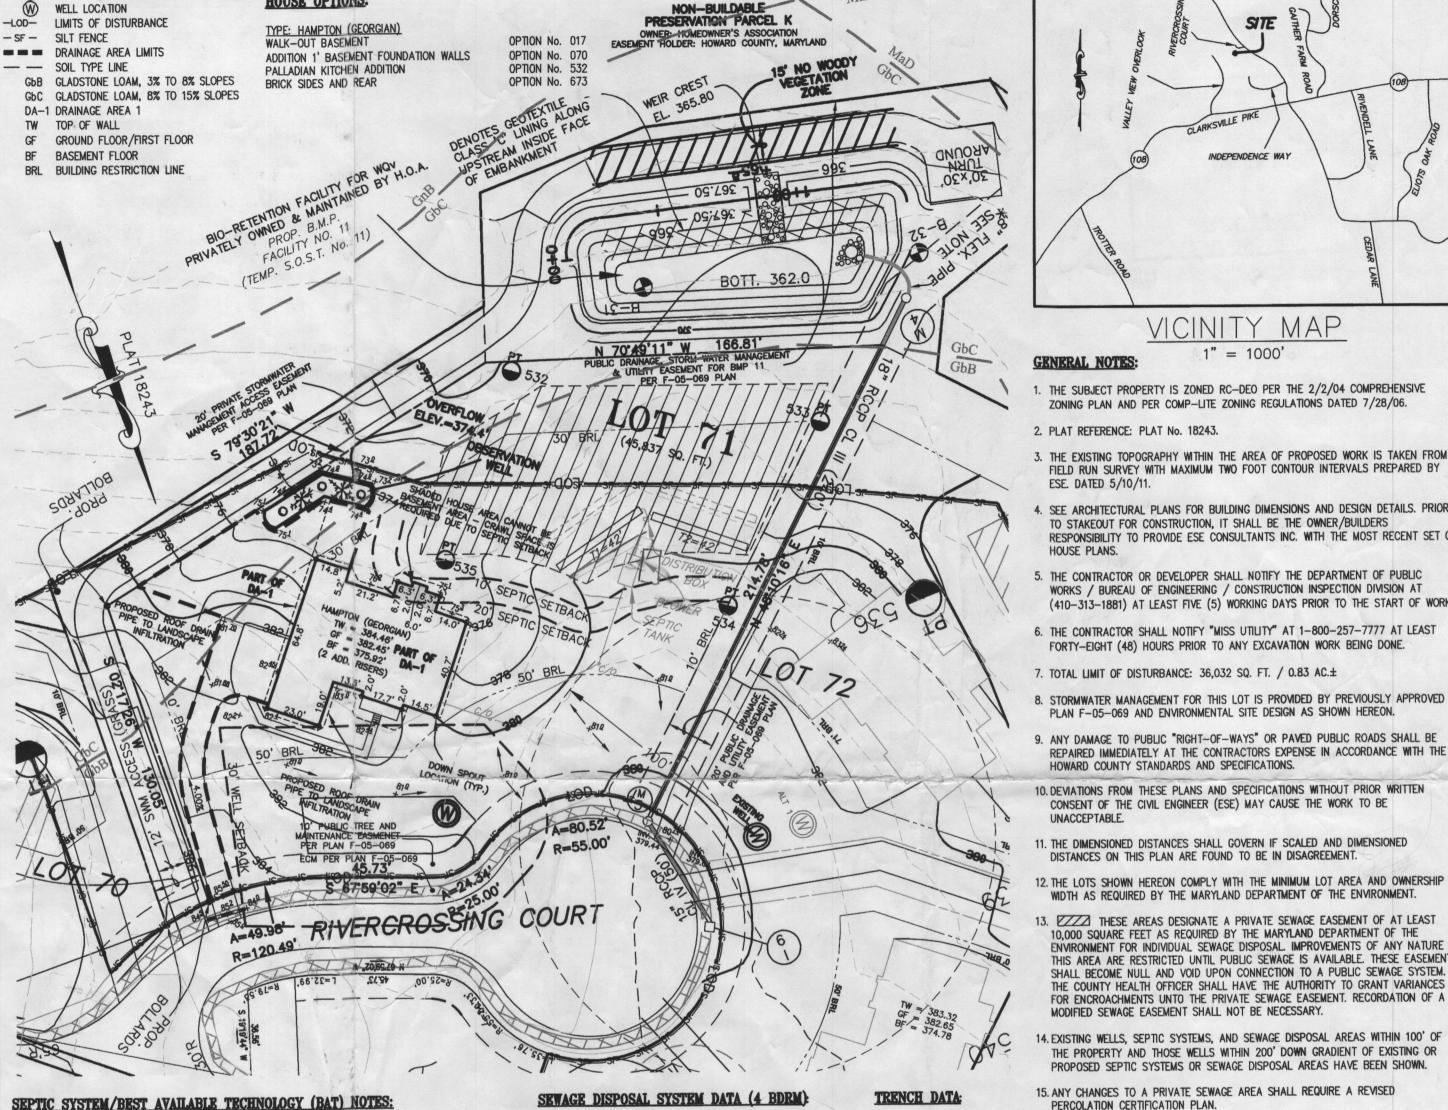

- ANY CHANGE TO THE LOCATIONS OR DEPTHS TO ANY COMPONENTS MUST BE APPROVED BY THE ENGINEER AND THE HOWARD COUNTY HEALTH DEPARTMENT PRIOR TO INSTALLATION. A REVISED SITE
- 2. THE MAXIMUM DEPTH OF THE BAT PER THE MANUFACTURER'S SPECIFICATION IS 3 FEET COVER.

PERC TEST LOCATION

HOUSE OPTIONS:

- 3. THE BLOWER MAY NOT BE LOCATED MORE THAN 100 FEET FROM THE TANK BASED ON THE MANUFACTURER'S SPECIFICATIONS.
- 4. THE BAT SYSTEM SHALL BE MAINTAINED AND OPERATED FOR THE LIFE OF THE SYSTEM.
- 5. THE BAT SHALL BE OPERATED BY AND MAINTAINED BY A CERTIFIED SERVICE PROVIDER.
- 6. WITHIN ONE MONTH OF INSTALLATION, A PERSON INSTALLING THE BAT SYSTEM SHALL REPORT TO THE MARYLAND DEPARTMENT OF THE ENVIRONMENT (MDE), IN A MANNER ACCEPTABLE TO MDE, THE ADDRESS AND DATE OF COMPLETION OF THE BAT INSTALLATION AND THE TYPE OF BAT INSTALLED.
- 7. ELECTRICAL WORK FOR THE BAT INSTALLATION MUST BE PERFORMED BY A LICENSED ELECTRICIAN.
- 8. AN AGREEMENT AND EASEMENT MUST BE COMPLETED AND SIGNED BY ALL APPLICABLE PARTIES, AND RECORDED IN THE LAND RECORDS OF HOWARD COUNTY.
- 9. THE HEALTH DEPARTMENT REQUIRES DOCUMENTATION FOR THE START-UP CERTIFICATION FROM THE MANUFACTURER PRIOR TO FINAL APPROVAL OF THE INSTALLATION.

APPROVED: FOR HOWARD COUNTY DEPARTMENT OF PLANNING & ZONING

CHIEF, DEVELOPMENT ENGINEERING DIVISION DATE DATE DIRECTOR DATE PROFESSIONAL ENGINEER

EGO ECOPOD 2 CHAMBER SYSTEM

PROPOSED INVERT AT FOUNDATION WALL: 378.6' 1. EX. GRADE OVER TANK: 380.7' PROPOSED GRADE OVER TANK: 380.2' INVERT IN: 376.5' INVERT OUT: 376.2'

PROFESSIONAL CERTIFICATION: I HEREBY CERTIFY THAT THESE DOCUMENTS WERE PREPARED BY ME OR UNDER MY RESPONSIBLE CHARGE, AND THAT I AM A DULY LICENSED PROFESSIONAL LAND SURVEYOR UNDER THE LAWS OF THE STATE OF MARYLAND, LICENSE NO. 21328, EXPIRATION DATE 1/8/15.

> 2 DISTRIBUTION BOX EXISTING GRADE OVER BOX: 379.0' PROPOSED GRADE OVER TANK: 379.0' INVERT IN: 375.9' INVERT OUT: 375.6'

3. TRENCH DESIGN (4 BDRM x 150 GPD/BDRM

9' MIN. SPACING BETWEEN TRENCH EDGES

USE 3' WIDE TRENCH WITH 48" GRAVEL BELOW PIPE

 $500 \text{ SF} \div 3' \text{ WDTH} = 166.67 \text{ LF} \times 0.50 = 83.34$

600 GPD ÷ 1.2 APP. RATE = 500 SF

USE 2 42' LONG TRENCHES = 84 LF

BOTTOM MAX. DEPTH (8')

GROUND ABOVE = 378.9INV. IN = 374.9'

TRENCH 2 (T2): INV. IN = 374.8'

GROUND ABOVE = 378.8'

TRENCH 1 (T1): BOTTOM TRENCH = 370.9'

16. UPON BUILDING PERMIT REVIEW THE SEPTIC SYSTEMS FOR ALL PROPOSED STRUCTURES AND/OR EXISTING STRUCTURE EXPANSIONS SHALL BE RE-EVALUATED

15. ANY CHANGES TO A PRIVATE SEWAGE AREA SHALL REQUIRE A REVISED

MODIFIED SEWAGE EASEMENT SHALL NOT BE NECESSARY.

TO DETERMINE SUFFICIENT SYSTEM CAPACITY. 17. THE DEVELOPMENT OF THIS LOT DOES NOT REQUIRE AN ENVIRONMENTAL CONCEPT PLAN SINCE STORMWATER MANAGEMENT WAS PREVIOUSLY APPROVED UNDER

INDEPENDENCE WAY

VICINITY MAP

1" = 1000'

FIELD RUN SURVEY WITH MAXIMUM TWO FOOT CONTOUR INTERVALS PREPARED BY

SEE ARCHITECTURAL PLANS FOR BUILDING DIMENSIONS AND DESIGN DETAILS. PRIOR

RESPONSIBILITY TO PROVIDE ESE CONSULTANTS INC. WITH THE MOST RECENT SET OF

TO STAKEOUT FOR CONSTRUCTION, IT SHALL BE THE OWNER/BUILDERS

5. THE CONTRACTOR OR DEVELOPER SHALL NOTIFY THE DEPARTMENT OF PUBLIC WORKS / BUREAU OF ENGINEERING / CONSTRUCTION INSPECTION DIVISION AT (410-313-1881) AT LEAST FIVE (5) WORKING DAYS PRIOR TO THE START OF WORK.

FORTY-EIGHT (48) HOURS PRIOR TO ANY EXCAVATION WORK BEING DONE.

PLAN F-05-069 AND ENVIRONMENTAL SITE DESIGN AS SHOWN HEREON.

10. DEVIATIONS FROM THESE PLANS AND SPECIFICATIONS WITHOUT PRIOR WRITTEN

12. THE LOTS SHOWN HEREON COMPLY WITH THE MINIMUM LOT AREA AND OWNERSHIP

THESE AREAS DESIGNATE A PRIVATE SEWAGE EASEMENT OF AT LEAST 10,000 SQUARE FEET AS REQUIRED BY THE MARYLAND DEPARTMENT OF THE ENVIRONMENT FOR INDIVIDUAL SEWAGE DISPOSAL IMPROVEMENTS OF ANY NATURE I THIS AREA ARE RESTRICTED UNTIL PUBLIC SEWAGE IS AVAILABLE. THESE EASEMENTS

SHALL BECOME NULL AND VOID UPON CONNECTION TO A PUBLIC SEWAGE SYSTEM. THE COUNTY HEALTH OFFICER SHALL HAVE THE AUTHORITY TO GRANT VARIANCES FOR ENCROACHMENTS UNTO THE PRIVATE SEWAGE EASEMENT. RECORDATION OF A

14. EXISTING WELLS, SEPTIC SYSTEMS, AND SEWAGE DISPOSAL AREAS WITHIN 100' OF

THE PROPERTY AND THOSE WELLS WITHIN 200' DOWN GRADIENT OF EXISTING OR PROPOSED SEPTIC SYSTEMS OR SEWAGE DISPOSAL AREAS HAVE BEEN SHOWN.

WIDTH AS REQUIRED BY THE MARYLAND DEPARTMENT OF THE ENVIRONMENT.

CONSENT OF THE CIVIL ENGINEER (ESE) MAY CAUSE THE WORK TO BE

DISTANCES ON THIS PLAN ARE FOUND TO BE IN DISAGREEMENT.

HOWARD COUNTY STANDARDS AND SPECIFICATIONS.

REPAIRED IMMEDIATELY AT THE CONTRACTORS EXPENSE IN ACCORDANCE WITH THE

ZONING PLAN AND PER COMP-LITE ZONING REGULATIONS DATED 7/28/06.

ESE. DATED 5/10/11.

HOUSE PLANS.

F-05-D69 AND ENVIRONMENTAL SITE DESIGN SHOWN HEREON.

18. A STANDARD SEDIMENT CONTROL PLAN MAY BE USED FOR DEVELOPMENT OF THIS LOT. REFERENCE GRADING PLAN GP-14-034 DATED 10/30/13.

CO BOTTOM TRENCH TO 370.8 OT 19. THE EXISTING WELL(S) SHOWN ON THIS PLAN (IDENTIFIED WITH THE ATTACHED WELL TAG NUMBER HO-95-2464 HAS BEEN FIELD LOCATED BY ESE CONSULTANTS -PROFESSIONAL LAND SURVEYOR(S), AND IS ACCURATELY SHOWN.

River Crossing Building Setbacks (B.R.L.'s) SHOWN HEREON PER SITE DEVELOPMENT PLAN SETBACK DISTANCES SHOWN HEREON AS "±" HAVE AN ACCURACY OF ±0.1' FOOT.

ECO POD E-60., gravity Distribution
21. CULVERT FOR DRIVEWAY PER F-05-069. 8/12/201

PERCOLATION CERTIFICATION PLAN

PLOT PLAN FOR BAT INSTALLATION LOT 71

HOMEWOOD CROSSING

LIBER 9808, FOLIO 204 PLAT No. 18243 TAX No. 05-443369 FIFTH ELECTION DISTRICT HOWARD COUNTY, MARYLAND ADDRESS: 4807 RIVERCROSSING COURT ELLICOTT CITY, MARYLAND




ESE Consultants Inc. 7164 Columbia Gateway Dr. Suite 203 Columbia, MD 21046 TEL: 410-872-9105 FAX: 410-872-4870


SCALE: 1"=40" FILE: PP LOT 71_REV 2


DATE: 08/08/14 CHK'D: M.J.B


JOB NO: 1214

DRAWN: R.C.K

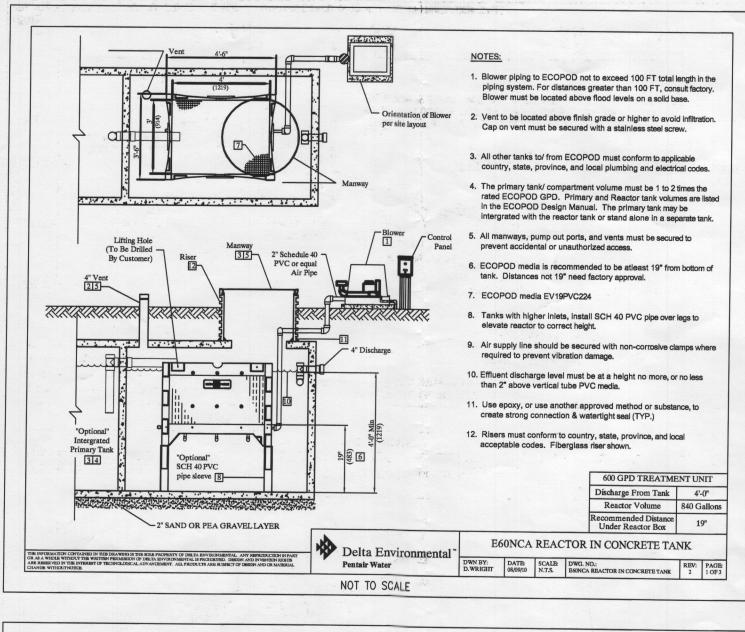

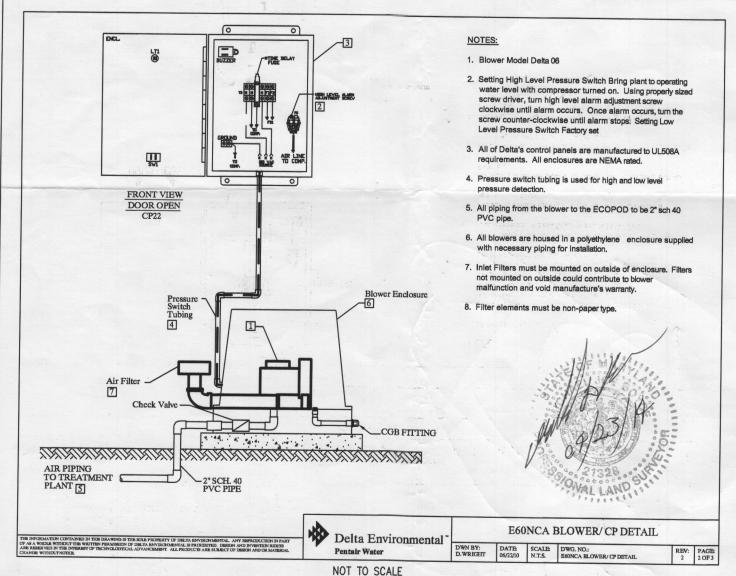

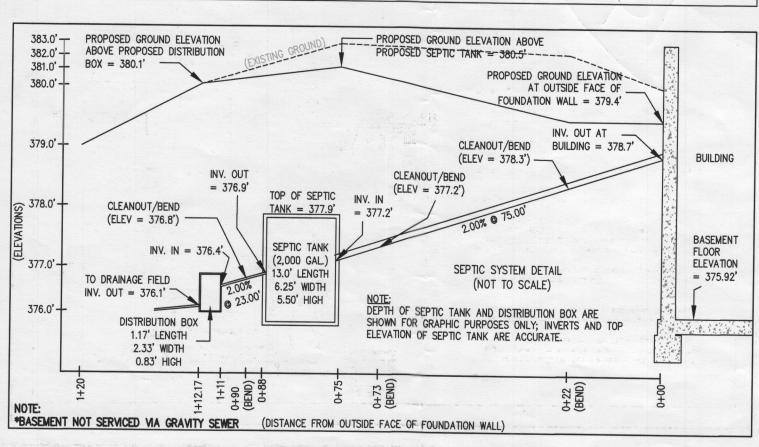

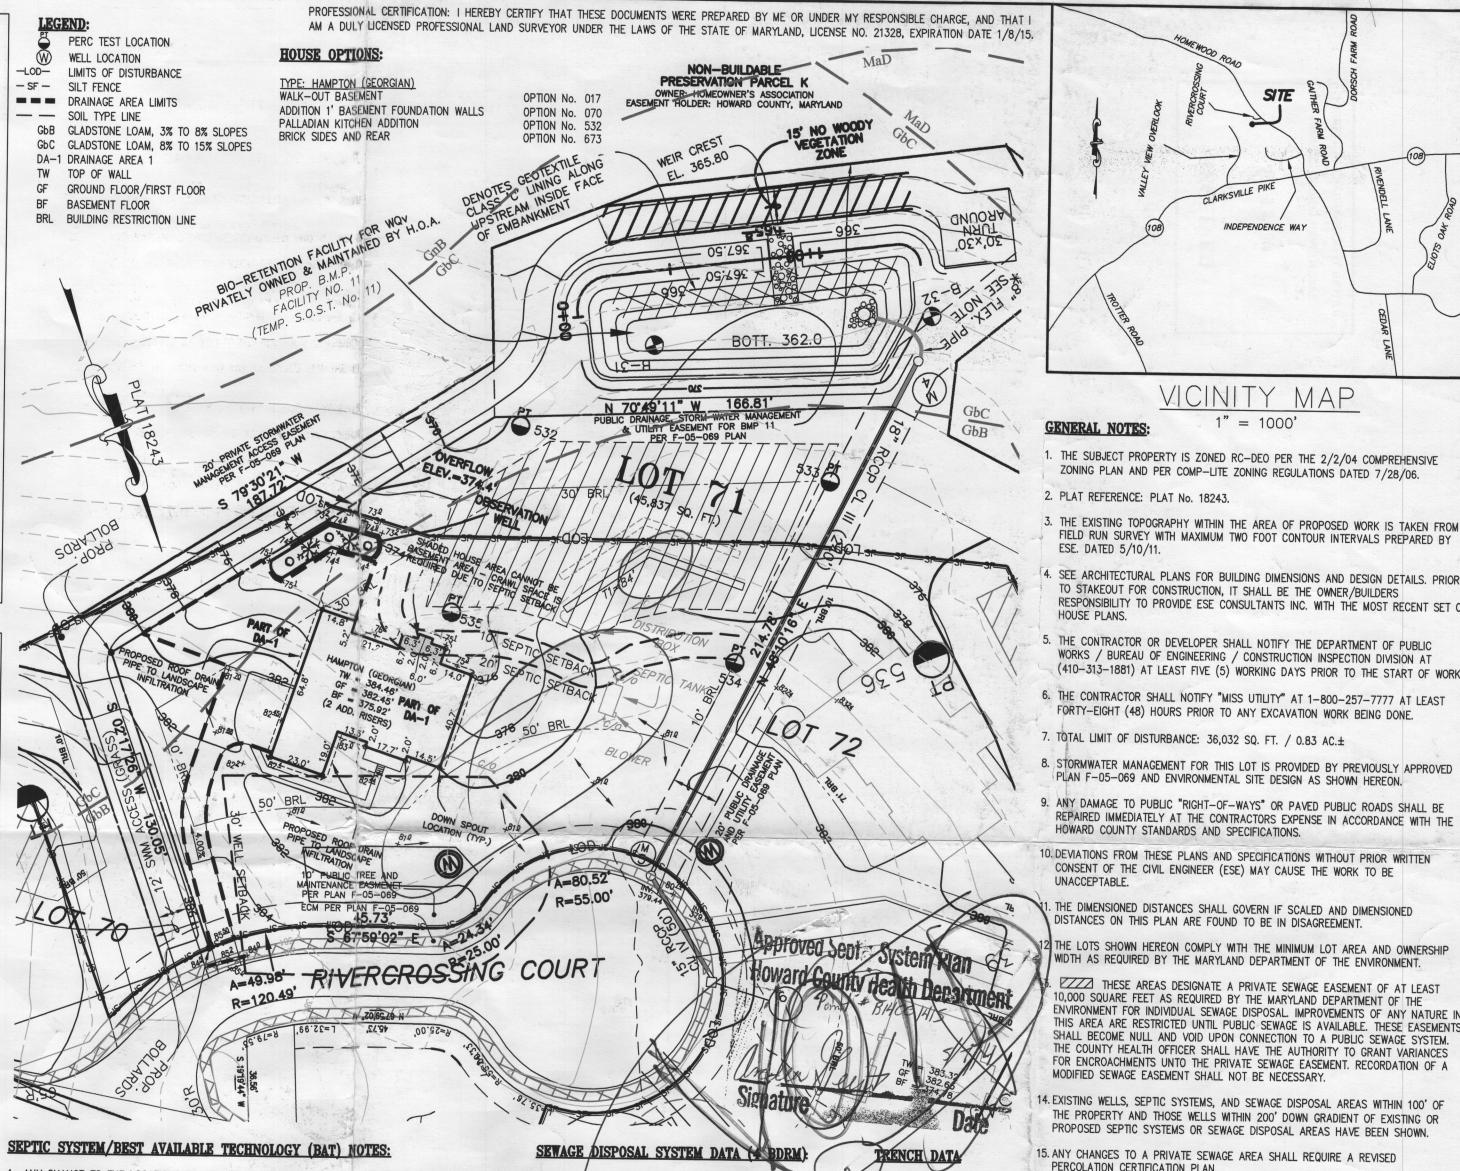

1. ANY CHANGE TO THE LOCATIONS OR DEPTHS TO ANY COMPONENTS MUST BE APPROVED BY THE ENGINEER AND THE HOWARD COUNTY HEALTH DEPARTMENT PRIOR TO INSTALLATION. A REVISED SITE PLAN MAY BE REQUIRED.

- 2. THE MAXIMUM DEPTH OF THE BAT PER THE MANUFACTURER'S SPECIFICATION IS 3 FEET COVER.
- 3. THE BLOWER MAY NOT BE LOCATED MORE THAN 100 FEET FROM THE TANK BASED ON THE MANUFACTURER'S SPECIFICATIONS.
- 4. THE BAT SYSTEM SHALL BE MAINTAINED AND OPERATED FOR THE LIFE OF THE SYSTEM.
- 5. THE BAT SHALL BE OPERATED BY AND MAINTAINED BY A CERTIFIED SERVICE PROVIDER.
- 6. WITHIN ONE MONTH OF INSTALLATION, A PERSON INSTALLING THE BAT SYSTEM SHALL REPORT TO THE MARYLAND DEPARTMENT OF THE ENVIRONMENT (MDE), IN A MANNER ACCEPTABLE TO MDE, THE ADDRESS AND DATE OF COMPLETION OF THE BAT INSTALLATION AND THE TYPE OF BAT INSTALLED.
- 7. ELECTRICAL WORK FOR THE BAT INSTALLATION MUST BE PERFORMED BY A LICENSED ELECTRICIAN.
- 8. AN AGREEMENT AND EASEMENT MUST BE COMPLETED AND SIGNED BY ALL APPLICABLE PARTIES, AND RECORDED IN THE LAND RECORDS OF HOWARD COUNTY.

9. THE HEALTH DEPARTMENT REQUIRES DOCUMENTATION FOR THE START-UP CERTIFICATION FROM THE MANUFACTURER PRIOR TO FINAL APPROVAL OF THE INSTALLATION.

PROFESSIONAL ENGINEER

APPROVED: FOR HOWARD COUNTY DEPARTMENT OF PLANNING & ZONING

CHIEF, DEVELOPMENT ENGINEERING DIVISION DATE DIRECTOR DATE

PROPOSED INVERT AT FOUNDATION WALL: 378.7' 1. E60 ECOPOD SYSTEM EX. GRADE OVER TANK: 382.9' PROPOSED GRADE OVER TANK: 380.5'

INVERT N: 377.2' INVERT OUT: 376.9'

2 DISTRIBUTION BOX EXISTING GRADE OVER TANK: 380.1 PROPOSED GRADE OVER TANK: 380.1' INVERT IN: 376.4' INVERT OUT: 376.1'

DATE

3. TRENCH DESIGN (4 BDRM x 150 GPD/BDRM = 600 GPD) 600 GPD ÷ 1.2 APP. RATE = 500 SF USE 3' MDE TRENCH WITH 48" GRAVEL BELOW PIPE 9' MIN. SPACING BETWEEN TRENCH EDGES 500 SF ÷ 3' WDTH = 166.67 LF x 0.50 = 83.34 LF MIN. TRENCH USE 1 84' LONG TRENCH = 84 LF

BOTTOM MAX. DEPTH (8')

RENCH 1 (T1): GROUND ABOVE = 378.4' MV. IN = 374.4'BOTTOM TRENCH = 370.4'

> 18. A STANDARD SEDIMENT CONTROL PLAN MAY BE USED FOR DEVELOPMENT OF THIS LOT. REFERENCE GRADING PLAN GP-14-034 DATED 10/30/13.

F-05-069 AND ENVIRONMENTAL SITE DESIGN SHOWN HEREON.

16. UPON BUILDING PERMIT REVIEW THE SEPTIC SYSTEMS FOR ALL PROPOSED

INDEPENDENCE WAY

VICINITY MAP

ZONING PLAN AND PER COMP-LITE ZONING REGULATIONS DATED 7/28/06.

FIELD RUN SURVEY WITH MAXIMUM TWO FOOT CONTOUR INTERVALS PREPARED BY

SEE ARCHITECTURAL PLANS FOR BUILDING DIMENSIONS AND DESIGN DETAILS. PRIOR

RESPONSIBILITY TO PROVIDE ESE CONSULTANTS INC. WITH THE MOST RECENT SET OF

THE CONTRACTOR OR DEVELOPER SHALL NOTIFY THE DEPARTMENT OF PUBLIC WORKS / BUREAU OF ENGINEERING / CONSTRUCTION INSPECTION DIVISION AT (410-313-1881) AT LEAST FIVE (5) WORKING DAYS PRIOR TO THE START OF WORK.

FORTY-EIGHT (48) HOURS PRIOR TO ANY EXCAVATION WORK BEING DONE.

PLAN F-05-069 AND ENVIRONMENTAL SITE DESIGN AS SHOWN HEREON.

CONSENT OF THE CIVIL ENGINEER (ESE) MAY CAUSE THE WORK TO BE

DISTANCES ON THIS PLAN ARE FOUND TO BE IN DISAGREEMENT.

MODIFIED SEWAGE EASEMENT SHALL NOT BE NECESSARY

THE DIMENSIONED DISTANCES SHALL GOVERN IF SCALED AND DIMENSIONED

HOWARD COUNTY STANDARDS AND SPECIFICATIONS.

UNACCEPTABLE.

REPAIRED IMMEDIATELY AT THE CONTRACTORS EXPENSE IN ACCORDANCE WITH THE

HE LOTS SHOWN HEREON COMPLY WITH THE MINIMUM LOT AREA AND OWNERSHIP MIDTH AS REQUIRED BY THE MARYLAND DEPARTMENT OF THE ENVIRONMENT. THESE AREAS DESIGNATE A PRIVATE SEWAGE EASEMENT OF AT LEAST 10.000 SQUARE FEET AS REQUIRED BY THE MARYLAND DEPARTMENT OF THE ENVIRONMENT FOR INDIVIDUAL SEWAGE DISPOSAL. IMPROVEMENTS OF ANY NATURE IN

THIS AREA ARE RESTRICTED UNTIL PUBLIC SEWAGE IS AVAILABLE. THESE EASEMENTS

SHALL BECOME NULL AND VOID UPON CONNECTION TO A PUBLIC SEWAGE SYSTEM. THE COUNTY HEALTH OFFICER SHALL HAVE THE AUTHORITY TO GRANT VARIANCES FOR ENCROACHMENTS UNTO THE PRIVATE SEWAGE EASEMENT. RECORDATION OF A

THE PROPERTY AND THOSE WELLS WITHIN 200' DOWN GRADIENT OF EXISTING OR PROPOSED SEPTIC SYSTEMS OR SEWAGE DISPOSAL AREAS HAVE BEEN SHOWN.

STRUCTURES AND/OR EXISTING STRUCTURE EXPANSIONS SHALL BE RE-EVALUATED

17. THE DEVELOPMENT OF THIS LOT DOES NOT REQUIRE AN ENVIRONMENTAL CONCEPT

PLAN SINCE STORMWATER MANAGEMENT WAS PREVIOUSLY APPROVED UNDER

TO STAKEOUT FOR CONSTRUCTION, IT SHALL BE THE OWNER/BUILDERS

19. THE EXISTING WELL(S) SHOWN ON THIS PLAN (IDENTIFIED WITH THE ATTACHED WELL TAG NUMBER HO-95-2464 HAS BEEN FIELD LOCATED BY ESE CONSULTANTS -PROFESSIONAL LAND SURVEYOR(S), AND IS ACCURATELY SHOWN.

20. BUILDING SETBACKS (B.R.L.'s) SHOWN HEREON PER SITE DEVELOPMENT PLAN SETBACK DISTANCES SHOWN HEREON AS "±" HAVE AN ACCURACY OF ±0.1' FOOT.

21.CULVERT FOR DRIVEWAY PER F-05-069.

PERCOLATION CERTIFICATION PLAN.

TO DETERMINE SUFFICIENT SYSTEM CAPACITY.

LOT 71

PLOT PLAN FOR BAT INSTALLATION

HOMEWOOD CROSSING

LIBER 9808, FOLIO 204 PLAT No. 18243 TAX No. 05-443369 FIFTH ELECTION DISTRICT HOWARD COUNTY, MARYLAND ADDRESS: 4807 RIVERCROSSING COURT ELLICOTT CITY, MARYLAND



Land Planning Engineering Land Surveying

ESE Consultants Inc. 7164 Columbia Gateway Dr. Suite 203 Columbia, MD 21046 TEL: 410-872-9105 FAX: 410-872-4870

DATE: 04/17/14

SCALE: 1"=40" JOB NO: 1214

FILE: PP LOT 71

CHK'D: M.J.B

DRAWN: R.C.K