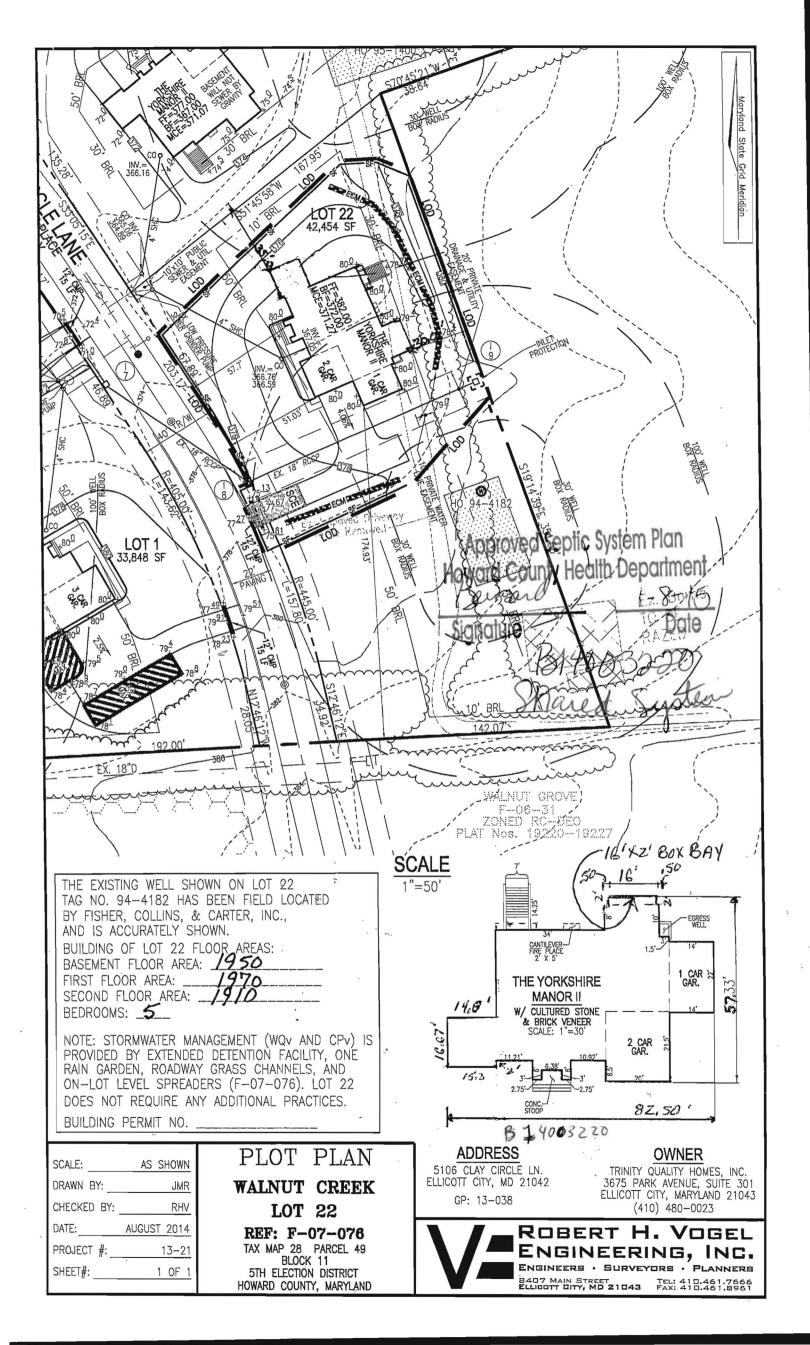


Building Permit Application
Howard County Maryland
Department of Inspections, Licenses and Permits
3430 Court House Drive
Permits: 410-313-2455
www.howardcountymd.goy

Date Received: 9 4 14

Permit No.: 31400 3220

510/- clar.					
Building Address: 5106 Clay	Circle Lane		Property Owner's Name:	rinity C	Puality homes
city: Ellicott City State:	MD Zip Code: 21	042	Address: 3675 PARK	AVE # 3	71-0-1- 21047
Suite/Apt. #SDP.			City: Chott-City s	Fax	c: Zip Code:Zip Code
Census Tract:			Email:		
Section: Area			Applicant's Name & Mailing A	Addrage (16 ath	nor thun stated basele)
Tax Map: 28 Parcel:			Applicant's Name:	Address, (if otr	ier than stated herein)
			Address:		
Zoning: RC-DED Map Coordinat	tes: 14, E & Lot Size:	: 45 4 1/P	City:	State:	Zip Code:
Existing Use: VACAN+ L	nt-		Phone:	rax:	
	01			م برگر برا	7 - Manage 1126
Proposed Use: SFD			Contractor Company: ICIA	THY GULA	CITY HOINES, INC
Estimated Construction Cost: \$ 3			Contact Person: Sherry Address: 3475 PALK	AUD #	301
Description of Work: 2 3 tory, 7	FP, 3 car garage	Full	City: 1110HCity State	e: MA	Zin Code: 21043
Basement, 9 Rooms, 4	BR'S, 4 FWI BA	iths	License No.: 699		
			Phone: 443 - 535 - 85	16 Fax:	
Occupant or Tenant:			Emall: Sherry @ tre	nityhomi	es.com
					· · · · · · · · · · · · · · · · · · ·
Was tenant space previously occupied?	□Yes	□No	Engineer/Architect Company:		
Contact Name:			. Responsible Design Prof.:		
Address:			Address:		
City:	State: Zip Code: _		CIty:Stat	:e:	Zip Code:
Phone:			Phone:		
Email:			Email:		
			citiali,		
Commercial Building Characteristics	Residential Building Cha		Utilities	(8)	
Height:	SF Dwelling SF Tow		Water Supply		
No. of stories: Gross area, sq. ft./floor:	Depth 1st floor:	Width	□ Public		
2,555 4154,154,1551	2 nd floor:		Private		
Area of construction (sq. ft.):	Basement:		Sewage Disposa	<u> </u>	
Use seems	Finished Basement		Public		
Use group:	☐ Unfinished Basement ☐ Crawl Space		Private	7.0.	
			Electric: VZ Yes [No	,
Construction type:	Slab on Grade		C FRY F		
☐ Reinforced Concrete	No. of Bedrooms: 4] No	
☐ Reinforced Concrete ☐ Structural Steel	No. of Bedrooms: 4 Multi-family Dwe	elling	Heating System] No	
☐ Reinforced Concrete ☐ Structural Steel ☐ Masonry	No. of Bedrooms: 4 Multi-family Dwe No. of efficiency units:	eliing	Heating System ✓ Electric ☐ Oil	No	
☐ Reinforced Concrete ☐ Structural Steel	No. of Bedrooms: 4 Multi-family Dwe	eiling	Heatina System ✓ Electric □ Oil ✓ Natural Gas □ Propane	No	
☐ Reinforced Concrete ☐ Structural Steel ☐ Masonry ☐ Wood Frame	No. of Bedrooms: 4 Multi-family Dwe No. of efficiency units: No. of 1 BR units:	eiling	Heating System ✓ Electric ☐ Oil	No	
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☐ Reinforced Concrete ☐ Structural Steel ☐ Masonry ☐ Wood Frame ☐ State Certified Modular	No. of Bedrooms: 4 Multi-family Dwe No. of efficiency units: No. of 1 BR units: No. of 2 BR units: No. of 3 BR units: Other Structure: Dimensions:	<u>eilina</u>	Heating System ✓ Electric ☐ Oil ✓ Natural Gas ☐ Propane ☐ Other: Sprinkler System	No	
☐ Reinforced Concrete ☐ Structural Steel ☐ Masonry ☐ Wood Frame	No. of Bedrooms: 4 Multi-family Dwe No. of efficiency units: No. of 1 BR units: No. of 2 BR units: No. of 3 BR units: Other Structure:	elling	Heating System Electric OII Natural Gas Propane Other: Sprinkler System No	No l. e Gas	G1300028
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☐ Reinforced Concrete ☐ Structural Steel ☐ Masonry ☐ Wood Frame ☐ State Certified Modular ➤ Roadside Tree Project Permit ☐ Yes ズブNo	No. of Bedrooms: 4 Multi-family Dwe No. of efficiency units: No. of 1 BR units: No. of 2 BR units: No. of 3 BR units: Other Structure: Dimensions: Footings: Roof:		Heating System Electric OII Natural Gas Propane Other: Sprinkler System No	No L Gas L L init Number:	G1300028
☐ Reinforced Concrete ☐ Structural Steel ☐ Masonry ☐ Wood Frame ☐ State Certified Modular ➤ Roadside Tree Project Permit ☐ Yes ☐ No Roadside Tree Project Permit #	No. of Bedrooms: 4 Multi-family Dwe No. of efficiency units: No. of 1 BR units: No. of 2 BR units: No. of 3 BR units: Other Structure: Dimensions: Footings: Roof: State Certified Modulation Manufactured Home	ar	Heating System Electric	No le Gas li li nit Number: t	•
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COMPLETE THIS FORM WHEN DROPPING OFF ANY CORRESPONDENCE AND/OR PLANS TO THE HOWARD COUNTY DEPARTMENT OF INSPECTIONS, LICENSES AND PERMITS COUNTER:


DEI	ARTIMENT OF INSTECTIONS, LICENSES AND I ERMITS COUNTER.
Date:	12/12/14
То:	(Person's Name and Division)
From:	(Your Name, Company Name and Telephone Number)
Subject	
	Project site address 5106 Clay Circle Lune Ellicott City MD
	Permit # <u>B14003200</u> SDP# 60 13.038
	Other information pertinent to this project
✓ Pleas	se check the attachments below that you are submitting with this transmittal:
	Letter of response to address plan review comment letter
	Revised plans and/or revised details: When submitting for a complete re-review, duplicate sets shall be submitted.
	Letter Summarizing Changes
	Energy conservation calculations
	Copies of $GP / 3 \cdot O3 \cdot B$ (be specific).
	Health Department Request DPZ/ DED Request Applicant's Request
	Two sets of single family dwelling model plans to be placed on permanent file: Model name and/or #
	Other
	Contact Person Information: (Required)
	Please Print Name Telephone No: 443-338-6698 E-Mail Address: Sherry & Frim by homes.
NECE INFOR OF IN ONCE SIGNA WILL INQU	SE ASSURE ALL DOCUMENTS AND/OR REVISIONS ARE APPROPRIATELY SIGNED AND SEALED, IF SSARY, BY A LICENSED ARCHITECT OR ENGINEER. PLEASE BE ADVISED THAT INSUFFICIENT RMATION MAY RESULT IN THE DELAY OF REVIEW BY THE PLANS EXAMINER. THE DEPARTMENT IS PECTIONS, LICENSES AND PERMITS WILL CONTACT YOU IF THERE IS A PROBLEM. IN ADDITION, IT THE BUILDING PERMIT IS APPROVED BY THE PLAN REVIEW DIVISION AND ALL OTHER REQUIRED ATORY AGENCIES, AND THE BUILDING PERMIT IS READY FOR ISSUANCE, THE PERMIT DIVISION NOTIFY THE APPROPRIATE CONTACT PERSON FOR PERMIT PICK UP. ALL PERMIT STATUS IRIES SHALL BE DIRECTED TO THE PERMIT DIVISION AT 410-313-2455. CODE RELATED QUESTIONS PLAN REVIEW INQUIRIES SHALL BE DIRECTED TO THE PLAN REVIEW DIVISION AT 410-313-2436.


PLEASE ALLOW A MINIMUM OF FIVE (5) WORKING DAYS FOR ANY PLAN SUBMITTALS TO BE REVIEWED.

PERMIT ISSUED

Received by

THANK YOU.

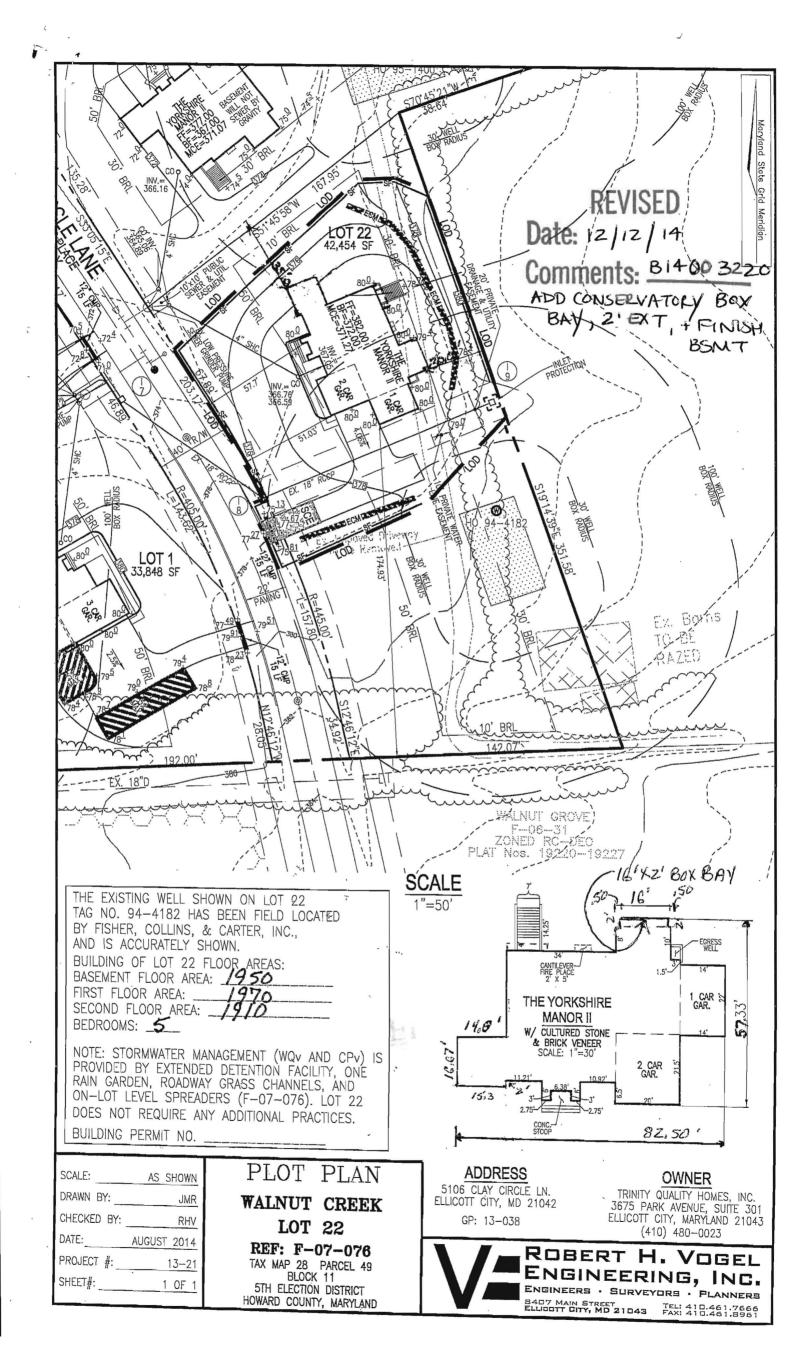


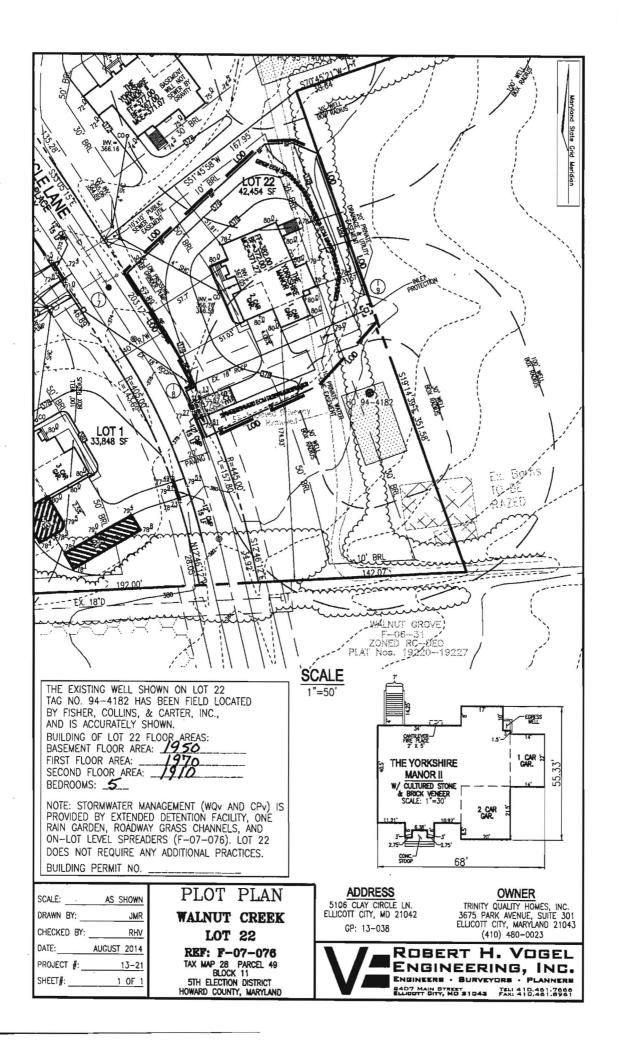

HOWARD COUNTY DEPARTMENT OF INSPECTIONS, LICENSES & PERMITS


permit:	on is nereby granted by the Howard County Department of Inspections, Licenses & Permits for an entrance
	TRINITY QUALITY HOMES Phone 443-535 8516
Address	3675 PARKAUE #301 Ellicott City MO. 21043
New Bui	ilding Address 5106 CLAY CIRCLE LANE EILICOH CITY, MB. 2104
	t use: Entrance To
Name of	Contractor or Builder TRINITY QUALITY HOMES
	3675 PARK AVE #301 Ellicoff City MO. 21043
(3) that the with all	The applicant hereby certifies and agrees as follows: (1) that he is the owner or the duly authorized agent of er to make this application; (2) that he has read all of the information set forth and that the same is correct; the permit, when issued, may be declared void should said information be incorrect; (4) that he will comply rules and regulations of Howard County Bureau of Highways; (5) that he will perform no work on the not specifically described in this permit.
Highway	It must be noted that a use & occupancy permit will not be issued until entrance is completed to Bureau of ys Standards & Specifications.
	It is agreed and understood by the acceptance of this permit, the following conditions will be followed.
A.	The construction of the entrance or approach will, in no way, change the grade/and or alignment of any existing drainage ditches or structures. In the event same are damaged or destroyed, they shall be replaced to the satisfaction of the Howard County Department of Public Works representative.
В.	The right-of-way, affected by this permit, will be left in a neat and clean condition and no excess material will be permitted to remain on or adjacent to the right-of-way. Shoulders and flow-line areas disturbed shall be shaped up according to the Howard County Bureau of Highways Standards and Specifications. (For Driveway and Flow-line area.)
	In consideration of the issuance of this permit, the applicant agrees that if he fails to with the above set-out standards and thereby causes damage to the Howard County Road a, that the applicant will be responsible to Howard County for such damage to its road.
Sign_	Shey mewhaw
Addres	(Name of applicant) 83675 PALL AVE #301 Ellicoff City MO. 21043
Date _	9 4 14 Approved

ATTENTION: The permit, when issued, is valid for period not to exceed six months.

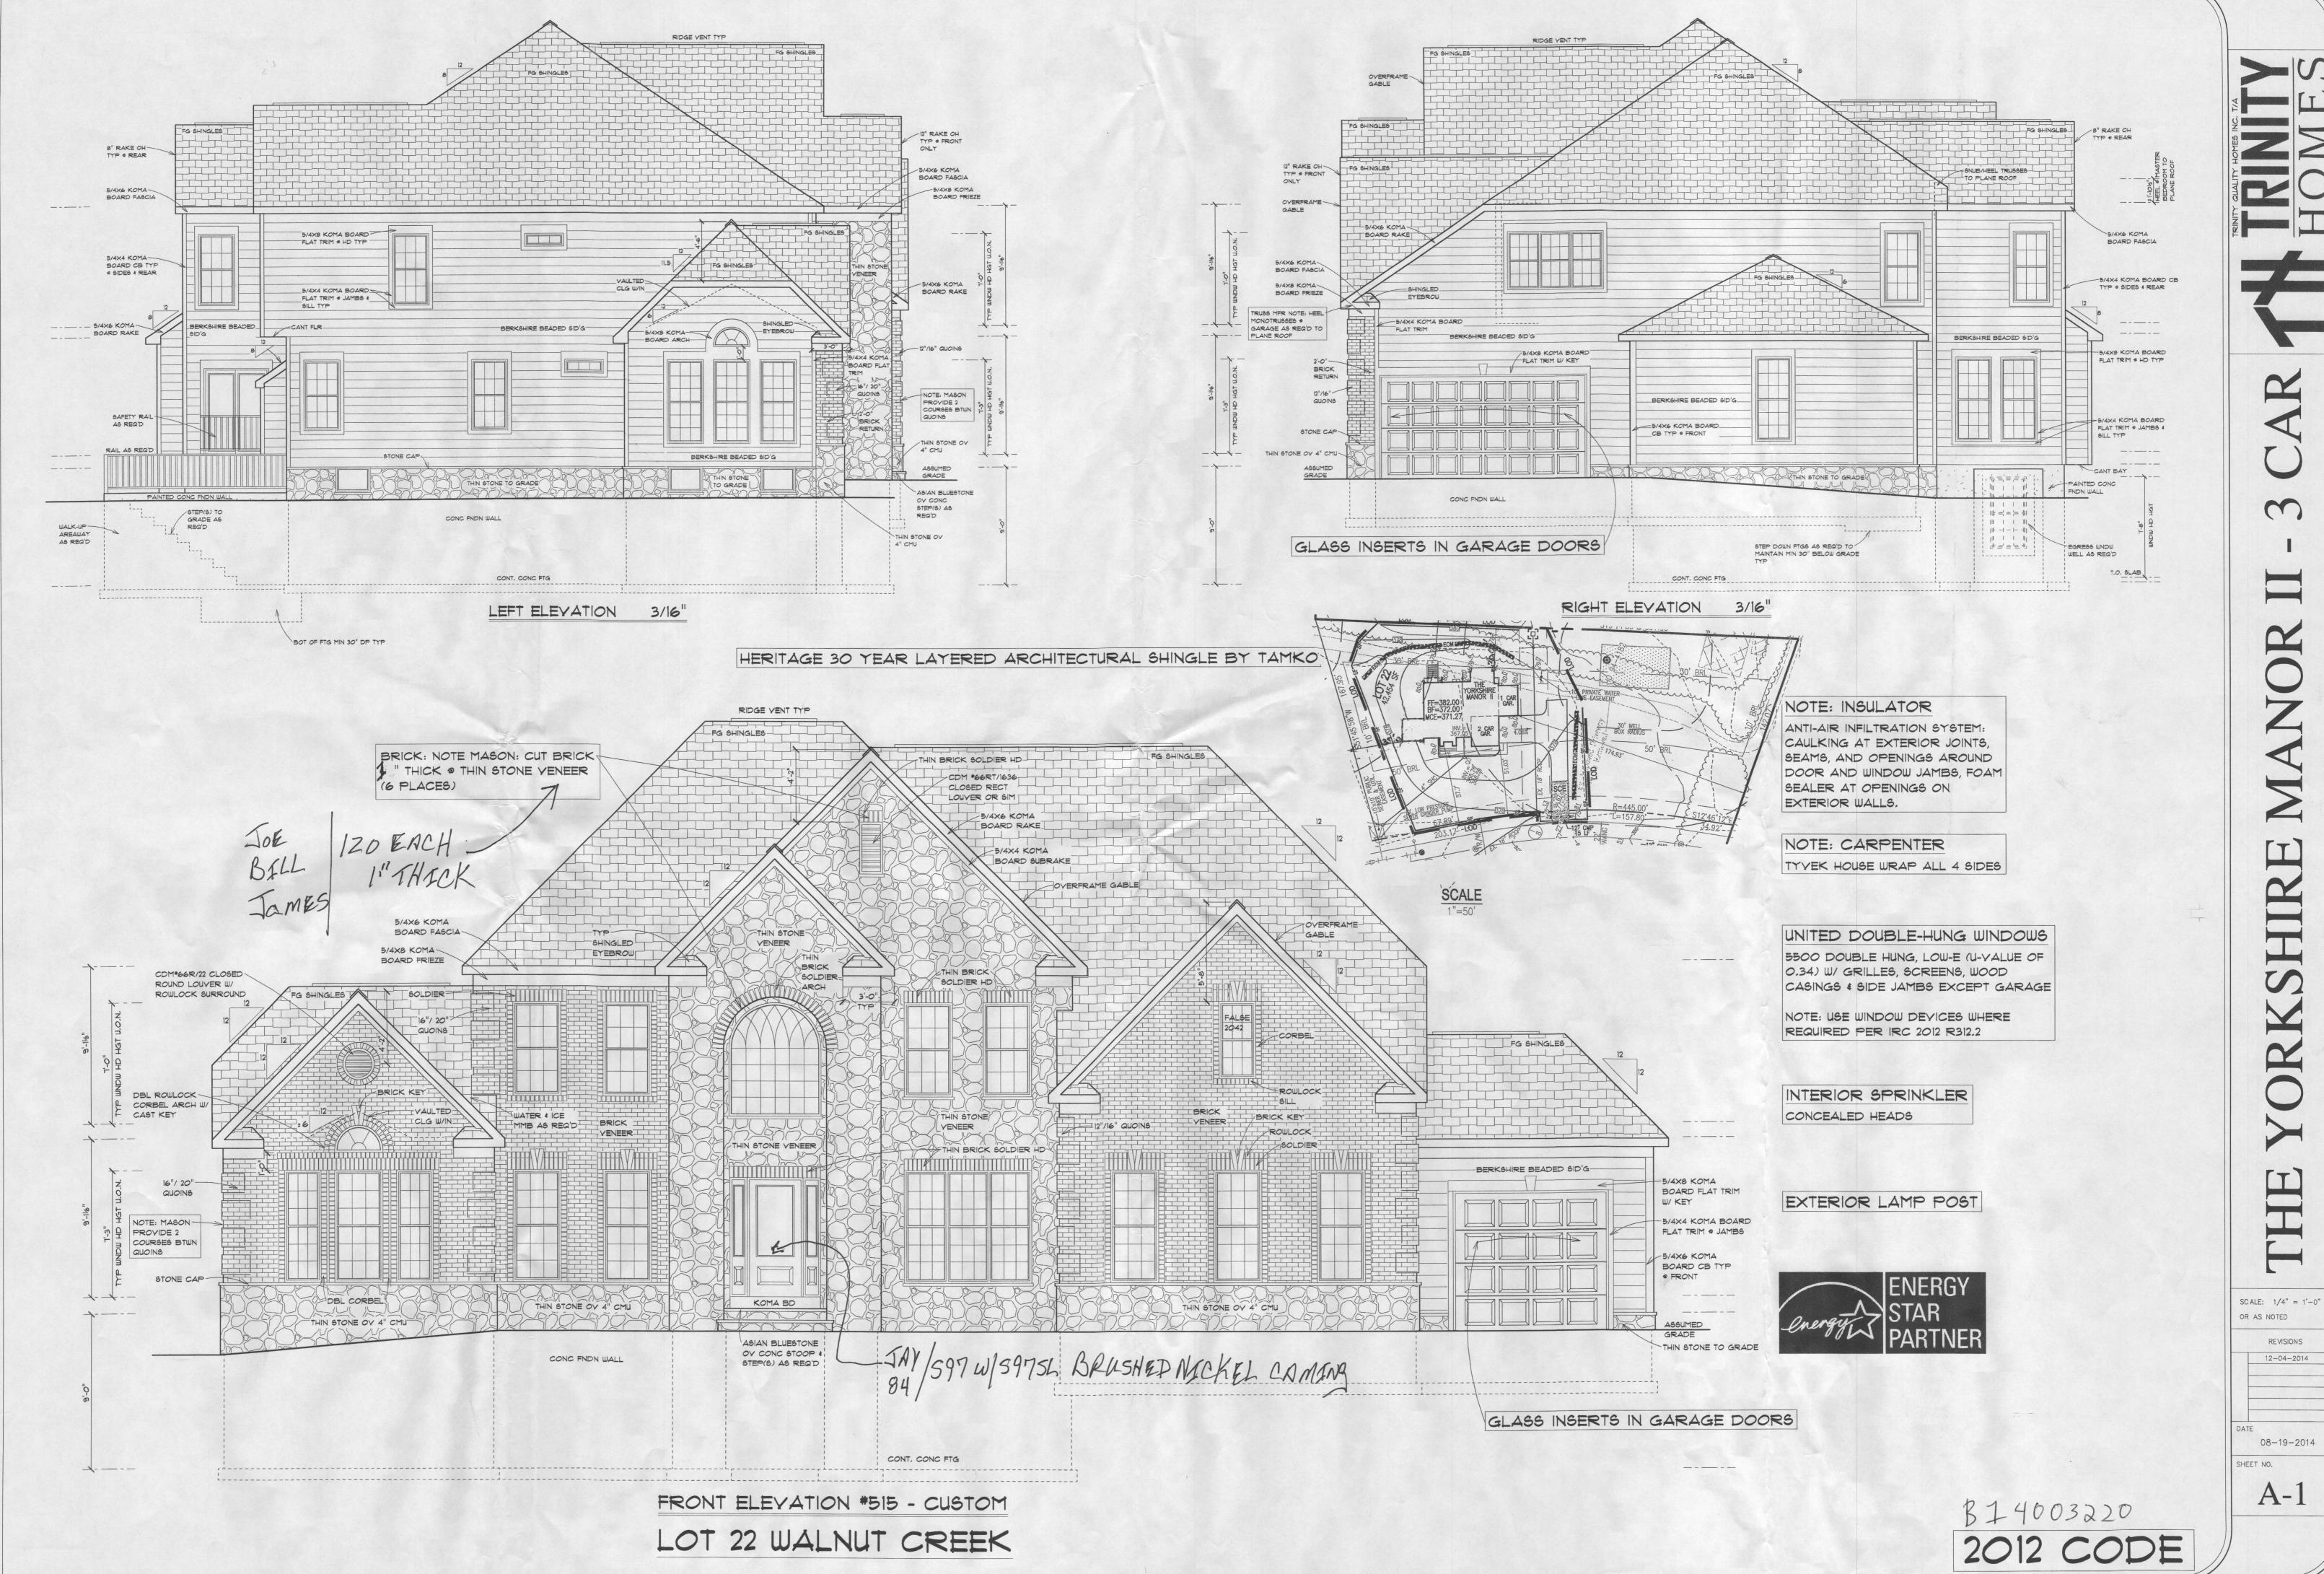

RIDGE VENT TYP -PROVIDE ADD'L ROOF VENT'G (3) SNUB/HEEL TRUSSES TO PLANE ROOF BERKSHIRE BEADED SID'G FG SHINGLES 5/4X8 KOMA BOARD FLAT TRIM . JAMBS FG SHINGLES BERKSHIRE BEADED SID'G___ TYP & SIDES & REAR STONE BEYOND BERKSHIRE BEADED SID'G RAIL AS REQ'D -STONE CAP STONE TO GRADE THIN STONE TO GRADE PAINTED CONC FNDN WALL PAINTED CONG FNDN WALL EGRESS WNDW WELL AS REQ'D CONT. CONC FTG

REAR ELEVATION 3/16"

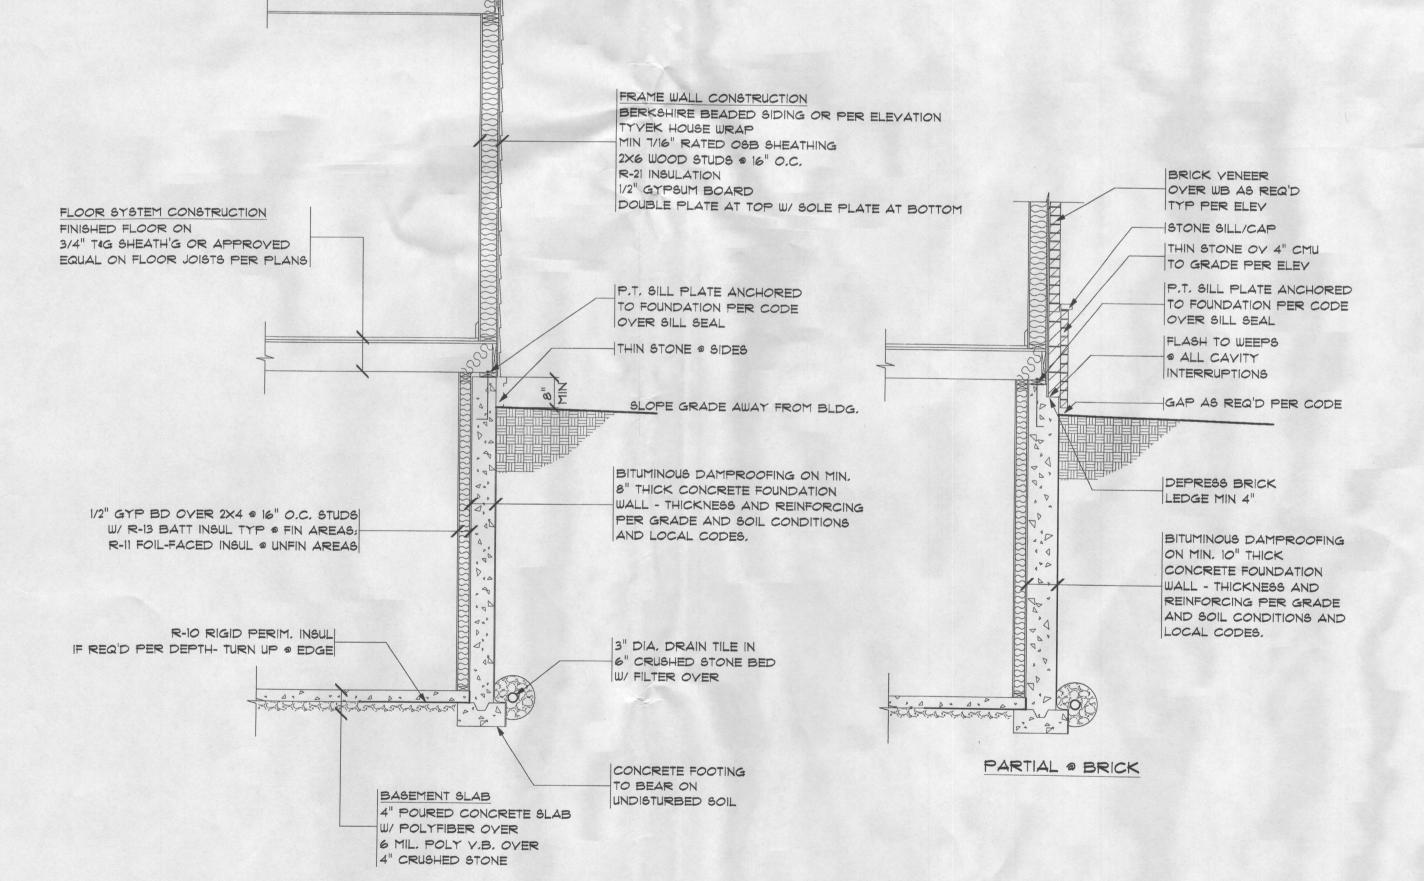

FRAME WALL SECTION

SCALE: N.T.S.

FIBRGLS SHINGLES ON

15* ROOFING FELT ON

R-50 ATTIC INSULATION

WITH BAFFLES AS REQ'D

7/16" OSB RATED SHEATHING

ON APPROVED ROOF TRUSSES

42× SUB-FASCIA

"II" O'HG TYP

HEEL UP TURNED GABLES AS REQ'D TO ALIGN FASCIAS

CONTIN VENTED SOFFIT, FASCIA BOARD, GUTTER & D.S. - PER CONTRACT SPECS.

IECC 2012 ENERGY CODE COMPLIANCE REQUIREMENTS

THE BUILDING SHALL CONFORM TO THE FOLLOWING MANDATORY REQUIREMENTS PER THE 2012 INTERNATIONAL ENERGY

CONSERVATION CODE:	
COMPLIANCE CERTIFICATE	A PERMANENT CERTIFICATE APPROVED BY THE LOCAL JURISDICTION DESCRIBING THE R-VALUES, U-FACTORS, AND SHGC OF THE BUILDING COMPONENTS AND BUILDING AIR LEAKAGE TEST RESULTS SHALL BE AFFIXED TO THE ELECTRICAL DISTRIBUTION PANEL OR ANOTHER LOCATION APPROVED BY THE LOCAL JURISDICTION, PER IECC R401.3 (IRC NIIO1.16).
AIR LEAKAGE	ALL NEW CONSTRUCTION BUILDINGS SHALL BE CONSTRUCTED TO LIMIT THE THERMAL ENVELOPE AIR LEAKAGE TO 3 AIR CHANGES PER HOUR AT 50 PASCALS OF PRESSURE AND TESTED VIA A BLOWER DOOR TEST PER IECC R402.4 (IRC NIIO2.4).
MAXIMUM FENESTRATION U-FACTOR AND SHGC	THE MAXIMUM U-FACTOR ALLOWED USING EITHER THE TOTAL UA ALTERNATIVE METHOD PER IECC R402.1.4 (IRC NII02.1.4) OR THE SIMULATED PERFORMANCE ALTERNATIVE PER IECC R405 (IRC NII05) SHALL BE 0.48 FOR VERTICAL FENESTRATION AND 0.75 FOR SKYLIGHTS PER IECC R402.5 (IRC NII02.5).
HVAC CONTROLS	EACH HEATING AND COOLING SYSTEM SHALL HAVE AT LEAST ONE THERMOSTAT PER IECC R403.1 (IRC N1103.1). IF THE PRIMARY HEATING SYSTEM IS A FORCED AIR FURNACE, A PROGRAMMABLE THERMOSTAT SHALL BE PROVIDED PER IECC R403.1.1 (IRC N1103.1.1).
HEAT PUMP SUPPLEMENTARY HEAT	HEAT PUMPS WITH SUPPLEMENTARY ELECTRIC RESISTANCE HEAT SHALL HAVE CONTROLS THAT, EXCEPT DURING DEFROST, PREVENT SUPPLEMENTAL HEAT FROM OPERATING WHEN THE HEAT PUMP COMPRESSOR CAN MEET THE HEATING LOAD PER IECC R403.1.2 (IRC N1103.1.2).
DUCT SEALING	ALL DUCTS, AIR HANDLERS, AND FILTER BOXES SHALL BE SEALED PER IRC MIGO1.4.1. DUCT TIGHTNESS SHALL BE VERIFIED BY EITHER A ROUGH-IN OR POSTCONSTRUCTION TEST PER IECC R403.2.2 (IRC NIIO3.2.2) UNLESS DUCTS AND AIR HANDLERS ARE LOCATED ENTIRELY WITHIN THE BUILDING THERMAL ENVELOPE.
BUILDING CAVITIES AS DUCTS OR PLENUMS	BUILDING FRAMING CAVITIES SHALL NOT BE USED AS DUCTS OR PLENUMS PER IECC R403.2.3 (IRC NIIO3.2.3).
MECHANICAL SYSTEM PIPING INSULATION	MECHANICAL SYSTEM PIPING CAPABLE OF CARRYING FLUIDS ABOVE 105°F OR BELOW 55°F SHALL BE INSULATED TO R-3 MINIMUM PER IECC R403.3 (IRC NII03.3), PIPING INSULATION EXPOSED TO WEATHER SHALL BE PROTECTED FROM DEGRADATION AND DECAY PER IECC R403.3.1 (IRC NII03.3.1),
CIRCULATING HOT WATER SYSTEMS	CIRCULATING HOT WATER SYSTEMS SHALL BE PROVIDED WITH AN AUTOMATIC OR READILY ACCESSIBLE MANUAL SWITCH TO TURN OFF THE CIRCULATING PUMP WHEN THE SYSTEM IS NOT IN USE PER IECC R403.4.1 (IRC NII03.4.1).
MECHANICAL VENTILATION	THE BUILDING SHALL BE PROVIDED WITH VENTILATION PER IRC MISOT OR OTHER APPROVED MEANS OF VENTILATION PER IECC R403.5 (IRC NII03.5), WHOLE-HOUSE VENTILATION FANS SHALL MEET EFFICIENCY STANDARDS PER IECC TABLE R403.5.1 (IRC TABLE NII03.5.1).
EQUIPMENT SIZING	HEATING AND COOLING EQUIPMENT SHALL BE SIZED IN ACCORDANCE WITH ACCA MANUAL S BASED ON BUILDING LOADS CALCULATED IN ACCORDANCE WITH ACCA MANUAL J OR OTHER APPROVED HEATING AND COOLING CALCULATION METHODOLOGIES PER IECC R403.6 (IRC N1103.6).
SYSTEMS SERVING MULTIPLE DWELLING UNITS	SYSTEMS SERVING MULTIPLE DWELLING UNITS SHALL CONFORM TO IECC SECTIONS C403 AND C404.
SNOW MELT SYSTEMS CONTROLS	SNOW AND ICE MELT SYSTEMS SUPPLIED THROUGH ENERGY SERVICE TO THE BUILDING SHALL INCLUDE AUTOMATIC CONTROLS

CAPABLE OF SHUTTING OFF THE SYSTEM WHEN THE PAVEMENT TEMPERATURE IS ABOVE 50°F AND NO PRECIPITATION IS FALLING, AND AUTOMATIC OR MANUAL CONTROLS CAPABLE OF SHUTTING OFF THE SYSTEM WHEN THE OUTDOOR TEMPERATURE IS ABOVE 40°F PER IECC R403.8 (IRC NII03.8).

POOLS AND INGROUND POOLS AND INGROUND SPA HEATERS SHALL HAVE AN ACCESSIBLE ON-OFF SWITCH MOUNTED ON THE OUTSIDE OF THE HEATER PERMANENTLY INSTALLED SPAS THAT ALLOWS SHUT-OFF WITHOUT AFFECTING THE THERMOSTAT SETTING PER IECC R403.9.1 (IRC N1103.9.1); GAS-FIRED HEATERS SHALL NOT HAVE CONSTANT BURNING PILOT LIGHTS, HEATERS SHALL HAVE TIME SWITCHES OR OTHER CONTROL METHODS TO AUTOMATICALLY TURN ON AND OFF PER A PRESET SCHEDULE PER IECC R403.9.2 (IRC NII03.9.2), HEATED POOLS AND INGROUND SPAS SHALL BE PROVIDED WITH A VAPOR-RETARDANT COVER PER IECC R403.9.3 (IRC NIIO3.9.3). A MINIMUM OF 15% OF THE LAMPS IN PERMANENTLY INSTALLED LIGHTING FIXTURES SHALL BE HIGH-EFFICACY LAMPS OR A MINIMUM OF 15% OF THE PERMANENTLY INSTALLED LIGHTING FIXTURES SHALL CONTAIN ONLY HIGH-EFFICACY LAMPS PER IECC

R404.1 (IRC N1104.1). FUEL GAS LIGHTING EQUIPMENT FUEL GAS SYSTEMS SHALL NOT HAVE CONTINUOUSLY BURNING PILOT LIGHT SYSTEMS PER IECC R404.1.1 (IRC N1104.1.1).

LIGHTING EQUIPMENT

PRESCRIPTIVE R-VALUE COMPLIANCE PATH

THE BUILDING SHALL ALSO CONFORM TO ONE OF THE FOLLOWING

. PRESCRIPTIVE

THE BUILDING CONFORMS TO THE PRESCRIPTIVE REQUIREMENTS DETAILED IN THE CHART BELOW PER IECC R402.1.1 & R402.1.2 (IRC NII02.1.1 & NII02.1.2), EQUIVALENT U-FACTORS MAY BE SUBSTITUTED FOR REQUIRED R-VALUES PER IECC R402.1.3 (IRC NIIO2.1.3). THE BUILDING SHALL ALSO CONFORM TO THE DETAILED REQUIREMENTS OF

COMPONENT	REQUIRED VALUE
CEILING/ROOF	R-49 (COMPRESSED OVER WALL TOP PLATE AT EAVES) OR R-38 (UNCOMPRESSED OVER WALL TOP PLATE AT EAVES)
WALLS	R-20 CAVITY OR R-13 CAVITY PLUS R-5 CONTINUOUS
BASEMENT WALLS	R-10 CONTINUOUS OR R-13 CAVITY
SLAB	R-10, 2' DEPTH
CRAWL SPACE: WALL	R-10 CONTINUOUS OR R-13 CAVITY
or FLOOR	R-19
DUCTS OUTSIDE	R-8 FOR SUPPLY DUCTS IN ATTICS R-6 FOR ALL OTHER DUCTS
HOT WATER PIPES	R-3 UNLESS OTHERWISE ALLOWED BY IECC R403.4.2 (IRC N1103.4.2)
FENESTRATION	U-FACTOR = 0.35 MAX: SHGC = 0.40 MAX
SKYLIGHTS	U-FACTOR = 0.55 MAX; SHGC = 0.40 MAX

2. TOTAL UA ALTERNATIVE

THE BUILDING THERMAL ENVELOPE'S TOTAL UA, CALCULATED PER THE ASHRAE HANDBOOK OF FUNDAMENTALS, IS LESS THAN OR EQUAL TO THE TOTAL UA OF AN EQUIVALENT BULDING BUILT TO THE PRESCRIPTIVE REQUIREMENTS LISTED ABOVE, PER IECC R402.1.4 (IRC NIIO2.1.4), PRESCRIPTIVE SHGC REQUIREMENTS LISTED ABOVE SHALL BE MET.

3. SIMULATED PERFORMANCE ALTERNATIVE A BUILDING ENERGY PERFORMANCE ANALYSIS IS PERFORMED PER IECC R405 (IRC NIIO5) USING SOFTWARE APPROVED BY THE BUILDING OFFICIAL.


SC ALE: 1/4" = 1'-0"OR AS NOTED REVISIONS 12-04-2014

> 08-19-2014 SHEET NO.

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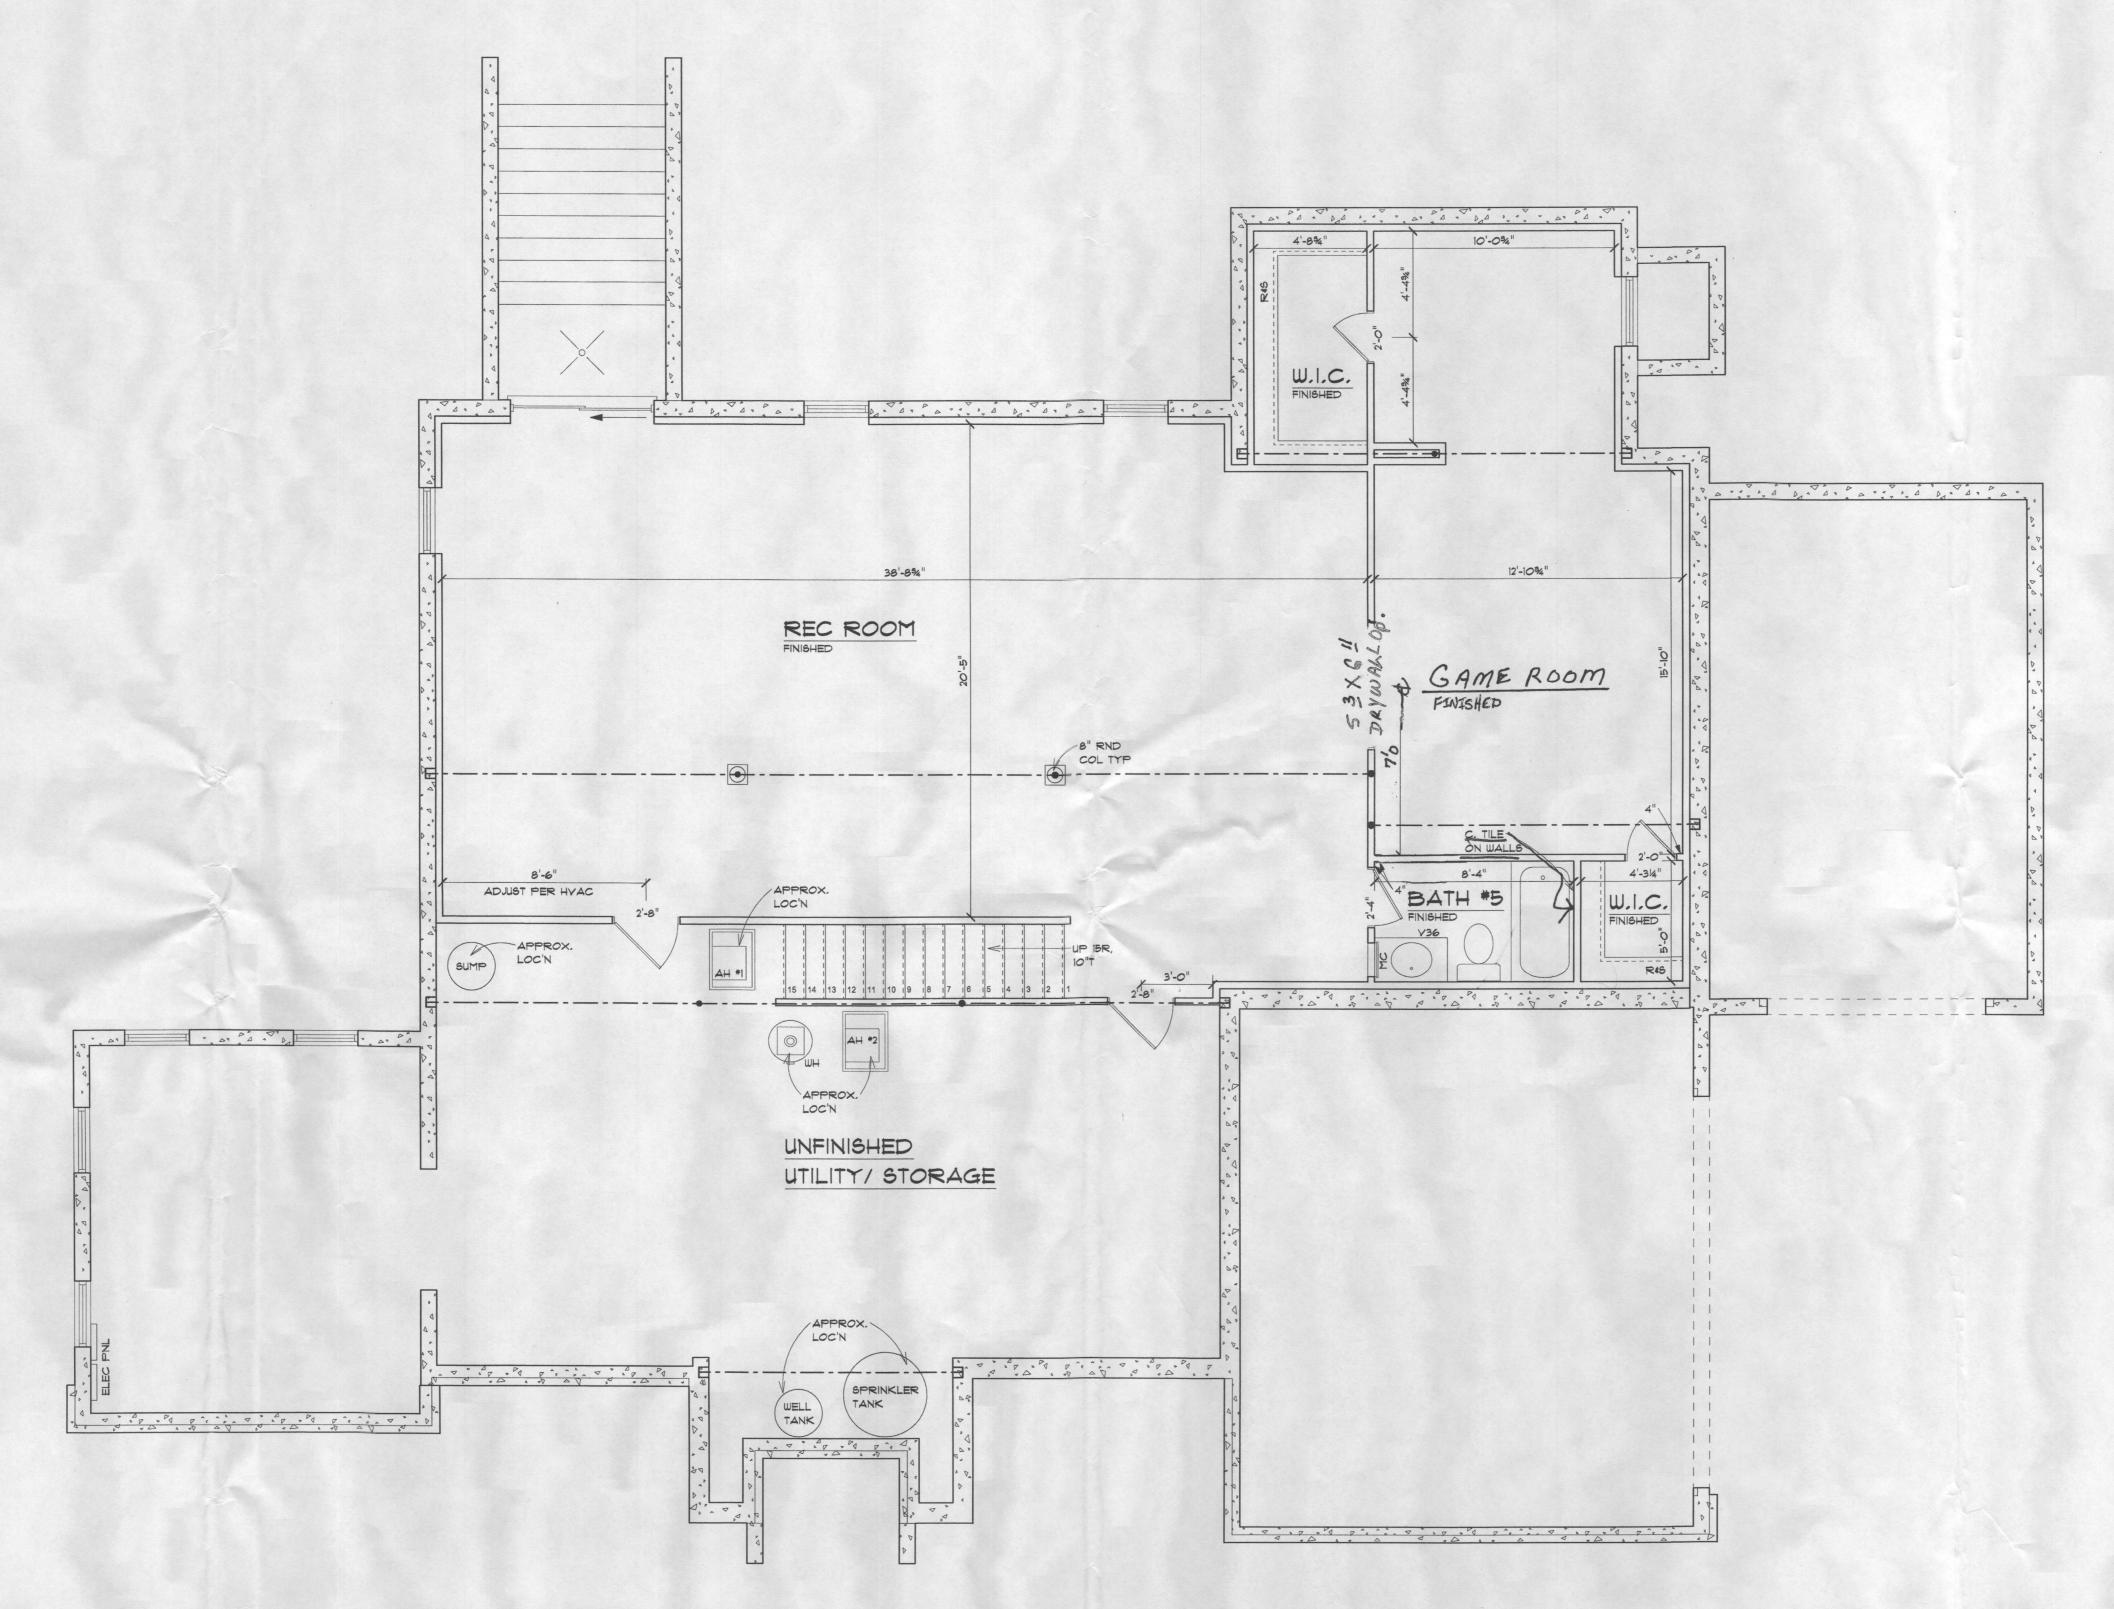
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REVISIONS



NOTE: PLUMBER

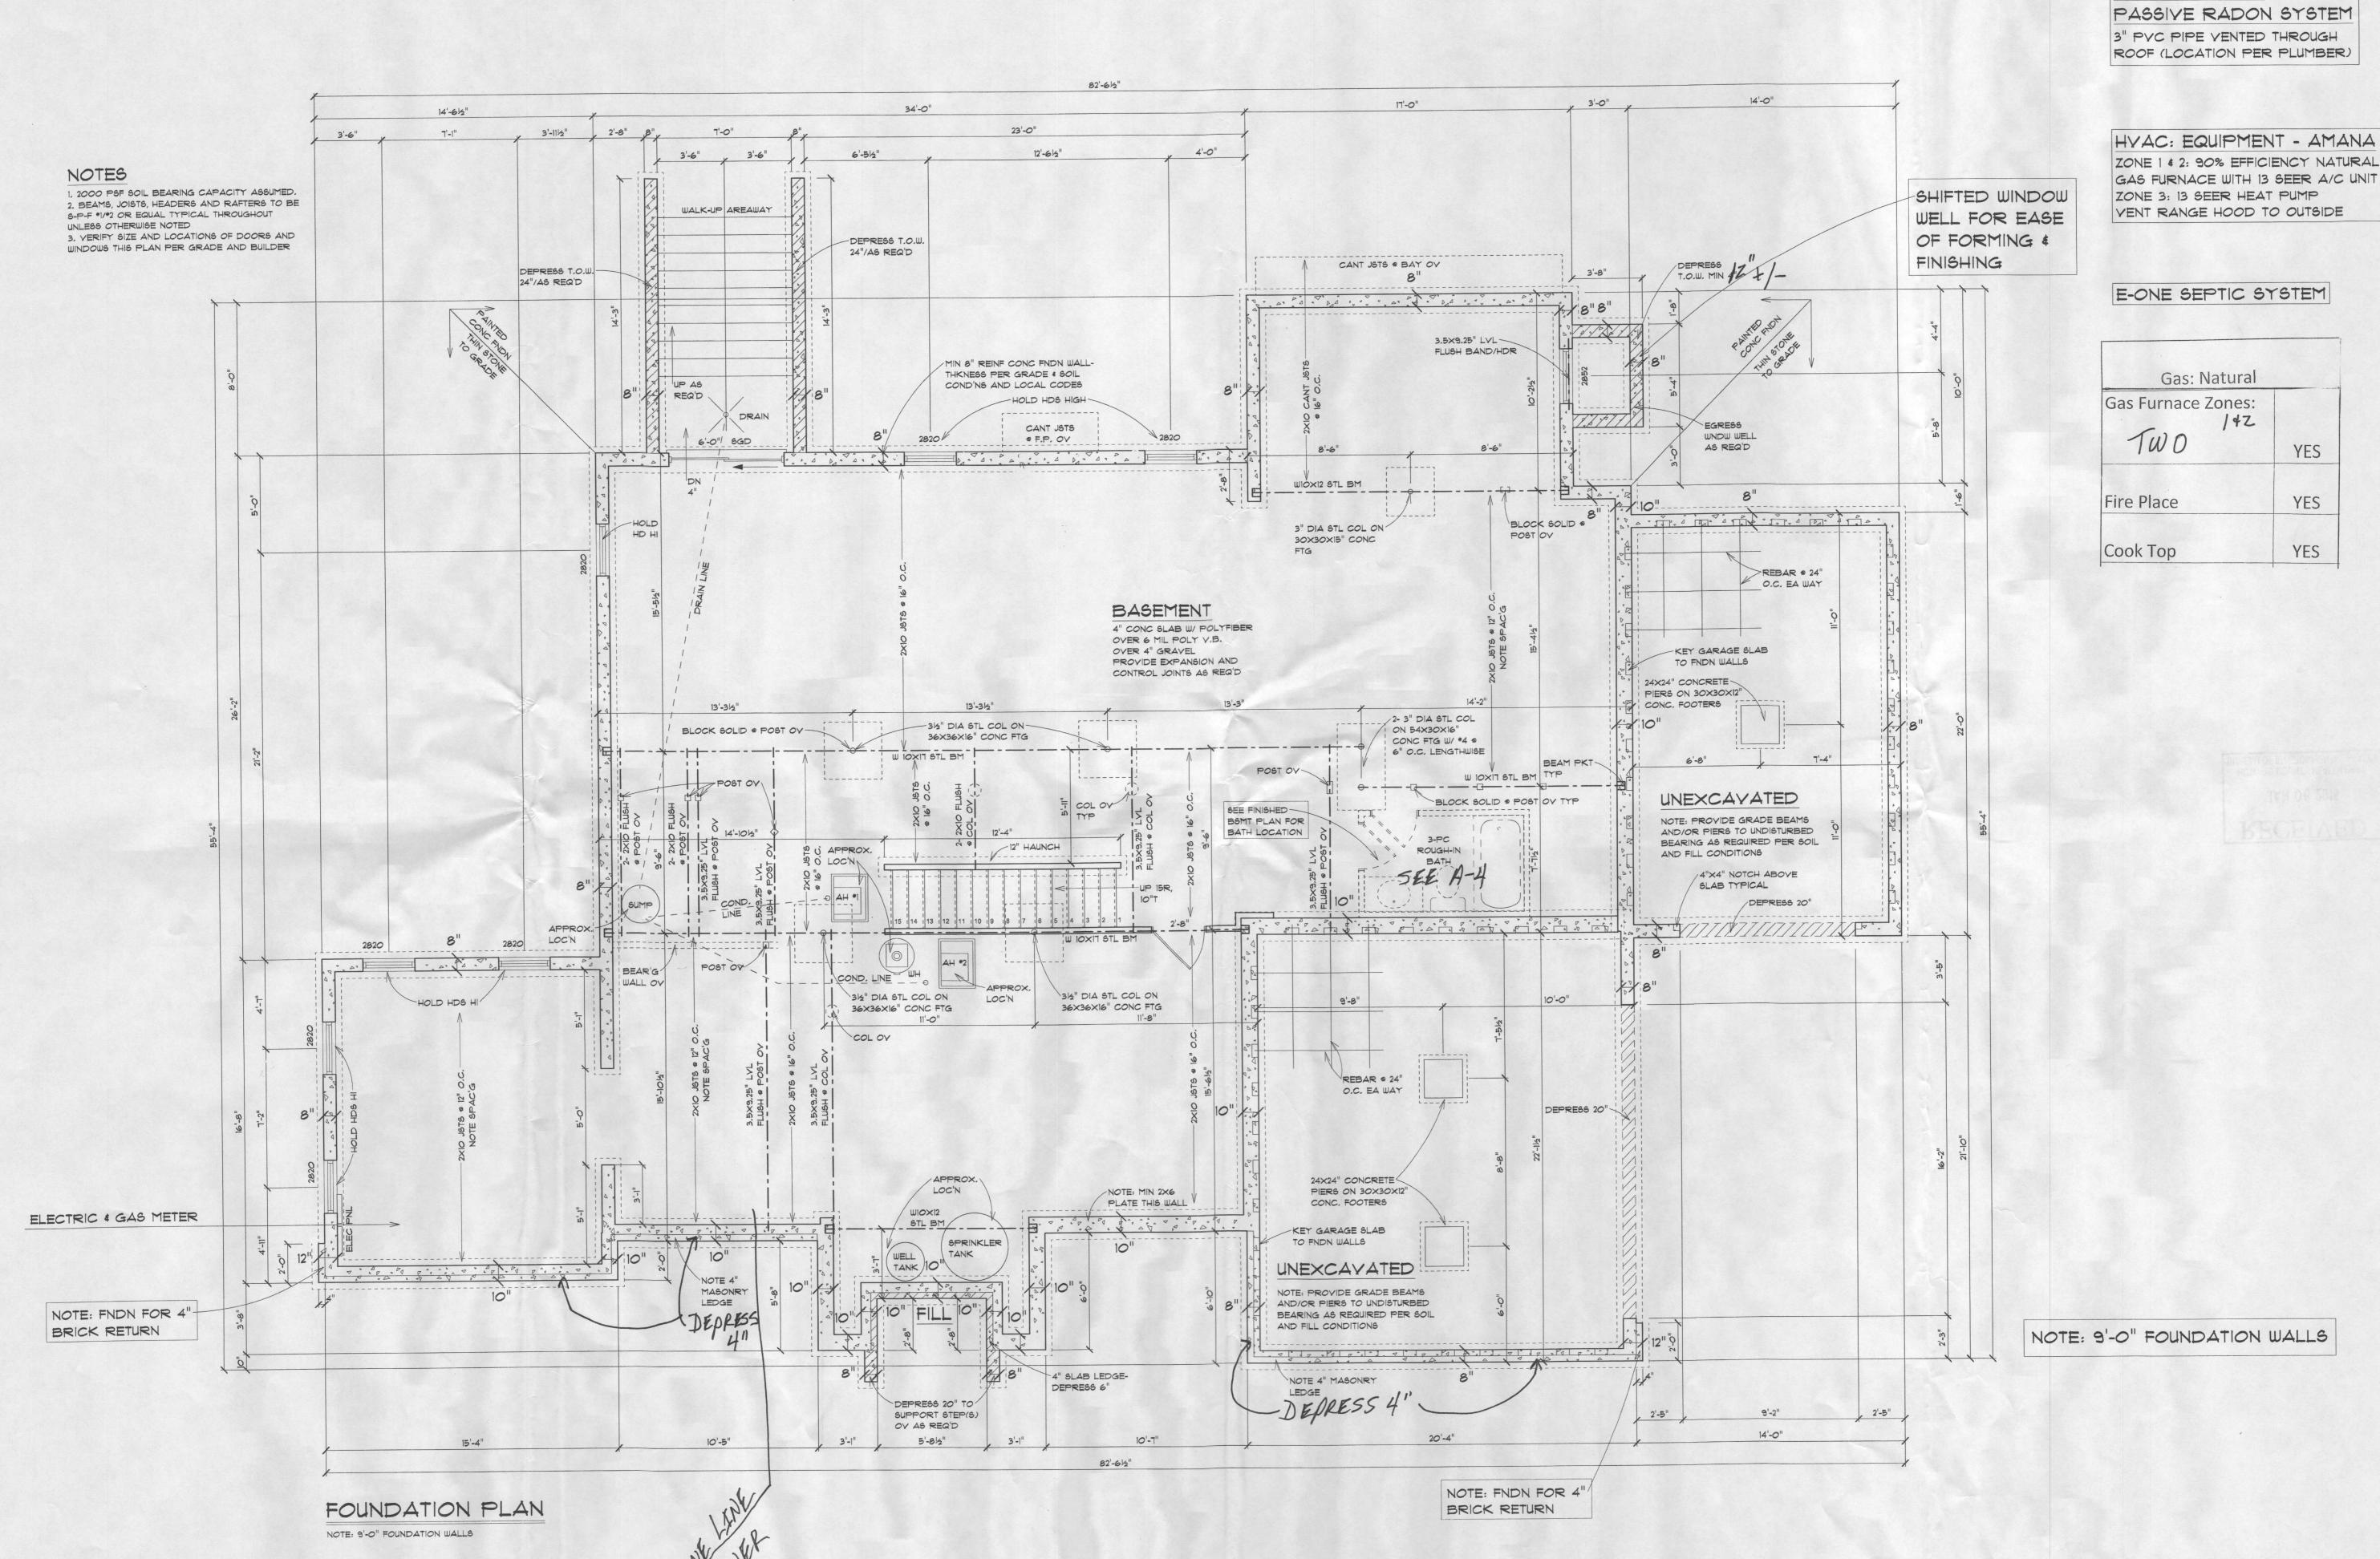ZONE 1 \$ 2: 90% EFFICIENCY NATURAL GAS FURNACE WITH 13 SEER A/C UNIT



FINISHED BASEMENT PLAN

08-19-2014
SHEET NO.

A-4

OR AS NOTED

REVISIONS

12-04-2014 12-05-2014

WALNUT CREEK INTERIOR TRIM PACKAGE DOORS: 1ST, 2ND, & BASEMENT FLOORS - PREHUNG MASONITE, RAISED CAMDEN DOOR HARDWARE: SATIN NICKEL STOPS, KNOBS, HINGES, AND HANDLES DOOR TRIM: 1ST, 2ND, & BASEMENT FLOORS - 34" BEADED EDGE CASING, FINGER JOINT BASE: IST, 2ND, & BASEMENT FLOORS - 514" WM-163E CHAIR RAIL: TWO PIECES WM-302 W/ 44" BEADED BOTTOM BACKER IN DINING ROOM FAMILY ROOM FIREPLACE: LENNOX . WOOD EXTENSIONS & CASINGS AROUND ALL WINDOWS EXCEPT IN THE GARAGE MILLIVOLT EDY4035 NATURAL GAS PRE ENGINEERED DIRECT YENT FIREPLACE CROWN MOULDING: THREE PIECE 4 5/8" CROWN W/ BEADED BOTTOM BACKER W/ #183 TRIM IN LIVING ROOM, DINING ROOM, FAMILY ROOM, GALLERY, SUNROOM, FOYER, F.P. ROUGH OPENING, LENNOX MILLIVOLT STUDY, SECOND FLOOR HALL, MASTER BEDROOM AND SITTING ROOM EDY4035: 41"W x 4012"H x 23"D COFFERED CEILINGS: TWO PIECE 4 5/8" CROWN W/ BOTTOM BACKER 34'-0" 14'-612" 7'-94" 3'-2" 21'-25/4" NOTE: CARPENTER 10'-71/2" 3'-914" 4'-0" 3'-914" ALLOW 4" FOR 34" CASING ON 1ST FLOOR, 2ND FLOOR, & FINISHED BASEMENT 3- 2X12 W/ 2- 15" PLYWD HDR 5.25×11.25" LYL FLUSH/ CONTIN INTO CORNERS POST 2X8 BUILT-DN PROVIDE 2 MEDALLIONS-COFFERED GLG 5.25X11.25" LYL HDR CONTIN INTO CORNERS LOCATIONS T.B.D. & SELECTIONS SUNROOM CANT JSTS & FLR OV 2-2462 NOTE: YENT HOOD TO 4- 2X6 POST EXTERIOR DIRECT-YENT a POST OY 3- 2X6 POST O'HG -3- 2X6 POST POST OV @ POST OY 5.25XII.25" LYL DROP DW 4- 2×6 2X4 WALL POST 20'-612" 42" HI KNEE WALL TO KITCHEN O DELETE M CAB LAYOUT BY BULKHEADS BREAKFAST FAMILY ROOM LIBRARY LOC'N DELETE METAL SPINDLES THIS STAIR -BULKHEADS I- CAR GARAGE SEE TYPICAL METAL SPINDLES 4" CONC SLAB W/ POLYFIBER /2- 2X10 NOTE BM HDR 2'-3½" 2'-3½" BR'G 5- 2×4 POST CLG BRK 3.5×9.25" LVL 3.5×9.25" LVL 3.5×9.25" LVL GALLERY NOTE: ADD THIRD PLY NOTE: SHEATHE THIS FACE THIS WALL W/ MIN 3×5 SHWR HARD Y. 0 BASE 8'-0'2' 2- 2X10 FLUSH C.TILE LAUNDRY ON WALLS, 3.5×11.25" LYL HDR CONTIN INTO CORNERS 2X4 WALL 2X6 WALL WOOD STEP(S. 9'-0" x 8'-0" AS REQ'D 3- 2×4 C. TILE ON 5/8" TYPE "X" GYP. BD. POST WALLS 8 OAK OPEN @ COMMON WALLS & CLG. -CONSERVATORY STAIRS 2- CAR GARAGE 4- 2X8 4" CONC SLAB W/ POLYFIBER 2 GARAGE DOOR OPENERS POST METAL SPINDLES
THIS STAIR - SEE LIFTMASTER 3265 LIVING DINING TYPICAL METAL SPINDLES NOTE ROOM ROOM SLOPE SLAB DOWN 4" -3- 2×12 W/ 2- 1/2" BLKHD FOYER PLYWD HDR WI4X34 STL BM CONTIN INTO 2- STORY CORNERS 19'-14" 5- 2X6 POST 2X8 BUILT-DN SHEATHE COFFERED CLG ! THIS FACE PER MFR 3- 2X12 W/ 2- 1/2" PLYWD HDR CONTIN INTO CORNERS THIS WALL W/ MIN 7/16" OSB BRICK 4- 2X6 POST /3- 2X8 POST VENEER POST OV CT28 OV / BRICK STOOP NOTE: 9' CEILINGS U.O.N. THIN STONE-RETURN YENEER TYP 9 ASIAN BLUESTONE 2X6 EXTERIOR WALLS U.O.N. FRONT U.O.N. TON CONC ASIAN BLUESTONE OY CONC STEP(6) BRICK BRICK AS REQ'D YENEER 3'-214" 6'-412" 82'-612" NOTE: INTERIOR STAIRS SHALL CONFORM TYPICAL METAL SPINDLES FIRST FLOOR PLAN INCLUDES OIL RUBBED COPPER TO THE FOLLOWING GEOMETRY: SPINDLES BASKET C2552 & STRAIGHT C2551 BOTH W/ TWISTS & COLLARS AND NOTE: 9'-1%" WALL HGT 45 DEG ANGLE WALLS U.O.N. OVER THE POST RAILS FRONT & REAR STRAIGHT: STAIRS (PER PLAN) RISER HEIGHT 7.75" MAX TREAD DEPTH 10" MIN NOSING .75" MIN 1.25" MAX (NOTE: NOSING MAY BE OMITTED & TREAD DEPTH OF II" OR GREATER)

SC ALE: 1/4" = 1'-0"OR AS NOTED

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OR AS NOTED


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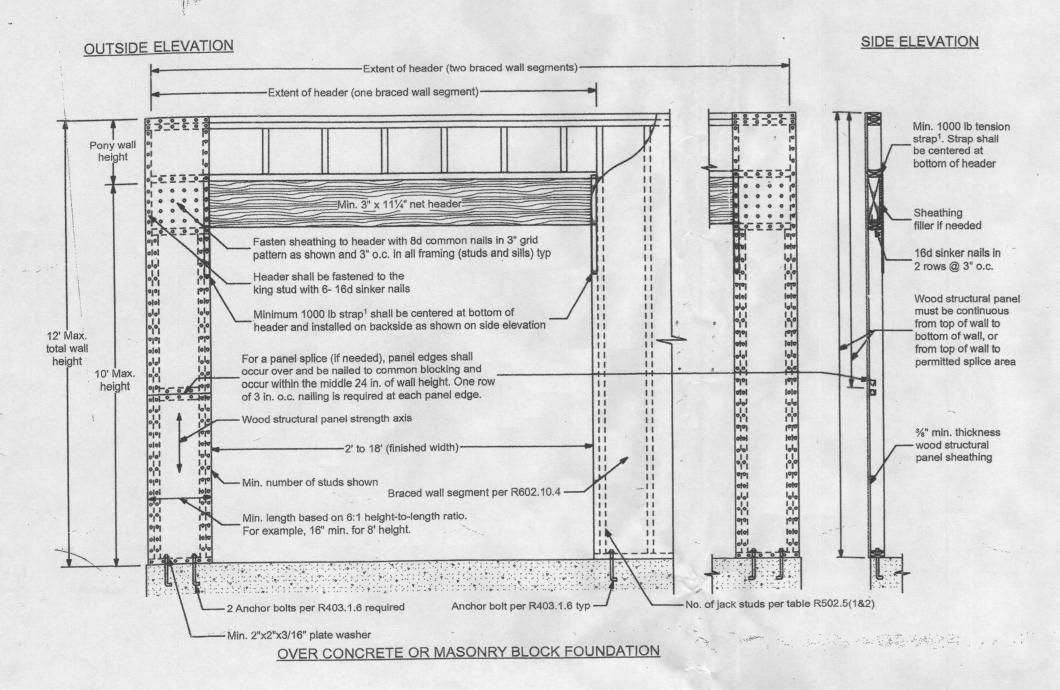



Methods WSP & CS-WSP: Min. 7/16" OSB Wood Structural Panel sheathing attached to framing with 6d at 6" o.c. at panel edges and 12" o.c. at intermediate framing members.

Note: At Braced Wall Lines incorporating Continuously Sheathed bracing methods (CS-WSP & CS-PF), all exterior walls along the Braced Wall Line must be fully sheathed with min 7/16" OSB Wood Structural Panel sheathing fastened per IRC 2009 Tables R602.3(1), R602.3(2), and R602.3(3).


Method GB: Min. ½" gypsum board applied to each side of framing with adhesive and Type S or W screws @ 7" o.c. at panel edges and 24" o.c. at intermediate framing members or nails per IRC 2009 Table R702.3.5 @ 7" o.c. at panel edges and 16" o.c. at intermediate framing members.

Method LIB: Simpson WB/WBC straps installed in an "X" pattern on one face of wall; fasten with 2- 16d nails at top and bottom plates and 1-8d nail per stud. 8' tall walls to use either WB106/WB106C installed at 60° from horizontal (4'-8" linear wall length) or WB126/WB126C installed at 45° from horizontal (8'-1" linear wall length); 9' tall walls to use WB126/WB126C installed at 53° from horizontal (6'-10" linear wall length); 10' tall walls to use WB143C installed at 45° from horizontal (10'-1" linear wall length).

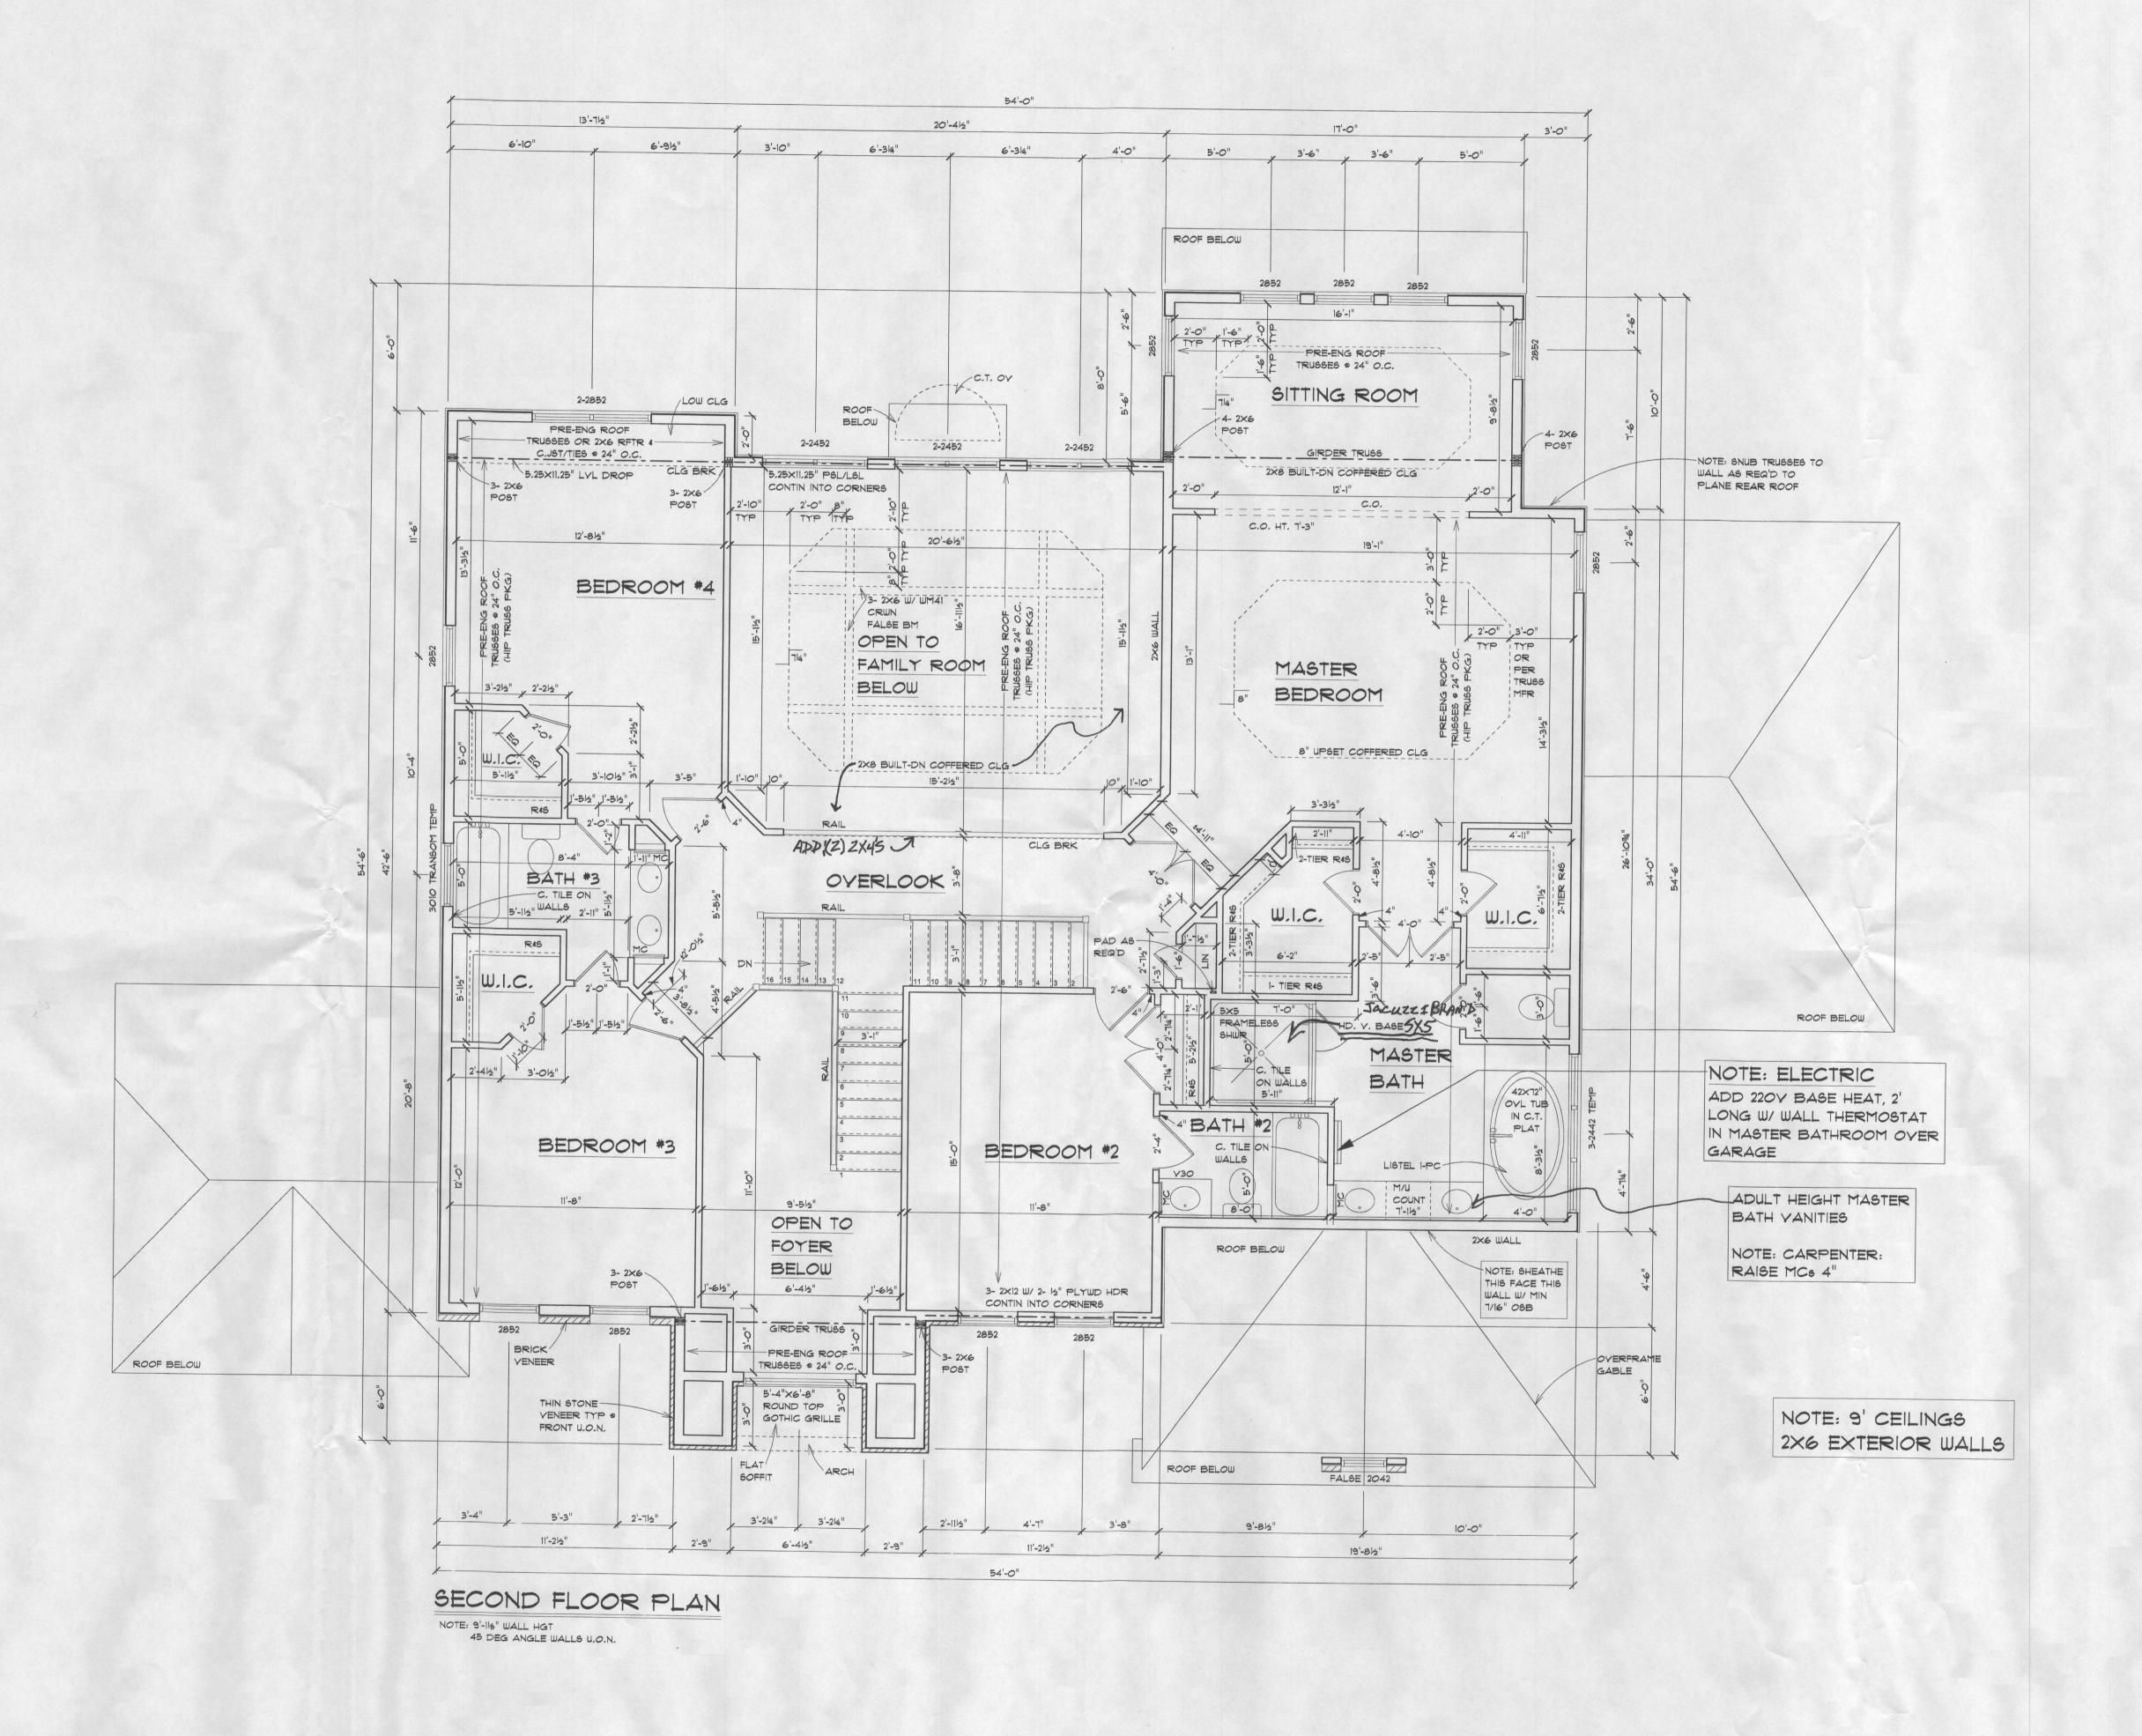

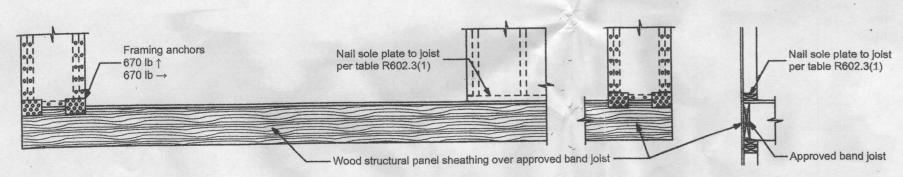

OVER RAISED WOOD FLOOR OR SECOND FLOOR - FRAMING ANCHOR OPTION

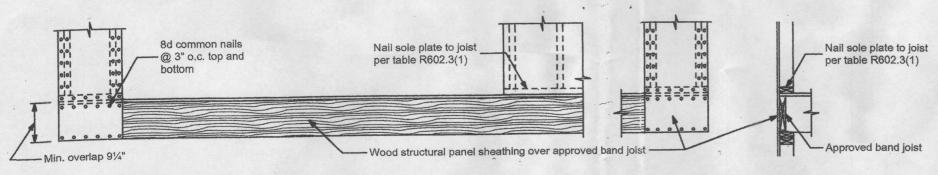

OVER RAISED WOOD FLOOR OR SECOND FLOOR - WOOD STRUCTURAL PANEL OVERLAP OPTION

¹Tension Strap Capacity Required for Method CS-PF


Minimum Wall Stud Framing	Maximum Pony Wall Height (feet)	Maximum Total Wall Height (feet)	Maximum Opening Width (feet)	Wind Exposure B	Wind Exposure C
Nominal Size and Grade				Tension strap capacity required (lbf)	
	0	10	18	1000	1000
	1	10	9	1000	. 1000
			16	1000	2325
			18	1200	2725
			9	1000	1550
2x4 No. 2	2	10	16	2025	3900
Grade			18	2400	DR
	2		9	1200	2750
		12	16	3200	DR
			18	3850	DR
			9	2350	DR
	4	12	16	DR	DR
2x6 Stud Grade	2 12	12	9	1000	1750
			16	2050	3550
		18	2450	4100	
	4	12 .5	9	1500	2775
			16	3150	DR
			18	3675	DR


Notes: 1. Basic Wind Speed of 90mph. For other Basic Wind Speeds, see IRC 2009 Table R602.10.4.1.1

2. DR = Design Required

Continuous Portal Frame


NOT TO SCALE

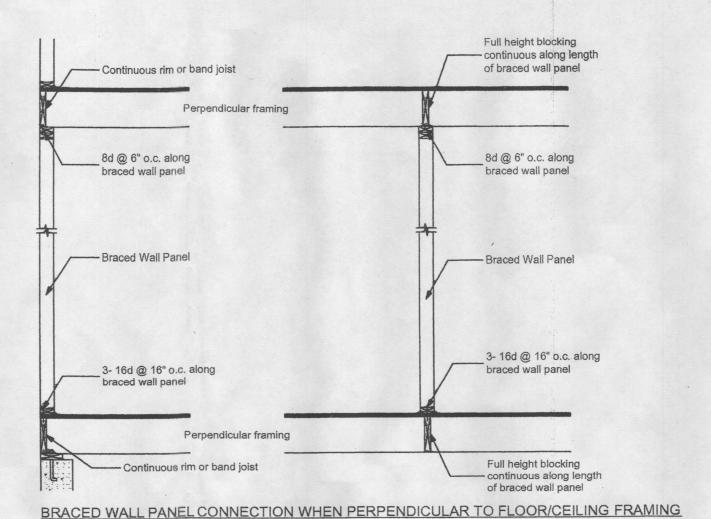


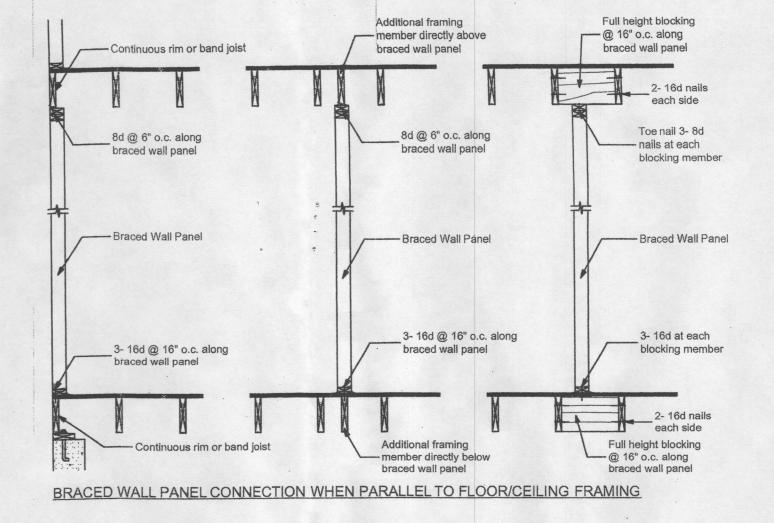

Braced Wall Panel Connections to Floor and Ceiling Framing


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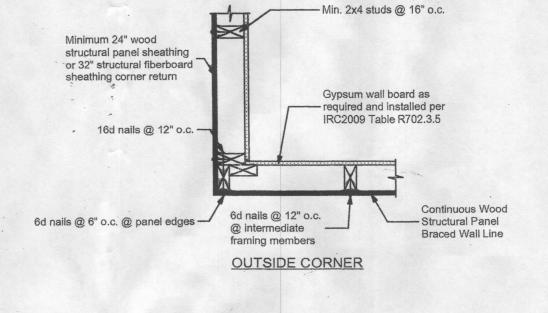


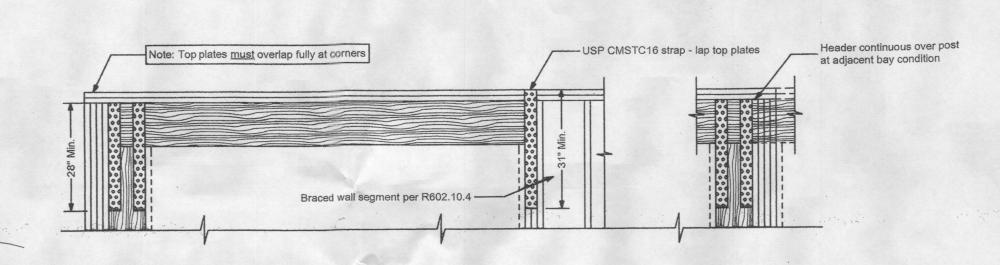
Engineered LSL Column Portal Frame

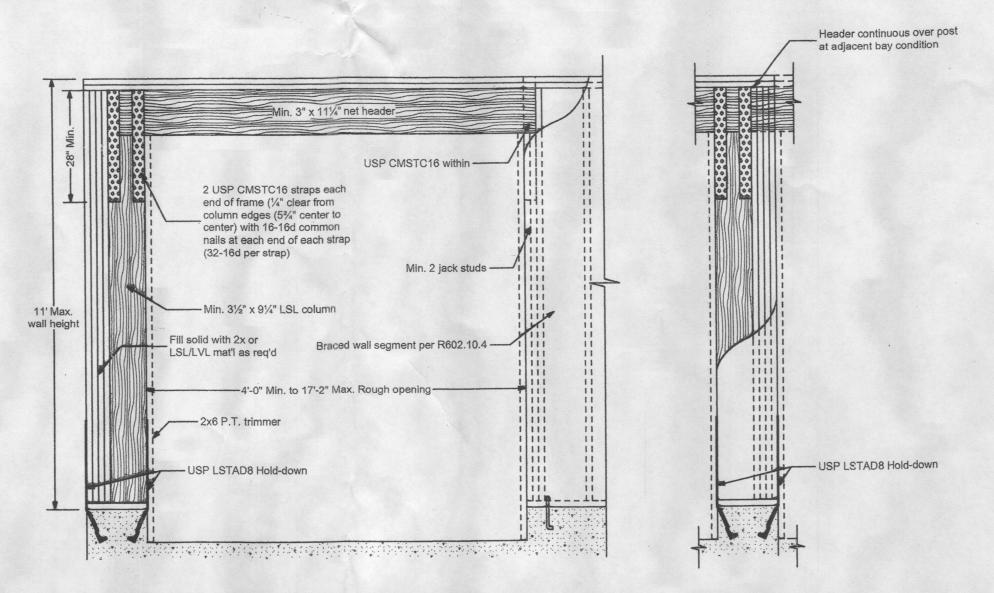EXTERIOR ELEVATION OVER CONCRETE FOUNDATION




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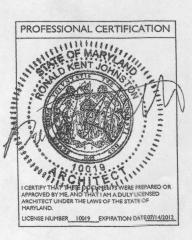
INSIDE CORNER

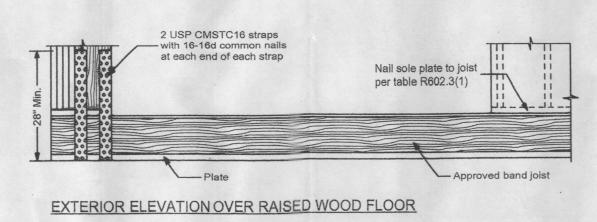

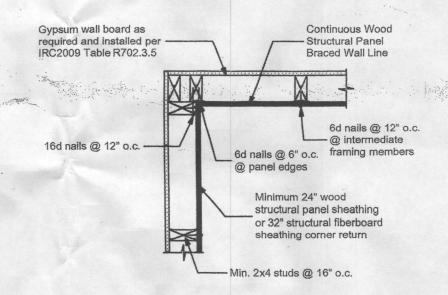Corner Framing Details

NOT TO SCALE

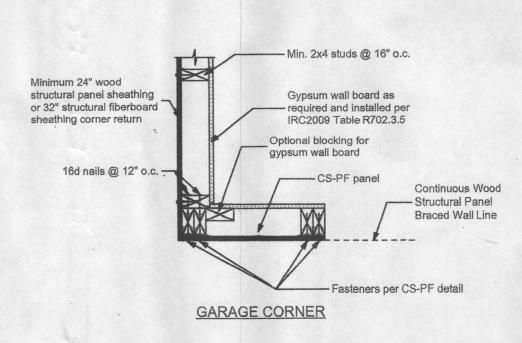



REVISIONS W-1

04/10/2012

08/16/2010

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08-19-2014

W-2

SHEET NO.

