INSP 2 10/15/02 10 9 INSP 3 10/18/02	INSP 4 INSP 5 INSP 6	3/19/03	11am 3 pm		
ISSUE DATE: 10/8	12002	PERMI	Т	P _	517952
APPROVAL DATE: 3/	9/03	LICITI	•	A	48146-A

ON-SITE SEWAGE DISPOSAL SYSTEM HOWARD COUNTY HEALTH DEPARTMENT BUREAU OF ENVIRONMENTAL HEALTH

Hatfields H	Equipment	IS PERMITTE	D TO INST	TALL 🖂	ALTER		
ADDRESS: 1	3785 Burntwoods Road,	Glenelg PHON	IE NUMBER:	301-85	4-6172		
SUBDIVISION:	Humphries Property	LOT	NUMBER:	1	<i>J.</i>		
ADDRESS:	14460 Triadelphia Mill Road	PROPERTY O	WNER: Th	e Griffmore	e Group, LLC		
SEPTIC TANK C	CAPACITY (GALLONS):		LET BAFFLE F	ILTER RE	QUIRED		
PUMP CHAMBER CAPACITY (GALLONS):		N/A COMP	COMPARTMENTED TANK REQUIRED Compartm				
NUMBER OF BEDROOMS:		3 Sean	red. Also	recom	mad a Ni		
SQUARE FEET PER BEDROOM:		3 samed. Also recommed a No Baiffle due to proximity st sile. 180 Triodel phia Resevar.					
LINEAR FEET C	F TRENCH REQUIRED:		SE SERVED BY				
TRENCHES:	Trench to be 3.0 feet wid 5.0 feet below original gr feet of stone below distrib	ade. Effective area beg					
LOCATION:	Place the distribution box 248.89' south property lin contour as illustrated on t with a dog leg to the sout	e, and 45 from that san he attached copy of the	ne south propert	ty line. Ins	tall trenches on		
NOTES:	You may install trenches placement and conserve a **SEE RECOMMENDA	rea for future replaceme	ent systems or b	ouilding add	ditions.		
PLANS APPROV	/ED: Ron J. Pinkley C	on sek # 6/0	2	DATE:	7/03/2002		


NOTES: PERMIT VOID AFTER 2 YEARS

CONTRACTOR IS RESPONSIBLE FOR SCHEDULING A PRE-CONSTRUCTION INSPECTION FOR ALL INSTALLATIONS WATERTIGHT SEPTIC TANKS REQUIRED

ALL PARTS OF SEPTIC SYSTEM SHALL BE 100 FEET FROM ANY WATER WELL UNLESS SPECIFICALLY AUTHORIZED MANHOLE RISERS REQUIRED ON ALL SEPTIC TANKS AND PUMP CHAMBERS UNLESS SPECIFICALLY AUTHORIZED


CONTRACTOR RESPONSIBLE FOR COMPLIANCE WITH APPLICABLE REGULATIONS, GUIDELINES AND THE TERMS OF THIS PERMIT

NEITHER THE HOWARD COUNTY COUNCIL NOR THE HEALTH DEPARTMENT IS RESPONSIBLE FOR THE SUCCESSFUL OPERATION OF ANY SYSTEM PERMITTEE RESPONSIBLE FOR OBTAINING FINAL APPROVAL ON THIS PERMIT ALL 410-313-2640 FOR INSPECTION OF SEPTIC SYSTEM

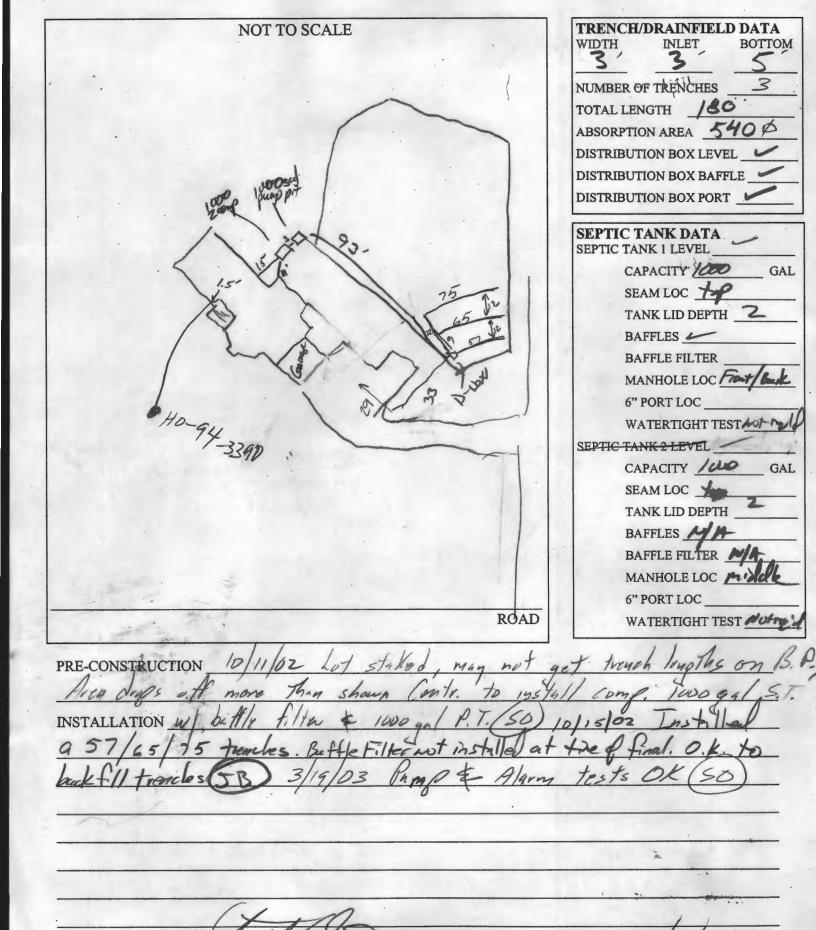


DATE OF APPROVAL


FINAL INSPECTOR

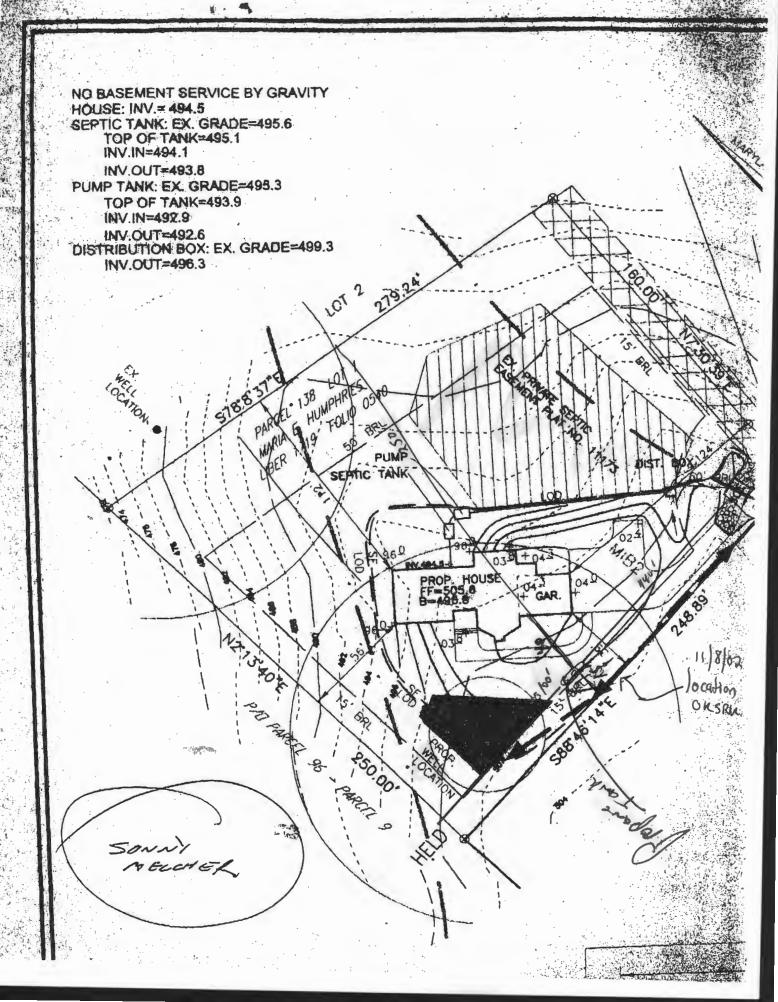

N/F KENNETH AND RITA HOHENBRICK L. 1282 / F. 186

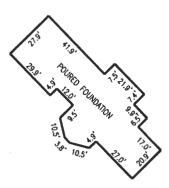

HOUSE DETAIL SCALE: 1"=50'

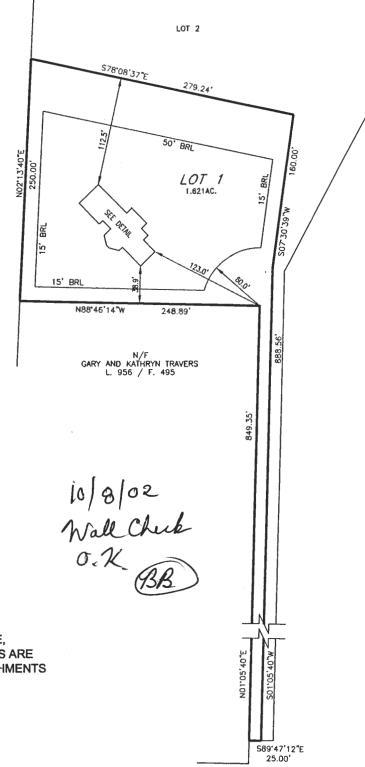

I HEREBY CERTIFY TO THE BEST OF MY KNOWLEDGE, INFORMATION AND BELIEF THAT THE IMPROVEMENTS ARE LOCATED AS SHOWN AND THERE ARE NO ENCROACHMENTS EXCEPT AS SHOWN.

OF MARKING OF MARKEN OF M

HOWN.

PROPERTY AND STREET OF MARKET AND STREET OF MEEKS, LS #10857

TRIDELPHIA MILL ROAD

 PLAT No.
 DATE

 11173
 8-9-02

 DR. BY
 CH. BY

 TRB
 JRB

 SCALE:
 JOB NO.

 1"=100'
 2024038

ENGINEERS

ARCHITECTS


SURVEYORS

FREDERICK WARD ASSOCIATES, INC.

7125 Riverwood Drive Columbia, Maryland 21046-2354
Phone: 410-290-9550 Fax: 410-720-6226
Bel Air, Maryland Warrenton, Virginia

WALL CHECK
LOT 1
HUMPHRIES
PROPERTY
5th ELECTION DISTRICT
HOWARD COUNTY, MARYLAND

TOP OF WALL = 503.23

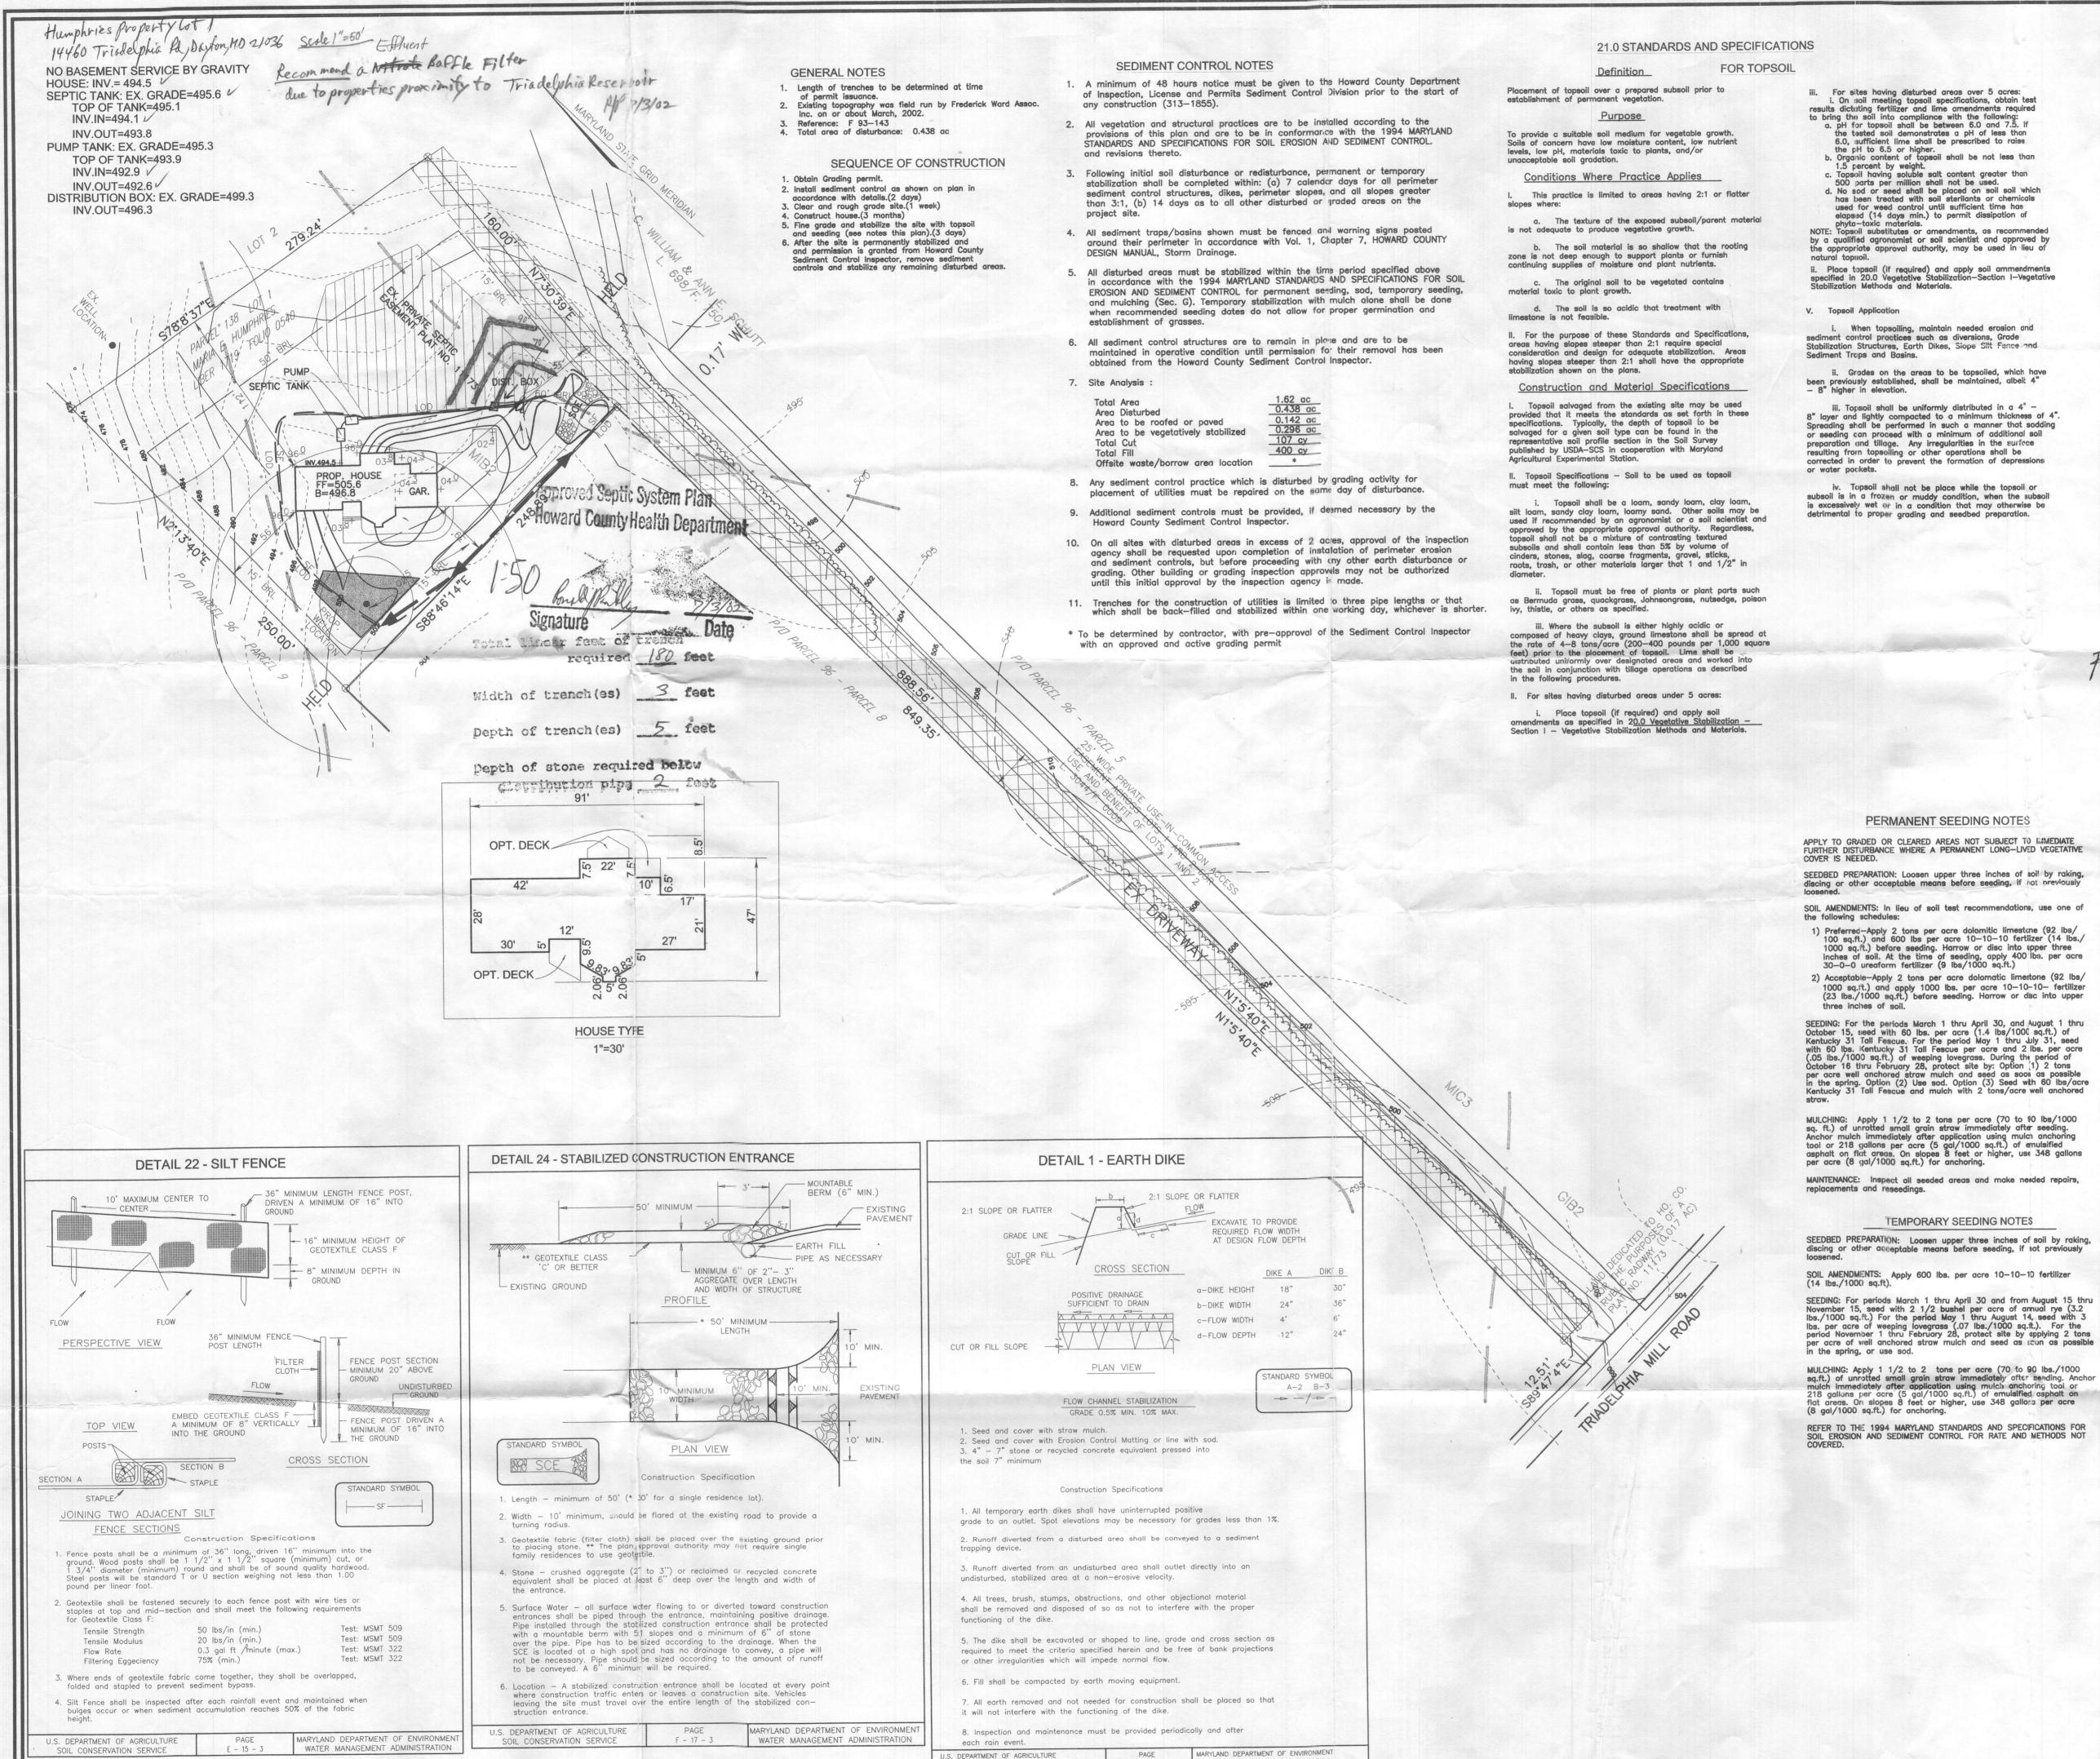

PAGE MARYLAND DEPARTMENT OF ENVIRONMENT

A - 1 - 6 WATER MANAGEMENT ADMINISTRATION

SOIL CONSERVATION SERVICE

iii. For sites having disturbed areas over 5 acres:
i. On soil meeting topsoil specifications, obtain test results dictating fertilizer and lime amendments required to bring the soil into compliance with the following:
a. pH for topsoil shall be between 6.0 and 7.5. If

the tested soil demonstrates a pH of less than 6.0, sufficient lime shall be prescribed to raise the pH to 6.5 or higher.

Organic content of topsoil shall be not less than 1.5 percent by weight.
Topsoil having soluble salt content greater than

500 parts per million shall not be used. d. No sod or seed shall be placed on soil soil which has been treated with soil sterilants or chemicals used for weed control until sufficient time has elapsed (14 days min.) to permit dissipation of phyto-toxic materials.

Topsoil substitutes or amendments, as recommended. by a qualified agronomist or soil scientist and approved by

the appropriate approval authority, may be used in lieu o natural topsoil. Place topsoil (if required) and apply soil ammendments specified in 20.0 Vegetative Stabilization—Section I—Vegetative Stabilization Methods and Materials.

V. Topsoil Application

i. When topsoiling, maintain needed erosion and sediment control practices such as diversions, Grade Stabilization Structures, Earth Dikes, Slope Silt Fence and Sediment Traps and Basins.


ii. Grades on the areas to be topsoiled, which have been previously established, shall be maintained, albeit 4" — 8" higher in elevation.

iii. Topsoil shall be uniformly distributed in a 4" -8" layer and lightly compacted to a minimum thickness of 4". Spreading shall be performed in such a manner that sodding or seeding can proceed with a minimum of additional soil preparation and tillage. Any irregularities in the surface resulting from topsoiling or other operations shall be corrected in order to prevent the formation of depressions

iv. Topsoil shall not be place while the topsoil or subsoil is in a frozen or muddy condition, when the subsoil is excessively wet of in a condition that may otherwise be detrimental to proper grading and seedbed preparation.

PERMANENT SEEDING NOTES

TEMPORARY SEEDING NOTES

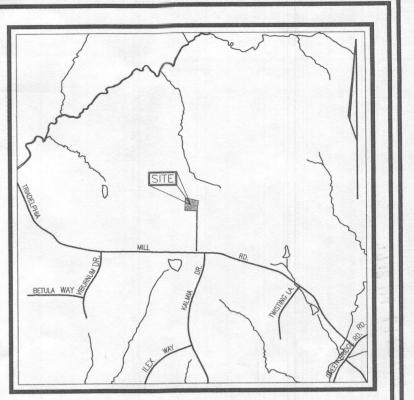

VICINITY MAP SCALE: 1"=2000'

Existing Contour Proposed Contour Spot Elevation Direction of Flow

Existing Trees to Remain

+8253

SF SF

Stabilized Construction Silt Fence Earth Dike

Limit of Disturbance ______LOD

PROP. ADDRESS 14460 TRIADELPHIA MILL PD. DAYFOU MO 21036

BUILDER: THE GREGEMORE GROUP LLC 4231 LINTHICUM BD DAYTON MD 21036

ENGINEERS CERTIFICATE

"I CERTIFY THAT THIS PLAN FOR SEDIMENT AND EROSION CONTROL REPRESENTS A PRACTICAL AND WORKABLE PLAN BASED ON MY PERSONAL KNOWLEDGE OF THE SITE CONDITIONS AND THAT IT WAS PREPARED IN ACCORDANCE WITH THE REQUIREMENTS OF THE HOWARD SOIL CONSERVATION DISTRICT.

SIGNATURE OF ENGINEER ROBERT H. VOGEL

DEVELOPER'S CERTIFICATE

"I/WE CERTIFY THAT ALL DEVELOPMENT AND CONSTRUCTION WILL BE DONE ACCORDING TO THIS PLAN FOR SEDIMENT AND EROSION CONTROL, AND THAT ALL RESPONSIBLE PERSONNEL INVOLVED IN THE CONSTRUCTION PROJECT WILL HAVE A CERTIFICATE OF ATTENDANCE AT A DEPARTMENT OF THE ENVIRONMENT APPROVED TRAINING PROGRAM FOR THE CONTROL OF SEDIMENT AND EROSION BEFORE BEGINNING THE PROJECT. I ALSO AUTHORIZE PERIODIC ON-SITE INSPECTION BY THE HOWARD SOIL CONSERVATION DISTRICT.

DEVELOPER

4/29/02

REVIEWED FOR HOWARD SCD AND MEETS TECHNICAL REQUIREMENTS

FOR SOIL EROSION AND

PLOT PLAN TRIADELPHIA MILL ROAD


HUMPHRIES PROPERTY LOT

TAX MAP 27 5TH ELECTION DISTRICT ZONED: RR-DEO

PARCEL '138' HOWARD COUNTY, MARYLAND REF.: F-93-143


ARCHITECTS

FREDERICK WARD ASSOCIATES, INC. ENGINEERS | 7125 Riverwood Drive Columbia, Maryland 21046-2354 Phone: 410-290-9550 Fax: 410-720-6226 Columbia, Maryland Warrenton, Virginia surveyors | Bel Air, Maryland

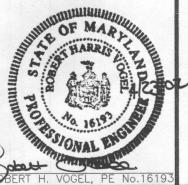

DESIGN BY: MHM DRAWN BY: 1"=50 2024038.0

SHEET

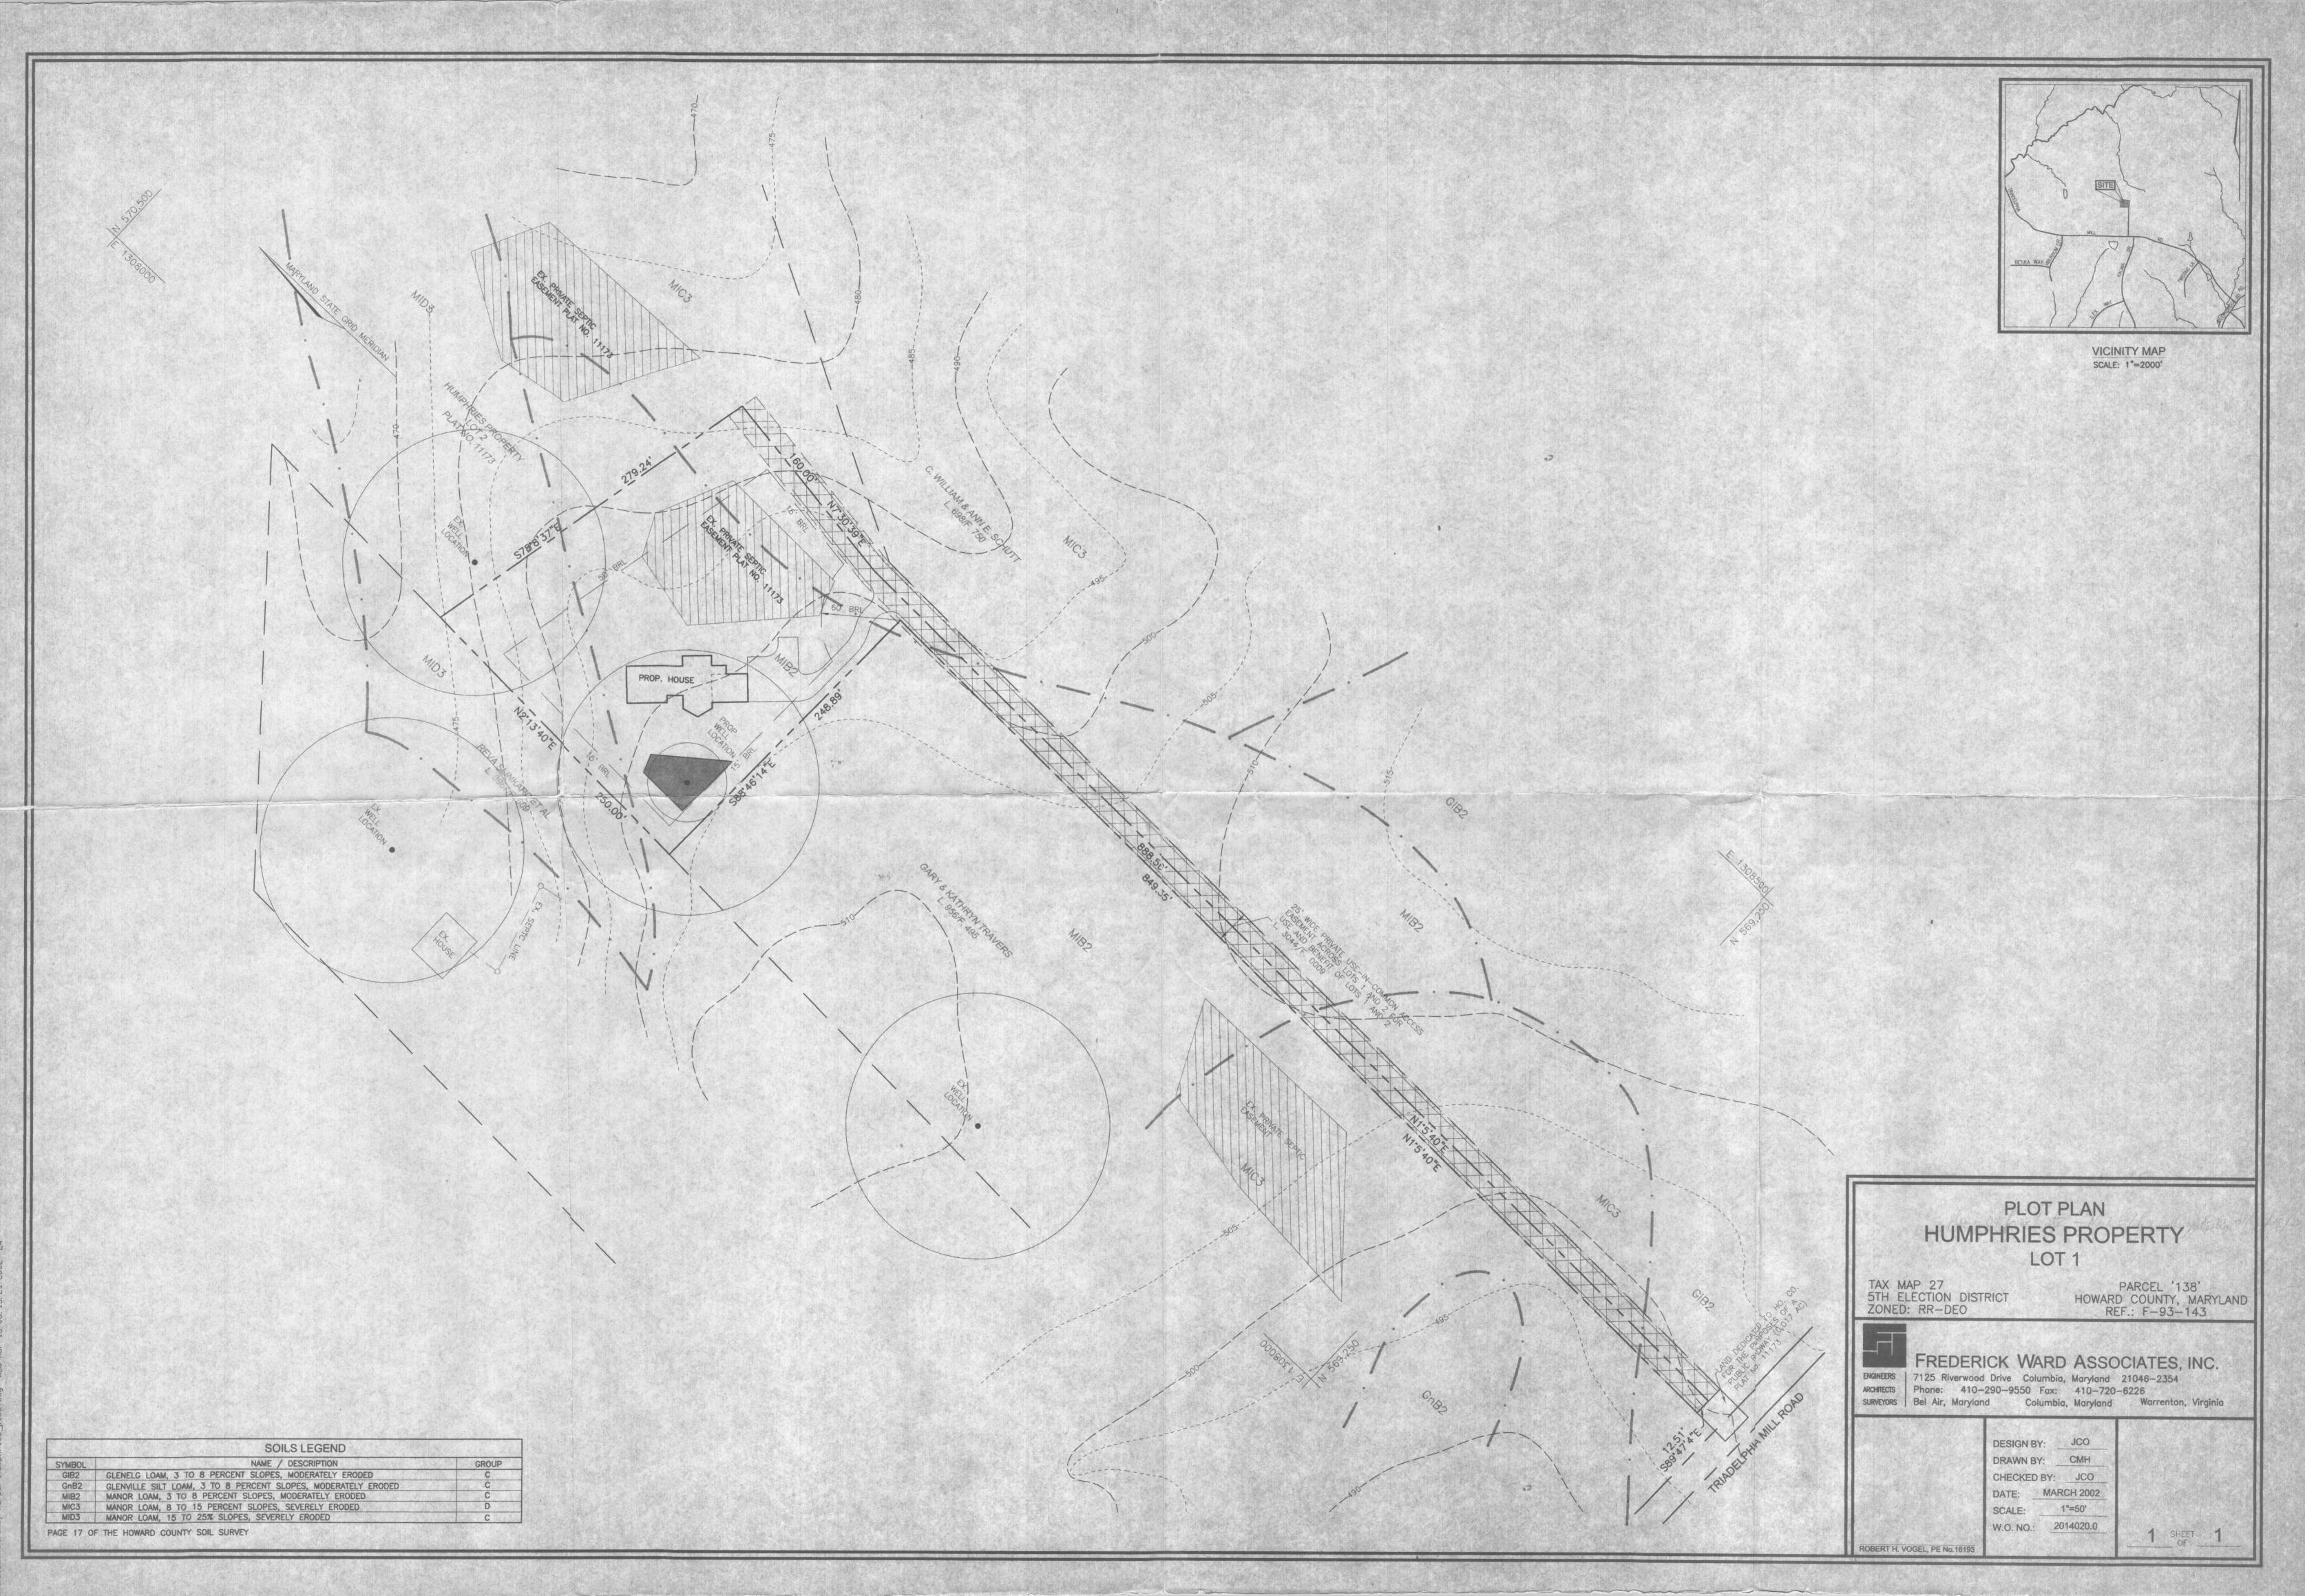

candy harner/himmhries nlot dwn Wed Mar (3 08: 45: 21 2002