



tim graham

7/3/2018 8:31 AM

Wellington Wf lot 10 plancd.dwg

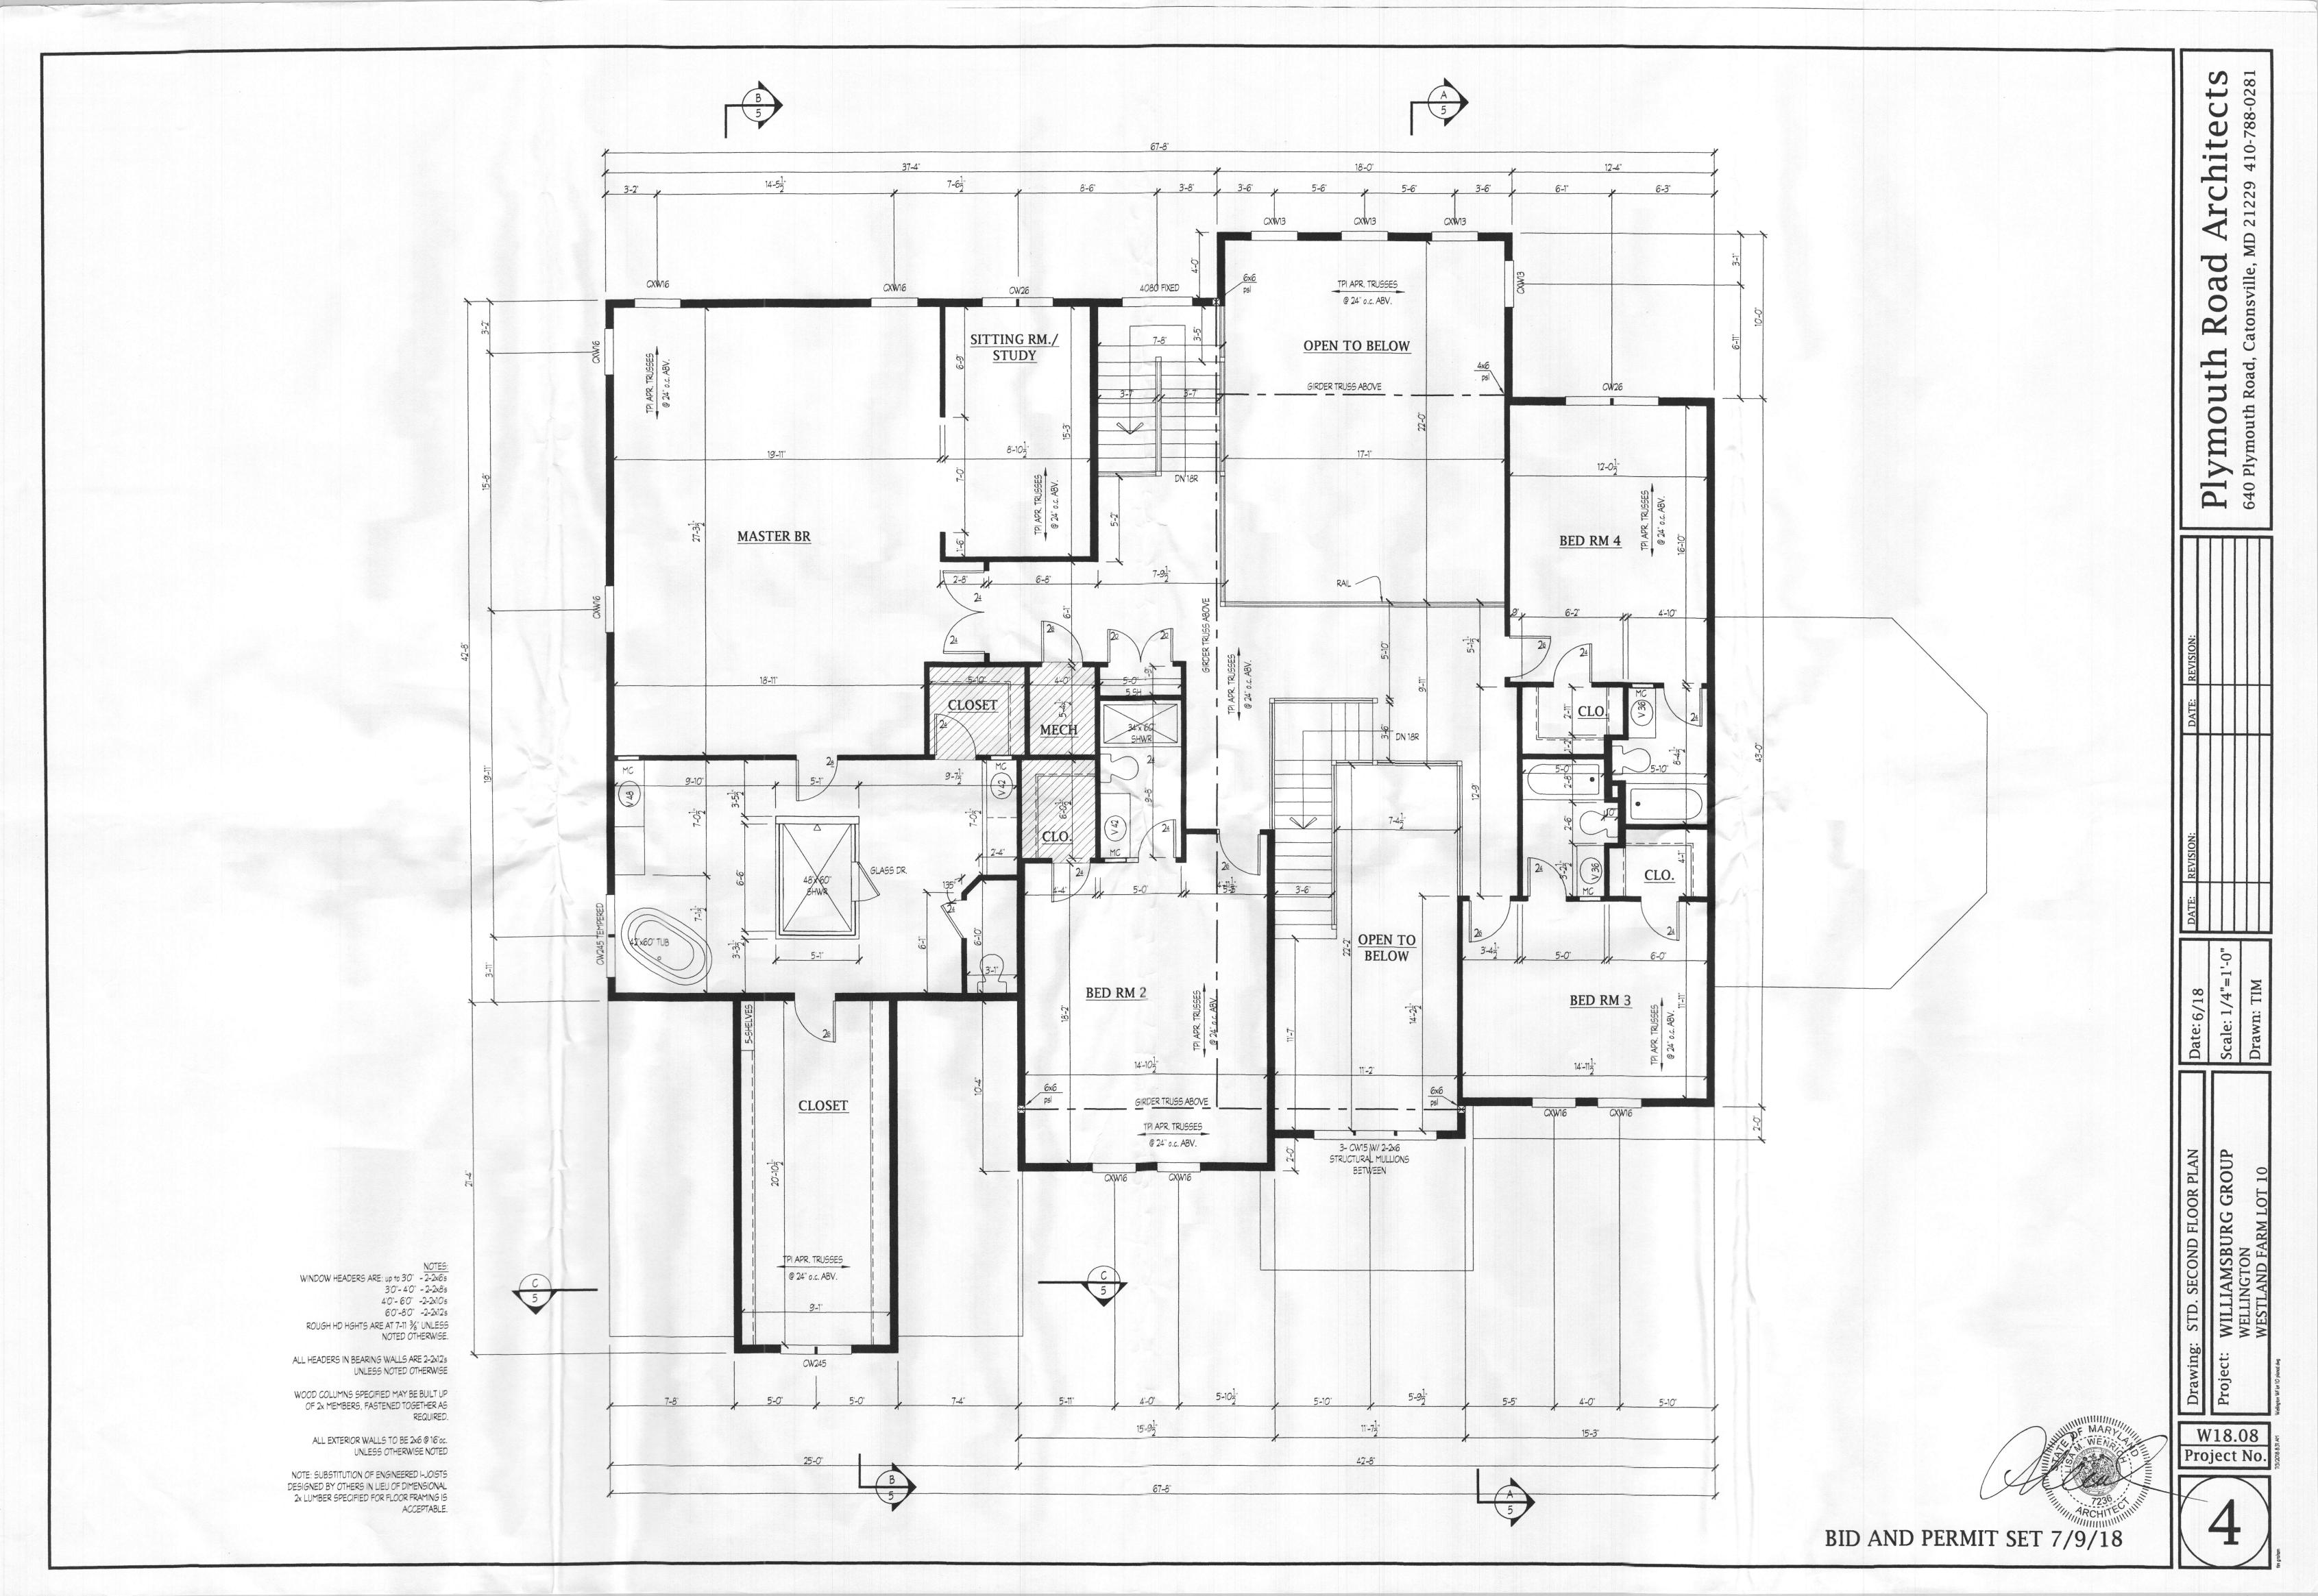

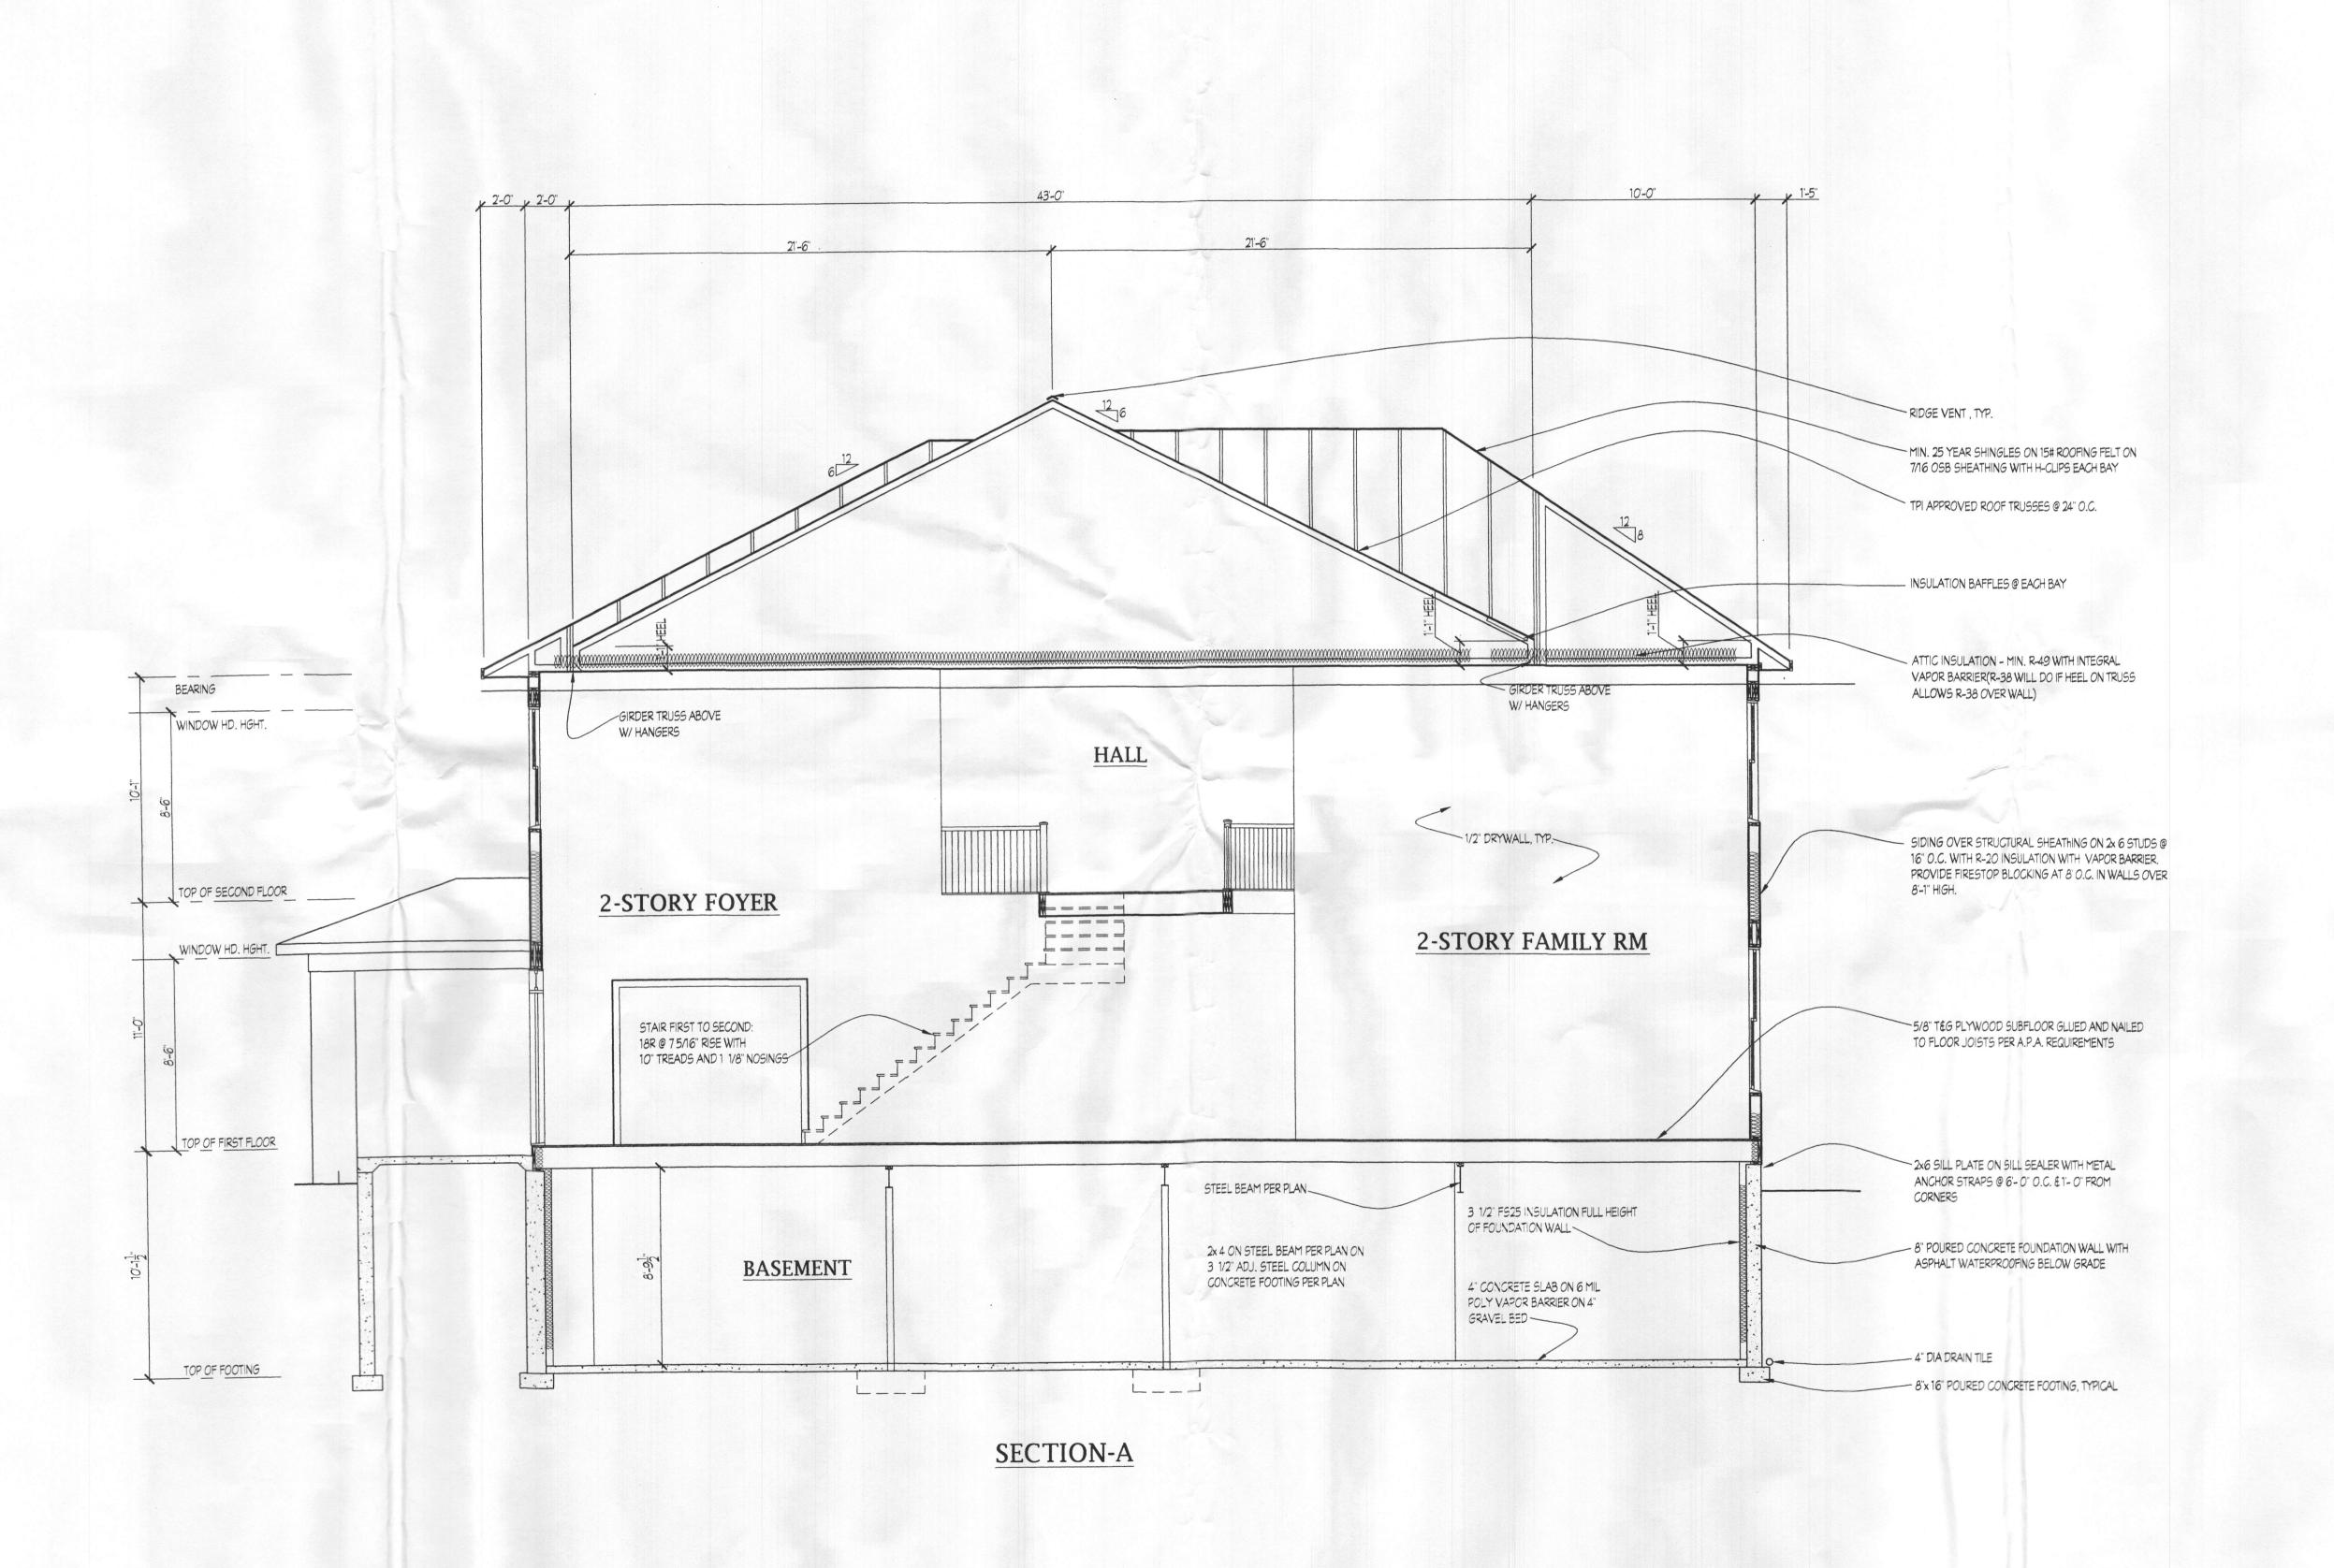


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LLIAMSBURG GROUP
LLINGTON
STLAND FATT

W18.08 Project No.

BID AND PERMIT SET 7/9/18

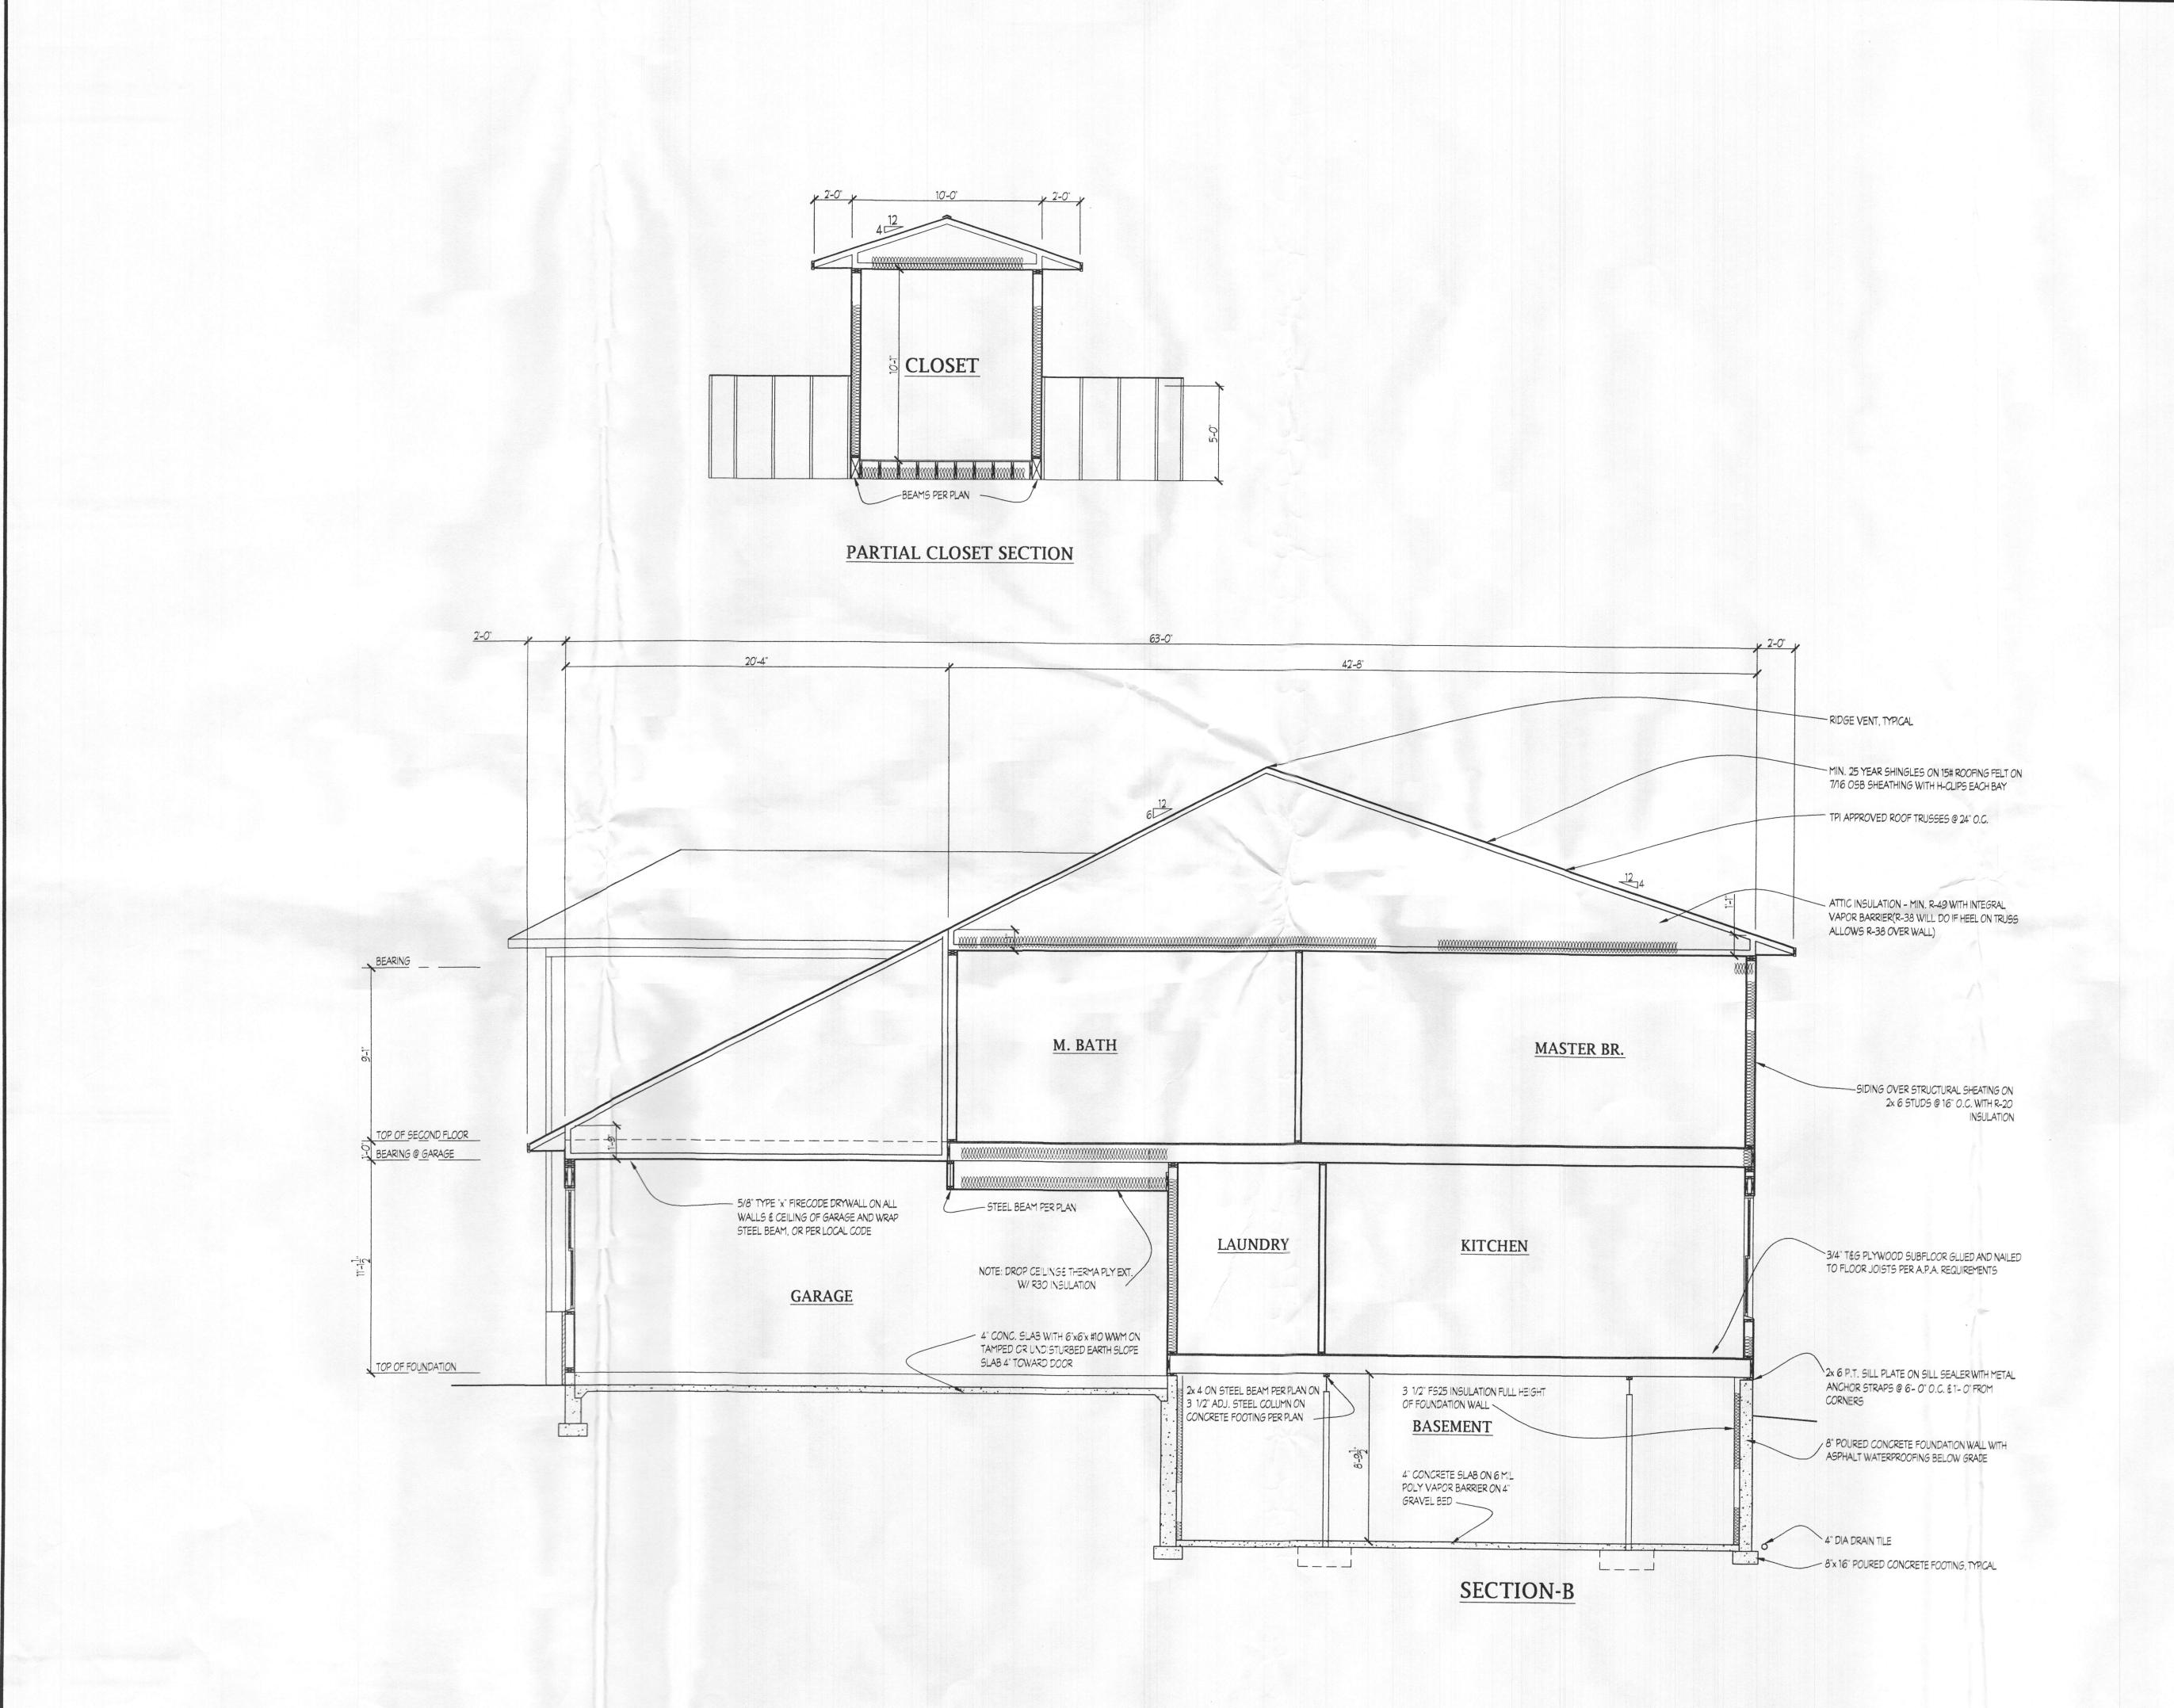

Plymouth Road, Catonsville, MD 21229 410-788-0281

 GROUP
 Scale: 1/4"=1'-0"
 DATE: REVISION:
 DATE: REVISION:
 DATE: REVISION:
 REVISION:


 OT 10
 Drawn: TIM
 TIM</

Drawing: SECTION B

Project: WILLIAMSBURG (
WELLINGTON

W18.08 Project No.

18

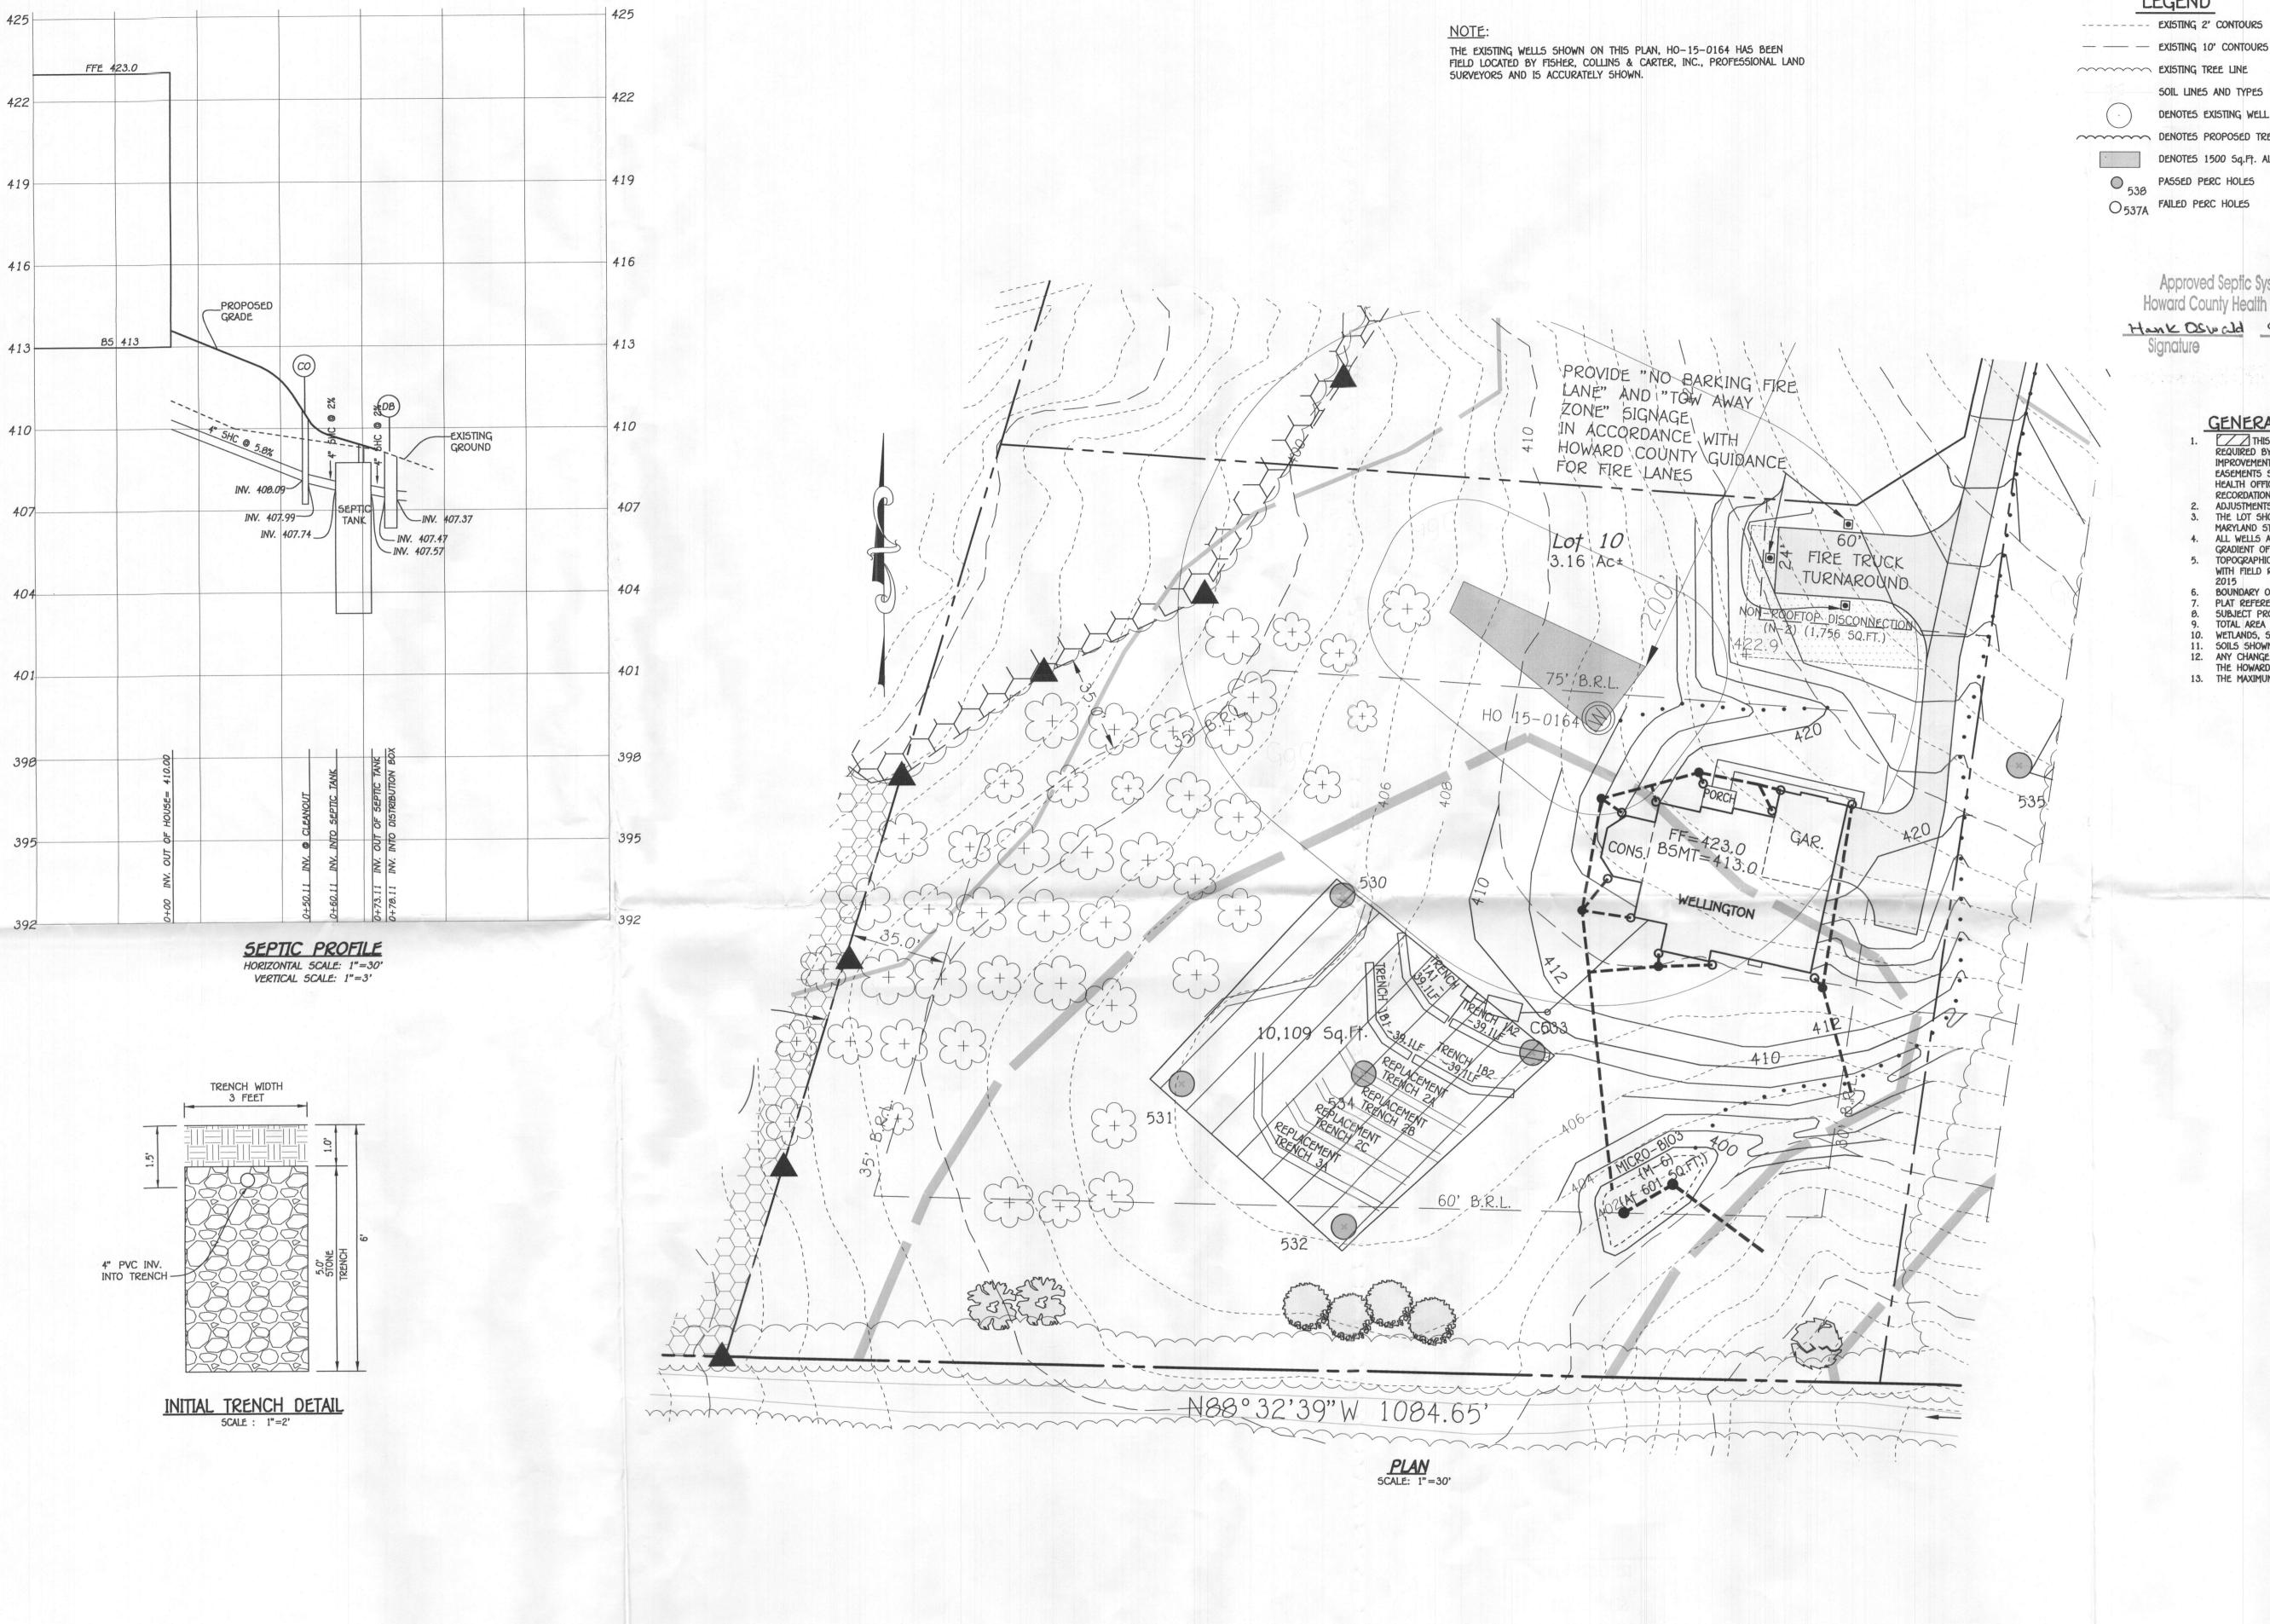

TRENCH DESIGN

5.0'

5.0'

1.0'

1A1&1A2 408.1

406.8

406.3

181&182 407.8

TRENCH GROUND TOP OF PIPE INVERT DEPTH TO STONE DEPTH OF BOTTOM OF EFFECTIVE DEPTH EFFECTIVE WIDTH OF TRENCH STARTS AT DEPTH (D) TRENCHES (W) SPACING

402.1

401.8

3.0'

3.0'

10'

10'

LEGEND

---- EXISTING 2' CONTOURS

EXISTING TREE LINE


SOIL LINES AND TYPES

DENOTES EXISTING WELL

DENOTES PROPOSED TREELINE DENOTES 1500 Sq.Ft. ALTERNATE WELL SITE

PASSED PERC HOLES O537A FAILED PERC HOLES

Hank Oswald 9/14/18

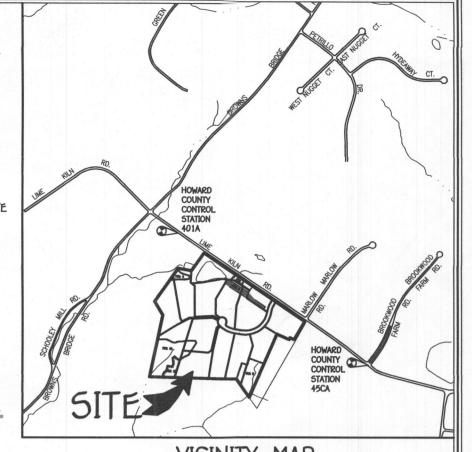

VICINITY MAP SCALE : 1" = 1200'

GENERAL NOTES:

THIS AREA DESIGNATES A PRIVATE SEWERAGE EASEMENT OF AT LEAST 10,000 SQUARE FEET AS REQUIRED BY THE MARYLAND STATE DEPARTMENT OF THE ENVIRONMENT FOR INDIVIDUAL SEWERAGE DISPOSAL. IMPROVEMENTS OF ANY NATURE IN THIS AREA ARE RESTRICTED UNTIL PUBLIC SEWERAGE IS AVAILABLE. THESE EASEMENTS SHALL BECOME NULL AND VOID UPON CONNECTION TO A PUBLIC SEWERAGE SYSTEM. THE COUNTY HEALTH OFFICER SHALL HAVE THE AUTHORITY TO GRANT ADJUSTMENTS TO THE PRIVATE SEWERAGE EASEMENT. RECORDATION OF A MODIFIED SEWERAGE EASEMENT SHALL NOT BE NECESSARY. ADJUSTMENTS TO SEPTIC EASEMENT AREA IS NOT PERMITTED WITHOUT ADDITIONAL TESTING.

THE LOT SHOWN HEREON COMPLIES WITH THE MINIMUM OWNERSHIP WIDTH AND LOT AREA AS REQUIRED BY THE MARYLAND STATE DEPARTMENT OF THE ENVIRONMENT.

4. ALL WELLS AND SEPTIC SYSTEMS WITHIN 100 FEET OF THE PROPERTY BOUNDARIES AND 200 FEET DOWN GRADIENT OF ANY WELLS AND/OR SEPTIC SYSTEMS HAVE BEEN SHOWN. TOPOGRAPHIC CONTOURS BASED ON HARFORD AERIAL SURVEYS, INC. DATED JANUARY 2006 AND SUPPLEMENTED

WITH FIELD RUN TOPOGRAPHY BY FISHER, COLLINS & CARTER, INC ON OR ABOUT APRIL, 2006 AND JANUARY,

BOUNDARY OF LOT BASED ON PLAT #23906 AND FIELD SURVEY BY FISHER, COLLINS & CARTER, INC. PLAT REFERENCE: 23895 THRU 23987 SUBJECT PROPERTY ZONED: RR-DEO

TOTAL AREA OF PROPERTY: 3.16 AC.

WETLANDS, STREAMS, THEIR BUFFERS, FLOODPLAIN, AND STEEP SLOPES DO NOT EXIST ON THIS LOT. 11. SOILS SHOWN HEREON ARE BASED ON NRCS WEB SOIL SURVEY AND HOWARD COUNTY SOILS MAP 3.

ANY CHANGE TO THE LOCATIONS OR DEPTHS TO ANY COMPONENTS MUST BE APPROVED BY THE ENGINEER AND THE HOWARD COUNTY HEALTH DEPARTMENT PRIOR TO INSTALLATION. A REVISED SITE PLAN MAY BE REQUIRED.

13. THE MAXIMUM EARTH COVER OVER THE TANK IS 3 FEET.

FFE 423.0 BSE 413.0 INV. OUT OF HOUSE = 410.00PROP. GROUND AT CLEANOUT =410.5 INV. INTO CLEANOUT = 407.50 INV. OUT OF CLEANOUT = 405.57 PROP. GROUND AT SEPTIC TANK = 409.28 COVER OVER TANK = 3 FEET TOP OF SEPTIC TANK = 406.28 INV. INTO SEPTIC TANK = 405.28 INV. OUT OF SEPTIC TANK = 405.11 EX. GROUND AT DISTRIBUTION BOX = 408.95 INV. INTO DISTRIBUTION BOX = 405.00 INV. OUT OF DISTRIBUTION BOX = 404.80

SEWAGE DISPOSAL SYSTEM DATA - INITIAL SYSTEM 6 BEDROOMS LOADING RATE = 6 BEDROOMS X 150 GPD/BEDROOM = 900 GPD APPLICATION RATE = 1.2 EFFECTIVE SIDEWALL BEGINS AT 4 FEET TRENCH DEPTH = 6 FEET TRENCH WIDTH (W) = 3 FEET EFFECTIVE DEPTH (D) = 2 FEET SF OF DRAINFIELD = 900 GPD / 1.2 = 750 SF COEFFICIENT OF REDUCTION OF TRENCH LENGTH = (W+2)/(W+1+2D)=(3+2)/(3+1+(2x2)=0.625TRENCH LENGTH = 750 SF x 0.625 / 3 = 156.3 FEET TRENCH SPACING = 2D+W = ((2\*2) + 3) = 7' USE 10'

SEWAGE DISPOSAL SYSTEM DATA - 15T REPLACEMENT SYSTEM 6 BEDROOMS LOADING RATE = 6 BEDROOMS X 150 GPD/BEDROOM = 900 GPD APPLICATION RATE = 1.2 EFFECTIVE SIDEWALL BEGINS AT 4 FEET TRENCH DEPTH = 6 FEET TRENCH WIDTH (W) = 3 FEET EFFECTIVE DEPTH (D) = 2 FEET SF OF DRAINFIELD = 900 GPD / 1.2 = 750 SF COEFFICIENT OF REDUCTION OF TRENCH LENGTH = (W+2)/(W+1+2D)=(3+2)/(3+1+(2x2)=0.625TRENCH LENGTH = 750 SF x 0.625 / 3 = 156.3 FEETTRENCH SPACING = 2D+W = ((2\*2) + 3) = 7' USE 10'

SEWAGE DISPOSAL SYSTEM DATA - 2ND REPLACEMENT SYSTEM 6 BEDROOMS LOADING RATE = 6 BEDROOMS X 150 GPD/BEDROOM = 900 GPD APPLICATION RATE = 1.2 EFFECTIVE SIDEWALL BEGINS AT 4 FEET TRENCH DEPTH = 6 FEET TRENCH WIDTH (W) = 3 FEET EFFECTIVE DEPTH (D) = 2 FEET SF OF DRAINFIELD = 900 GPD / 1.2 = 750 SF COEFFICIENT OF REDUCTION OF TRENCH LENGTH = (W+2)/(W+1+2D)=(3+2)/(3+1+(2x2)=0.625TRENCH LENGTH = 750 SF x 0.625 / 3 = 156.3 FEETTRENCH SPACING = 2D+W = ((2\*2) + 3) = 7' USE 10'

PROFESSIONAL CERTIFICATION

I HEREBY CERTIFY THAT THESE DOCUMENTS WERE PREPARED OR APPROVED BY ME AND THAT I AM A DULY LICENSED PROFESSIONAL ENGINEER UNDER THE LAWS OF THE STATE OF MARYLAND, LICENSE NO. 38386, EXPIRATION DATE: 01/12/2020.






SEPTIC PLAN WESTLAND FARM ESTATES LOT 10

12529 WESTLAND COURT TAX MAP #45 PARCEL: 28 ZONED: RR-DEO THIRD ELECTION DISTRICT HOWARD COUNTY, MARYLAND SCALE: AS SHOWN DATE: SEPTEMBER, 2018

FISHER, COLLINS & CARTER, INC.
CIVIL ENGINEERING CONSULTANTS & LAND SURVEYORS SQUARE OFFICE PARK - 10272 BALTIMORE NATIONAL PI ELLICOTT CITY, MARYLAND 21042

SCALE: 1" = 30'

OWNER WILLIAMSBURG GROUP, LLC C/O BOB CORBETT 5485 HARPERS FARM ROAD, SUITE 200 COLUMBIA, MARYLAND 21044 410-997-8600

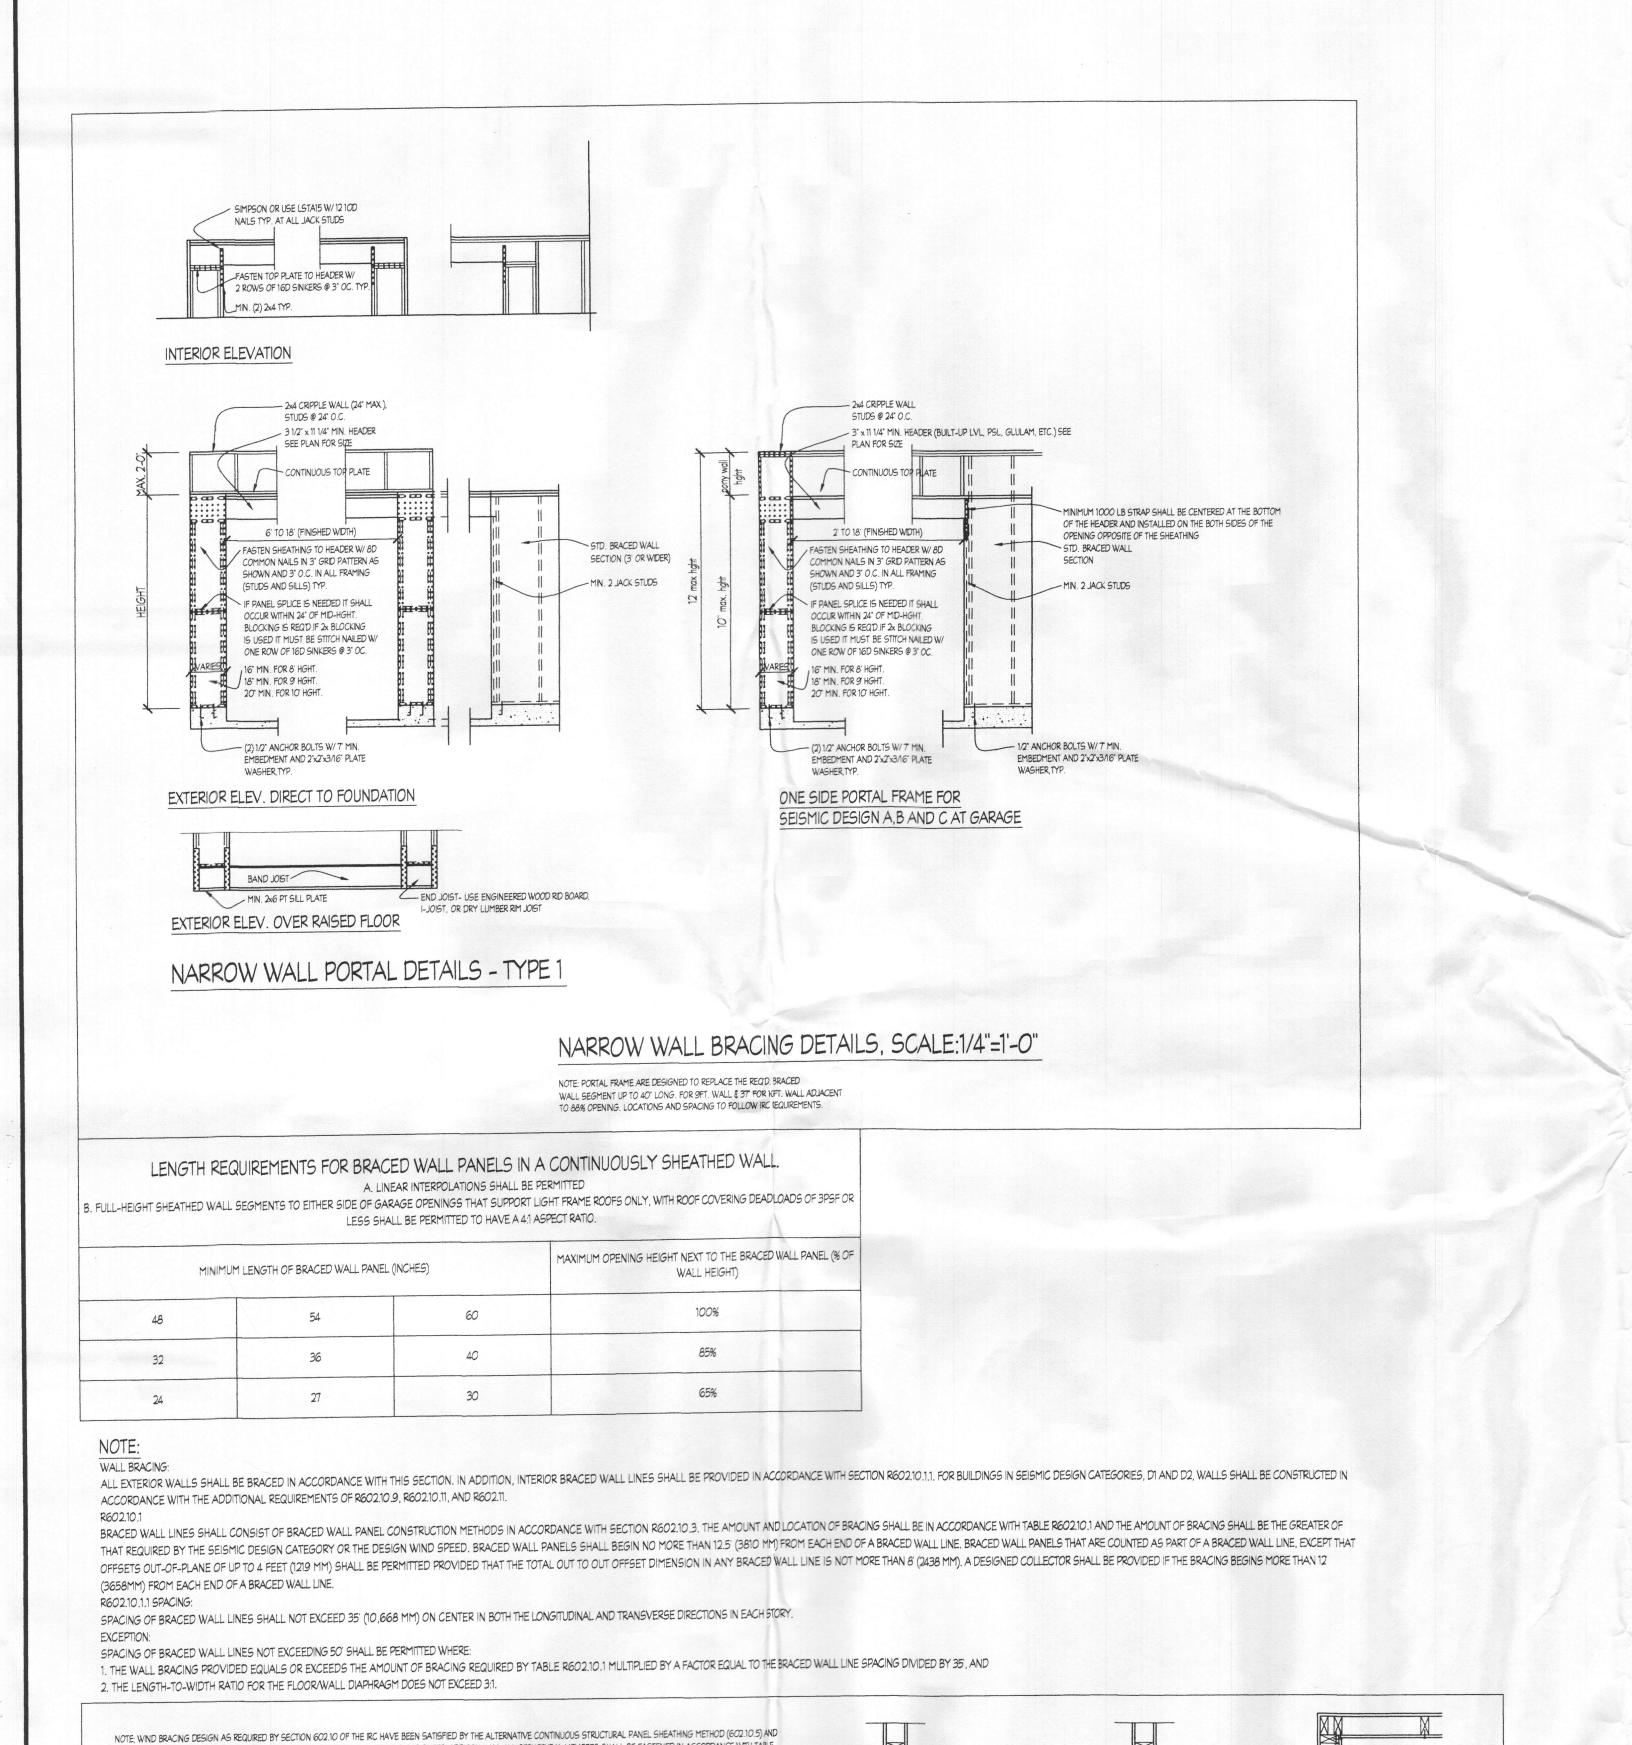

- 16D NAIL @ 12" O.C.

SHTG. ATTACHED W/8D NAILS @ 6" O.C. AT PANEL

EDGES AND 12 O.C. IN THE FIELD

not to scale

INSIDE CORNER DETAIL

--- 16D NAIL @ 12" O.C.

SHTG. ATTACHED W/8D NAILS @ 6" O.C. AT PANEL

GARAGE CORNER DETAIL

EDGES AND 12" O.C. IN THE FIELD

not to scale

- 16D NAIL @ 12" O.C.

SHTG. ATTACHED W/ 8D NAILS @ 6" O.C. AT PANEL

OUTSIDE CORNER DETAIL

EDGES AND 12" O.C. IN THE FIELD

not to scale

NARROW WALL (PORTAL FRAME) BRACING. REFER TO MIN. CONSTRUCTION DETAILS THIS SHEET. ADDITIONALLY, ALL STRUCTURAL MEMBERS SHALL BE FASTENED IN ACCORDANCE WITH TABLE R602.3(1) OF THE INTERNATIONAL RESIDENTIAL CODE, AND THE MANUFACTURERS' RECOMMENDATIONS IN THE CASE OF ENGINEERED COMPONENTS. MINIMUM BRACED WALL LENGTHS ARE BASED ON

ALL BRACED EXTERIOR WALLS SHALL BE MIN. 7/16" OSB PANEL SHEATHING ATTACHED TO FRAMING WITH 8d COMMON NAILS 2 6" O.C. AT PANEL EDGES AND 12" OC. AT INTERMEDIATE FRAMING MEMBERS. SOLE PLATES SHALL BE FASTENED TO JOIST OR SOLID BLOCKING WITH (3)16d NAILS @ 16" O.C., RIMJOIST TO PLATE OR SILL W/ 8d 2 6" O.C., TOENAIL. ALL EXTERIOR WALL CORNERS

SHALL BE FRAMED PER DETAIL. INTERIOR BRACED WALLS SHALL BE MIN. 1/2" GYP. BD. APPLIED TO EACH SIDE OF FRAMING W/ ADHESIVE AND S OR W SCREWS @ 24" O.C.

WINDOW WINDOW WINDOW WINDOW DOOR W/10 TR W/20 TR

THE TABLE BELOW :

WALL HEIGHT

Line

