

Maura J. Rossman, M.D., Health Officer

# **Bureau of Environmental Health**

8930 Stanford Boulevard, Columbia, MD 21045 Main: 410-313-2640 | Fax: 410-313-2648 TDD 410-313-2323 | Toll Free 1-866-313-6300 www.hchealth.org


Facebook: www.facebook.com/hocohealth


RECEIPT	DATE: 5/12/2020 ONSITE SEWAGE DISPOSAL SYSTEM P 567391
APPROVAL	DATE: PERMIT: CONSTRUCTION
PROPERTY A	DDRESS: 1032 STEPPING PLACE, SYKESVILLE, MD 21784
	WALKER MEADOWS   LOT: _21   TAX ID: 03-601579
CONTRACTO	R: SOUTH CARROLL BACKHOE, INC. EMAIL:
	ADDRESS: 4410 SALEM BOTTOM ROAD, WESTMINSTER, MD 21157 PHONE: (410)875-4197
	WNER: NVR, INC. EMAIL: janastas@nvrinc.com
OWNER ADDR	ESS: 9720 PATUXENT WOODS DRIVE, COLUMBIA, MD 21046 PHONE: (410)379-5956
	IZE (GALLONS): 2000 TANK MANUFACTURER: Babylon Vault
PUMP MODEL	PUMP SIZE n.a. PUMP TANK CAPACITY: n.a.
	The state of the s
DISTRIBUTION	N SYSTEM: GRAVITY PRESSURE DOSED BEDROOMS: 6 APPLICATION RATE: 1.2
	LINEAR FEET REQUIRED: 168 INLET DEPTH: 2.0
TRENCHES:	TRENCH WIDTH: 2 MAXIMUM BOTTOM DEPTH: 6.0
	MINIMUM SPACE
LOCATION	PER APPROVED SITE PLAN. SEWAGE DISPOSAL AREA AND TANK LOCATIONS MUST BE STAKED BY LICENSED
LOCATION:	SURVEYOR PRIOR TO PRE-CONSTRUCTION INSPECTION.
NOTES:	INSTALL THE SHC WITH AT LEAST ONE CLEANOUT.
ISSUED BY:	R BRICKER ISSUE DATE: 5/29/2020 EXPIRATION DATE: 5/12/2021
NOTE: CONT	RACTOR MUST SCHEDULE A PRE-CONSTRUCTION INSPECTION PRIOR TO BEGINNING ANY INSTALLATION
NOTE: CONT	RACTOR MUST SCHEDULE AN INSPECTION AND GAIN APPROVAL OF ALL COMPONENTS PRIOR TO COVERING
NOTE: STONE NOTE: WATER	MUST BE APPROVED BY HEALTH DEPARTMENT AND GRAVEL TICKET MUST BE AVAILABLE FOR REVIEW.
	RTIGHT TANKS REQUIRED ARTS OF SEPTIC SYSTEM SHALL BE AT LEAST 100 FEET DOWNGRADIENT FROM ANY WATER WELL
NOTE: MANH	IOLE RISERS REQUIRED ON ALL SEPTIC TANKS AND PUMP CHAMBERS
NOTE: AN ELI	ECTRICAL PERMIT IS REQUIRED FOR INSTALLATION OF ANY ELECTRICAL COMPONENTS OF THE SYSTEM
	ELECTRICAL PERMIT ISSUED E n.a.
TO EN	RECOMMENDS SEPTIC TANKS, BAT, AND OTHER PRETREATMENT UNITS BE PUMPED AT A FREQUENCY ADEQUATE SURE THAT SOLIDS ARE NOT DISCHARGED TO THE DISPOSAL AREA
NEITHER	THE HOWARD COUNTY COUNCIL NOR THE HEALTH DEPARTMENT IS RESPONSIBLE FOR THE
	CITCESCELLI ODEDATION OF ANY CYCETA


SUCCESSFUL OPERATION OF ANY SYSTEM.

PERMITTEE RESPONSIBLE FOR OBTAINING FINAL APPROVAL ON THIS PERMIT. CALL 410-313-1771 TO SCHEDULE INSPECTIONS.

	Stepping Place	TO THE PROPERTY OF THE PROPERT
216	House NOT TO SCALE 1"=  House 122' NOT TO SCALE 1"=  127' 125' 33' 35' 35' 35' 35' 35' 35' 35' 35' 3	TRENCH/DRAINFIELD DATA WIDTH INLET BOTTOM  2' 2' (6'    NUMBER OF TRENCHES 4
	ut tank and trenches acce	
SHE S 6/4/20 Yet, Abox levelers or to fackfill.	good stone looks good applicative to be	one trench complete. Reinspect for or k complete but SHC not done ic in place, other votion pipes in place.
FINAL INSPECTOR		ATE OF APPROVAL

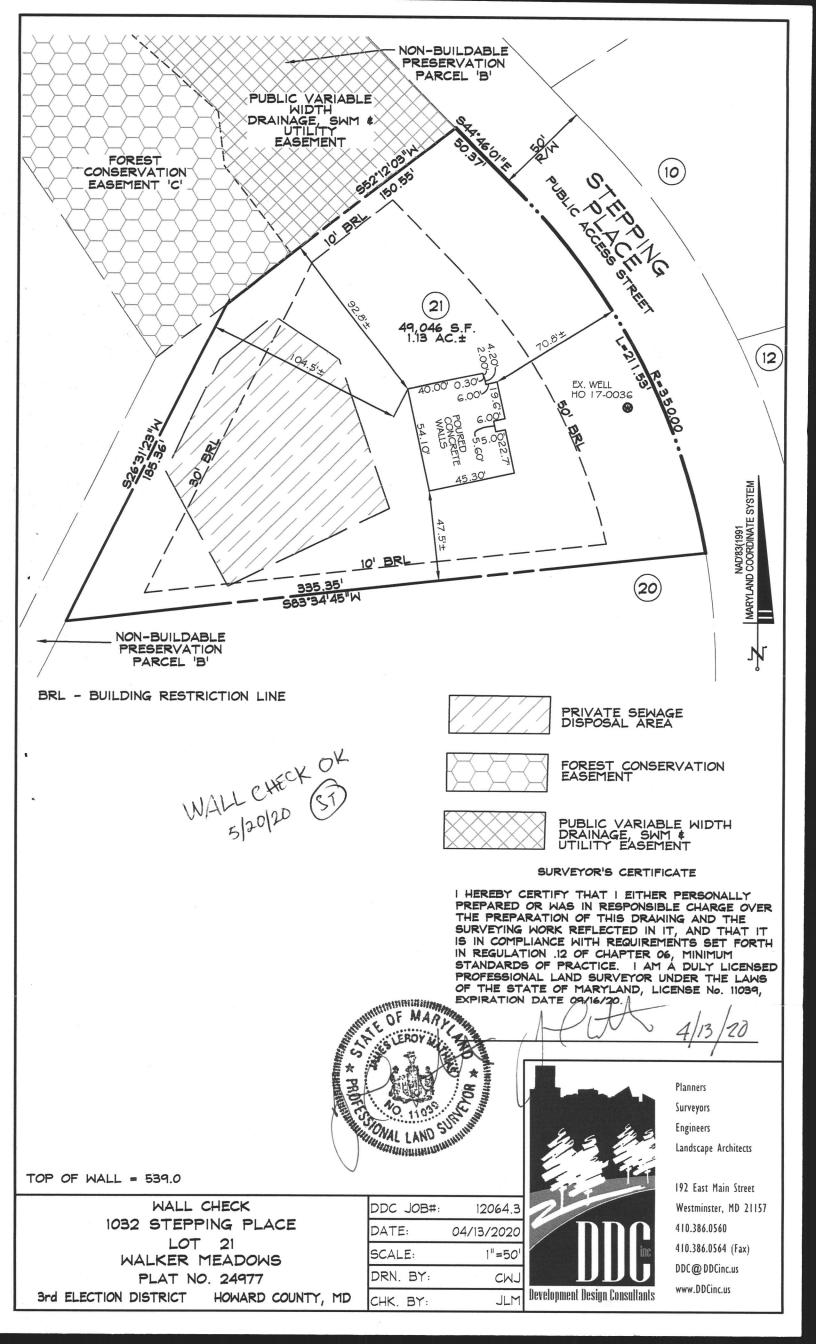

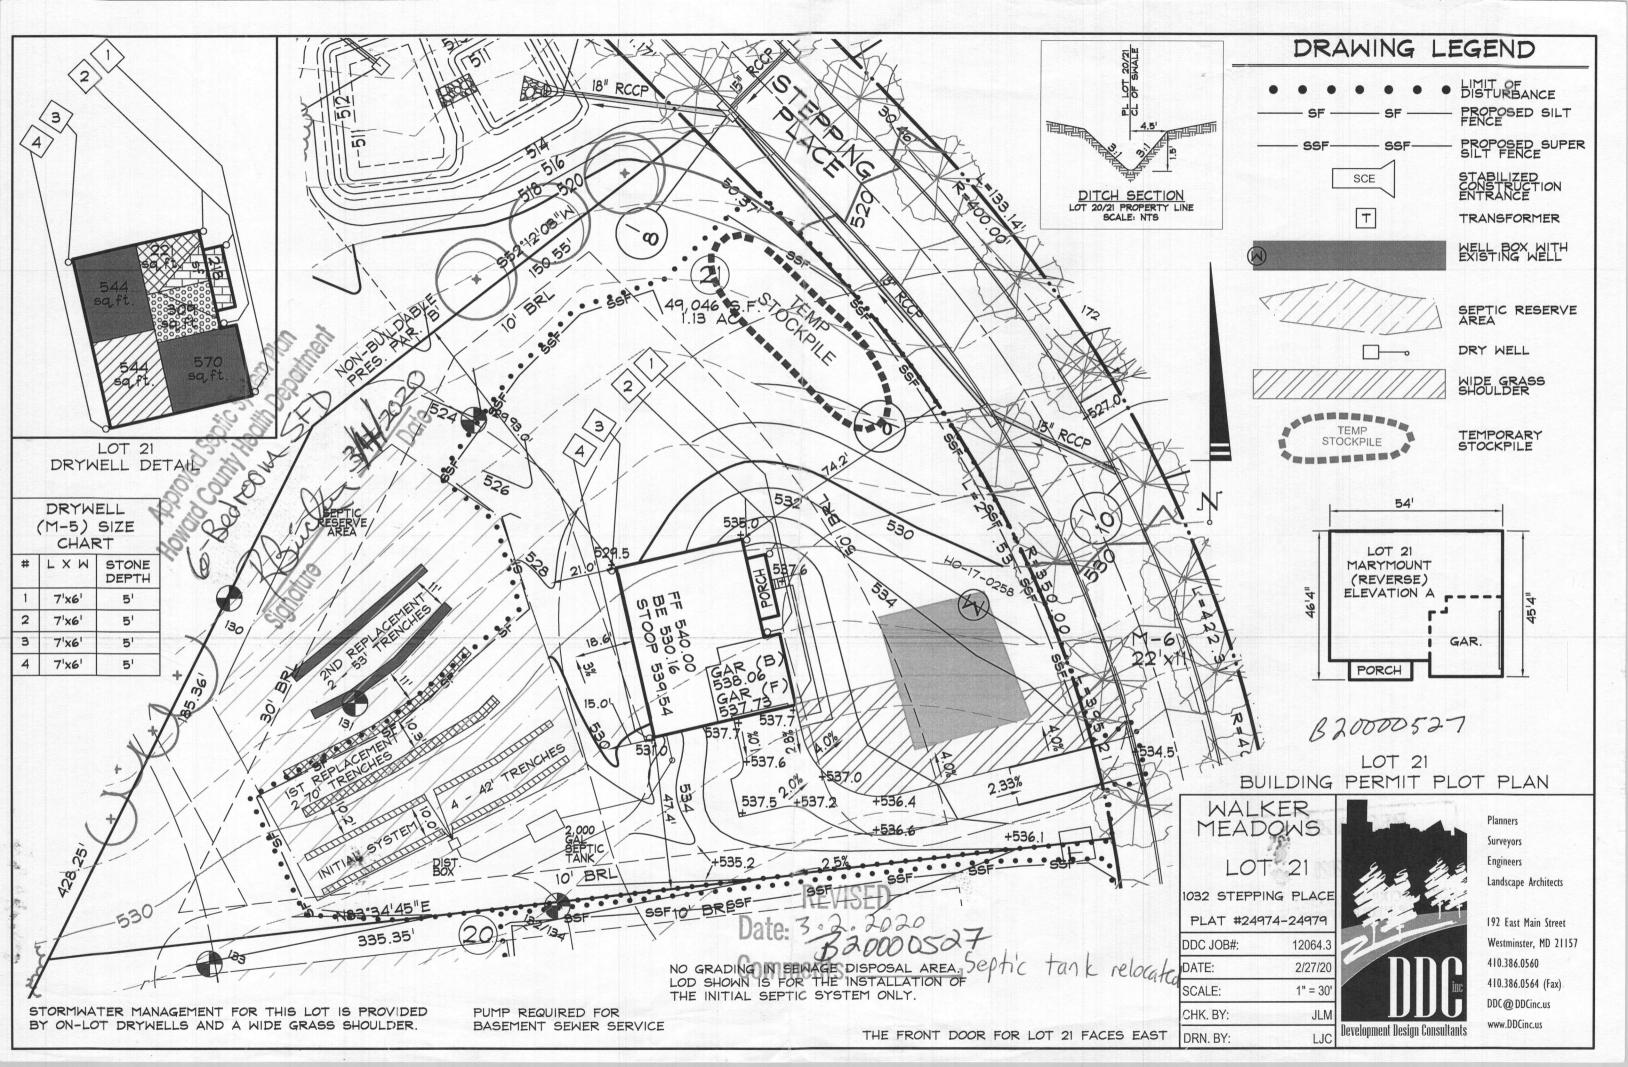

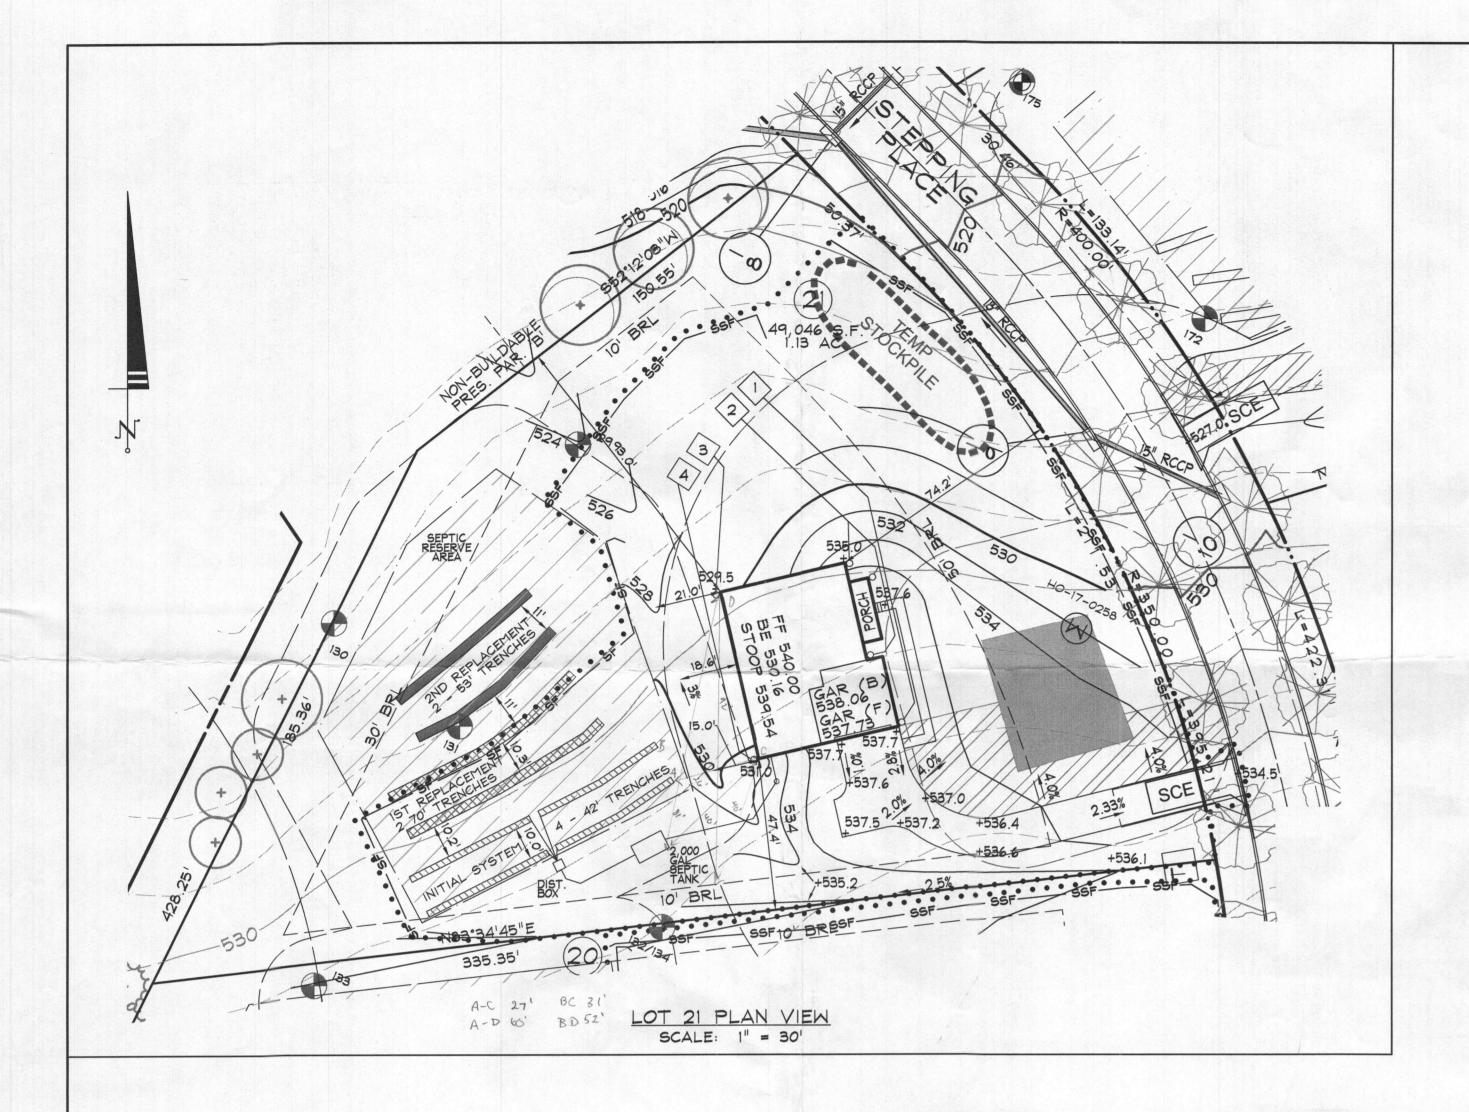

WELL BOX WITH

SEWAGE DISPOSAL

DRY WELL

WIDE GRASS SHOULDER


TEMPORARY

DRAWING LEGEND

TRANSFORMER

IMIT OF DISTURBANCE

SCE

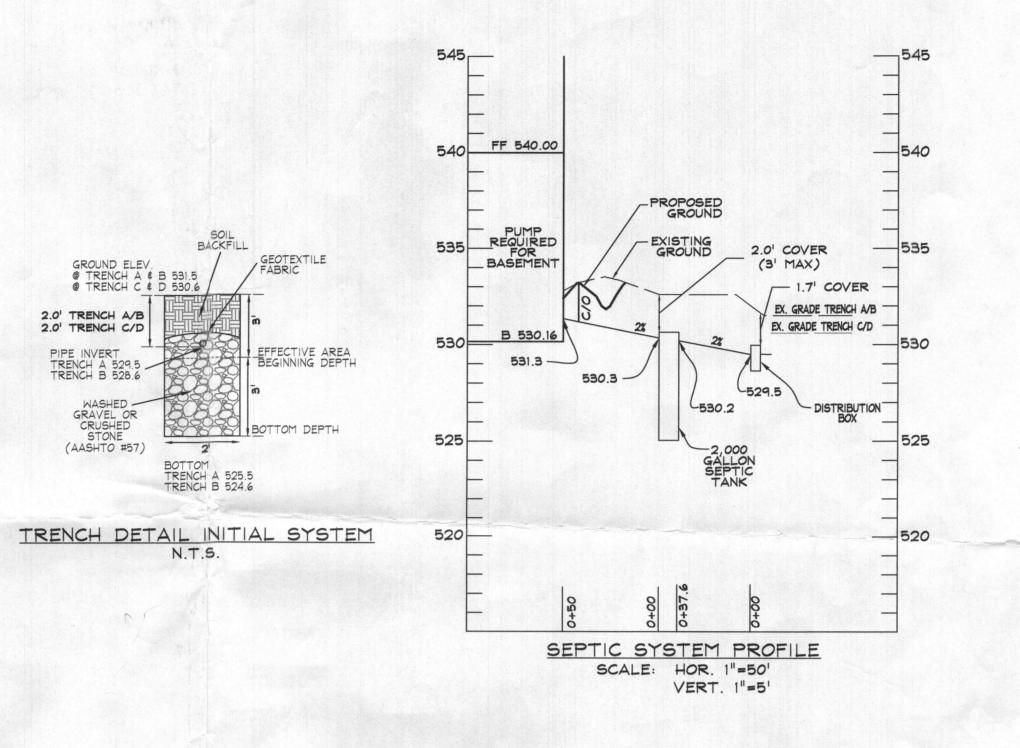

	201 21	ELATIVE DEPTHS	property of \$2.00 property and the control of the c
	PIPE INVERT	EFFECTIVE AREA BEGINNING	MAXIMUM TRENCH BOTTOM
INITIAL SYSTEM TRENCH A & B	21	3'	61
INITIAL SYSTEM TRENCH C & D	21	3'	61
IST REPLACEMENT TRENCH A	21	3.51	6'
IST REPLACEMENT TRENCH B	21	3.5'	6'
2ND REPLACEMENT TRENCH A	21	21	61
2ND REPLACEMENT TRENCH B	21	2'	61

LO	T 21 - APPR	OXIMATE ELEV	ATIONS
	GROUND ELEVATION	INVERT ELEVATION	BOTTOM ELEVATION
INITIAL SYSTEM TRENCH A & B	531.5	529.5	525.5
INITIAL SYSTEM TRENCH C & D	530.6	528.6	524.6
IST REPLACEMENT TRENCH A	529.8	527.8	523.8
IST REPLACEMENT TRENCH B	528.8	526.8	522.8
2ND REPLACEMENT TRENCH A	527.8	525.8	521.8
2ND REPLACEMENT TRENCH B	526.8	524.8	520.8

- 1. ANY CHANGE TO THE LOCATIONS OR DEPTHS TO ANY COMPONENTS MUST BE APPROVED BY THE ENGINEER AND THE HOWARD COUNTY HEALTH DEPARTMENT PRIOR TO INSTALLATION. A REVISED SITE PLAN MAY BE REQUIRED.
- 2. THE MAXIMUM EARTH COVER OVER THE TANK IS 3 FEET. GREATER COVER WILL REQUIRE A HEAVY LOAD BEARING
- 3. ELECTRICAL WORK FOR THE INSTALLATION MUST BE PERFORMED BY A LICENSED ELECTRICIAN.
- 4. THE WELL (TAG #HO-17-0258) HAS BEEN FIELD LOCATED AND IS ACCURATELY SHOWN.
- 5. ALL WELLS AND SEPTIC SYSTEMS LOCATED WITHIN 100' OF THE PROPERTY BOUNDARIES AND 200' DOWN GRADIENT OF ANY WELLS AND/OR SEPTIC SYSTEMS HAVE BEEN SHOWN.

# TRENCH LENGTH AND SPACING CALCULATIOS

TRENCH DESIGN (6 BDRM x 150 GPD/BDRM = 900 GPD)

INITIAL SYSTEM

900 GPD / 1.2 GPD/SF (APP. RATE) = 750 SF USE 2' WIDE TRENCH W/ 36" OF EFFECTIVE ABSORPTION DEPTH 750 SF / 2' WIDTH = 375 LF x 0.44 = 165 LF MIN. TRENCH - 10' MIN SPACING BETWEEN TRENCH EDGES

IST REPLACEMENT SYSTEM

900 GPD / 1.2 GPD/SF (APP. RATE) = 750 SF USE 3' WIDE TRENCH W/ 30" OF EFFECTIVE ABSORPTION DEPTH 750 SF / 3' WIDTH = 250 LF x 0.56 = 140 LF MIN. TRENCH - 10' MIN SPACING BETWEEN TRENCH EDGES

2ND REPLACEMENT SYSTEM 900 GPD / 1.2 GPD/SF (APP. RATE) = 750 SF USE 3' WIDE TRENCH W/ 48" OF EFFECTIVE ABSORPTION DEPTH 750 SF / 3' WIDTH = 250 LF x 0.42 = 105 LF MIN. TRENCH

- 10' MIN SPACING BETWEEN TRENCH EDGES

4 - 42' LONG TRENCHES FOR INITIAL SYSTEM 2 - 70' LONG TRENCHES FOR IST REPLACEMENT SYSTEM 4 - 53' LONG TRENCHES FOR SECOND REPLACEMENT SYSTEM

### DATA SOURCES:



192 East Main Street Westminster, MD 21157 410.386.0560 410.386.0564 (Fax)

Engineers

Landscape Architects

DDC@DDCinc.us

**DEVELOPER:** ESC WALKER MEADOWS, L.C.
5074 DORSEY HALL DR., SUITE 205
ELLICOTT CITY, MD 21042
410-720-3021

NV HOMES
9720 PATUXENT WOODS DRIVE
COLUMBIA, MD 21046
410-379-3391

SITE ADDRESS: S/E RIVER ROAD SYKESVILLE, MD 21784

WALKER MEADOWS

A RESUBDIVISION OF LOT 2 OF THE DIEHL PROPERTY (PLAT #6937)

LOTS 1-34 \$ BUILDABLE PRESERVATION PARCEL A \$ NON-BUILDABLE PRESERVATION PARCEL B-K, NON-BUILDABLE BULK PARCELS L-M 1032 STEPPING PLACE

LOT 21 ONSITE SEWAGE DISPOSAL SYSTEM DESIGN PLAN

LICENSE NO. 21998 EXPIRATION DATE: 6/6/20 2/26/20 DATE





WILLIAM R. DEMARIO

PROFESSIONAL ENGINEER NO. 21998

PROFESSIONAL CERTIFICATION
THEREBY CERTIFY THAT THESE DOCUMENTS WERE PREPARED
OR APPROVED BY ME, AND THAT I AM A DULY LICENSED
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OF MARY! AND REVISIONS DESCRIPTION OF CHANGES DRN. REV. DATE CO. FILE #: F-17-045 DES. BY: LJC TAX ACC. #: 03-601568 DRN. BY: LJC TAX MAP: 9 CHK. BY: WRD BLOCK / GRID: 6 DATE: 1/26/20 PARCEL #: 66 DDC JOB#: 12064.3 ZONE / USE: RR-DEO SHEET NUMBER: DWG. SCALE: 1" = 30' of

F-17-045

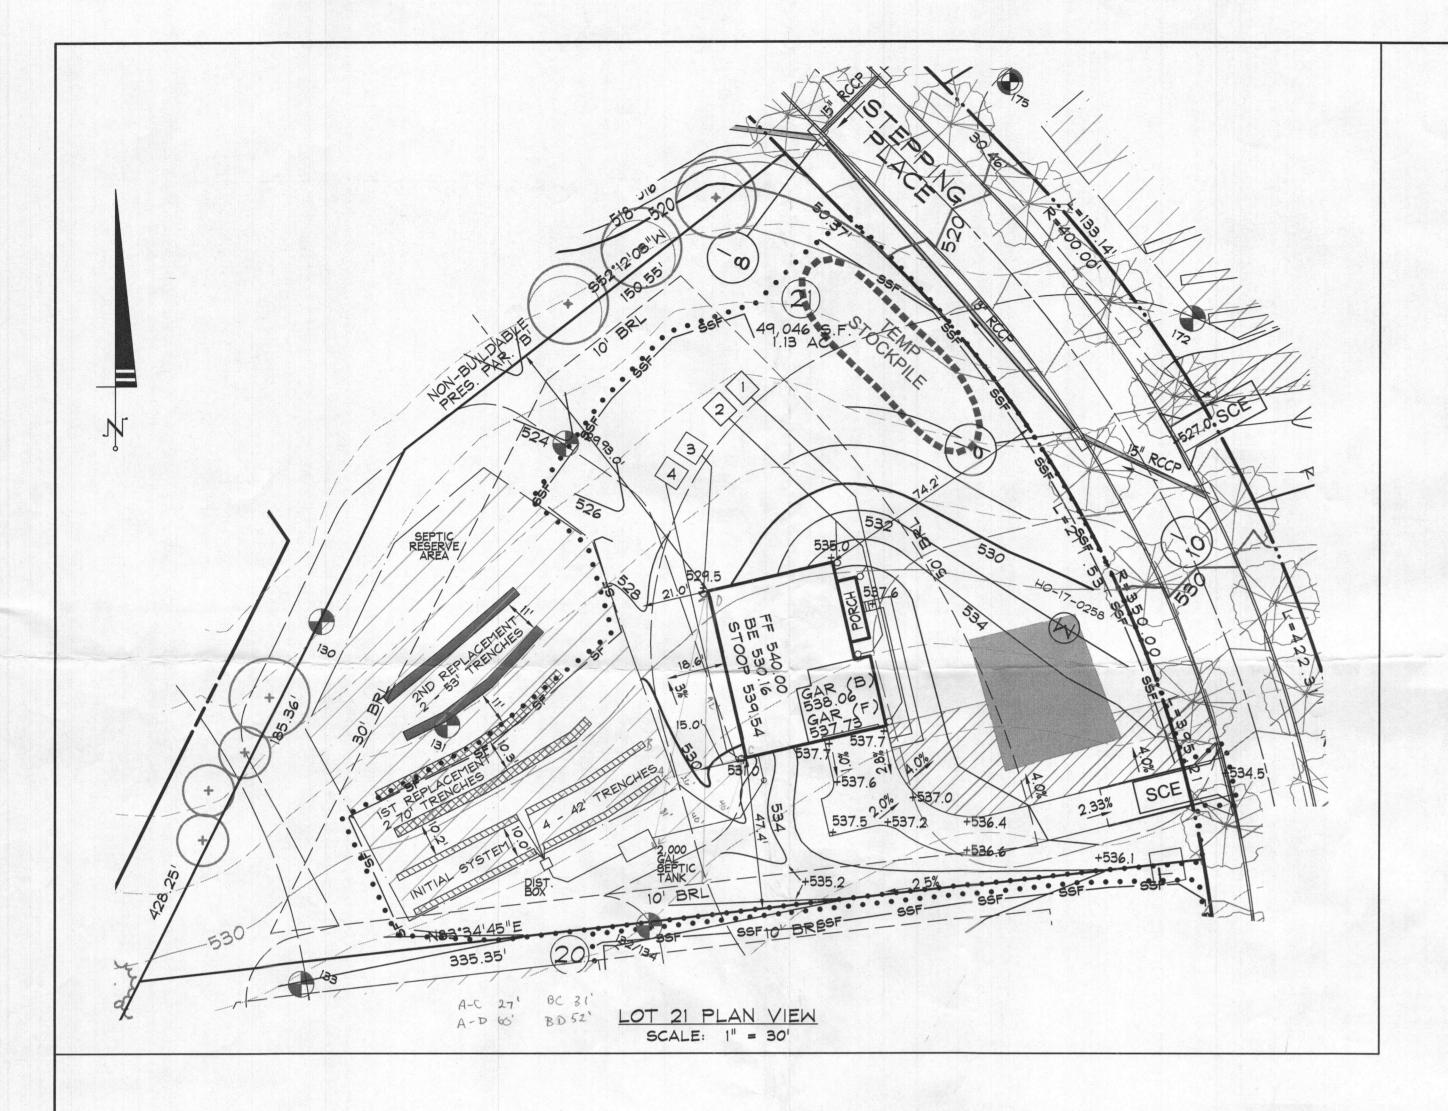

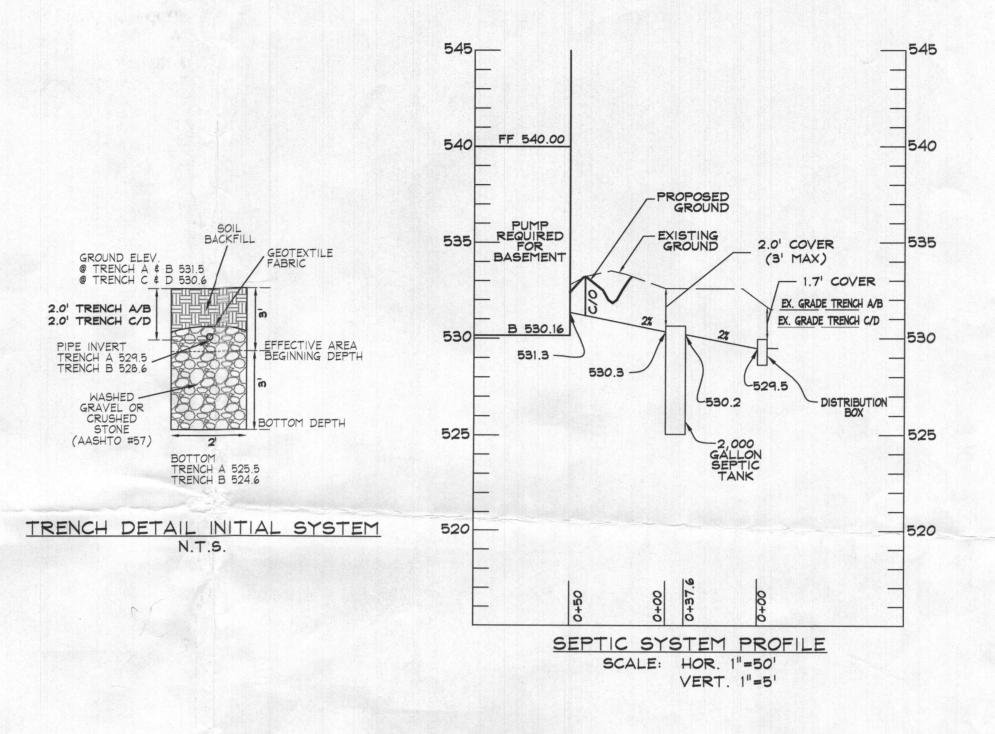

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	PIPE INVERT	EFFECTIVE AREA BEGINNING	MAXIMUM TRENCH BOTTOM
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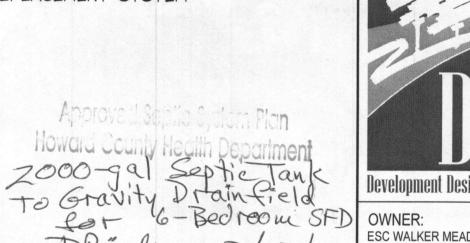
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**Development Design Consultants** 

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5TH COUNCIL DISTRICT



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