



He He	oward County ealth Department	893 TD F	Bureau of Environmenta 30 Stanford Boulevard, Columbia Main: 410-313-2640 Fax: 410- D 410-313-2323 Toll Free 1-86 www.hchealth.org acebook: www.facebook.com/h	a, MD 21045 313-2648 66-313-6300
Maura J.	Rossman, M.D., Health O	fficer		
RECEIPT	DATE: 10-62 ON	SITE SEWAGE DISPOSA	L SYSTEM	P 572811
APPROVAL	DATE: 11/9/20 50	PERMIT: CONST	RUCTION	Α
PROPERTY A		NG PLACE, SYKESVILLE, MD 21	784	
SUBDIVISION	WALKER MEADOWS	; 	LOT: 15 TAX ID:	03-3601573
CONTRACTO	R: _ SC Back	ve on	EMAIL:	
CONTRACTOR	ADDRESS: 4410 5	lem Botton KD	PH	ONE: 410-596-3618
PROPERTY O	WNER: NVR		EMAIL: janastas@I	nvrinc.com
OWNER ADDR	ESS: 9720 PATUKENT V	VOODS DRIVE, COLUMBIA, MD	21046 PHONE	: (410)379-5956
SEPTIC TANK S	IZE (GALLONS): 1500	TANK MANUFAC	TURER: BABYLON VA	ULT CO.
PUMP MODEL	:	PUMP SIZE n.a.	PUMP TANK CAPACIT	Y: n.a.
DISTRIBUTIO	N SYSTEM: 🛛 GRAV	ITY PRESSURE DOSED	BEDROOMS: <u>5</u> A	PPLICATION RATE: 1.2
	LINEAR FEET REQUIRED:	87	INLET DE	PTH: 2.0
TRENCHES:	TRENCH WIDTH:	3	MAXIMUM BOTTOM DE	PTH: 7.0
	MINIMUM SPACE BETWEEN TRENCHES:	11 FE	ECTIVE AREA BEGINNING DE	ртн. 3.0
LOCATION:	PER APPROVED SITE PLAI	N. SEWAGE DISPOSAL AREA AND T CONSTRUCTION INSPECTION.		
NOTES:	INSTALL CLEANOUT IN SH		A CONTINUOUS 87-FT TREN	сн
ISSUED BY:	R BRICKER	ISSUE DATE:	16-30-20 EXPIRATION	ON DATE: 10-6-21
NOTE: CONT	RACTOR MUST SCHEDULE	A PRE-CONSTRUCTION INSPECTIO	•	
		AN INSPECTION AND GAIN APPROV HEALTH DEPARTMENT AND GRAVE		
	ERTIGHT TANKS REQUIRED			
		ALL BE AT LEAST 100 FEET DOWNO		R WELL
		IRED FOR INSTALLATION OF ANY		OF THE SYSTEM
		D E n.a. NKS, BAT, AND OTHER PRETREATM OT DISCHARGED TO THE DISPOSA		A FREQUENCY ADEQUATE
		TY COUNCIL NOR THE HEAL		PONSIBLE FOR THE
	:	SUCCESSFUL OPERATION OF	ANY SYSTEM.	
		NSIBLE FOR OBTAINING FIN		PERMIT.
	CA	LL 410-313-1771 TO SCHEDU	LE INSPECTIONS.	

TRENCH/DRAINFIELD DATA NOT TO SCALE BOTTOM WIDTH INLET 3 7 NUMBER OF TRENCHES (CENTER FED) TOTAL LENGTH 87 = ABSORPTION AREA _261 SF DISTRIBUTION BOX LEVEL SPEED DISTRIBUTION BOX BAFFLE MES DISTRIBUTION BOX PORT _____ SEPTIC TANK DATA * see alloched diogram SEPTIC TANK I LEVEL yes MANUFACTURER Lon CAPACITY _ (500 GAL SEAM LOC top TANK LID DEPTH yes BAFFLES BAFFLE FILTER MANHOLE LOC front + bac 6" PORT LOC WATERTIGHT TEST YES SLOTTED____ DATE ON LID $8 \cdot 24 - 20$ PUMP/SEPTIC TANK LEVEL MANUFACTURER CAPACITY GAL SEAM LOC TANK LID DEPTH BAFFLES BAFFLE FILTER MANHOLE LOC 6" PORT LOC WATERTIGHT TEST SLOTTED DATE ON LID **ROAD NAME** PRE-CONSTRUCTION: 11/4/20 Laid out 1×87' long trench according to plan. There is 2" of fill on apper fourth of trench near house that will be scraped offices INSTALLATION: 11/5/2020 TANK, SEWER UNE, AND D BOX SET. PARTIAL TRENCH INSPECTION. REINSPECT D BUR AND ENCHES TRENCHES COMPLETE. D BOX LEVELED WI SPEED 6/2020 BACKFILL . (+ OK EVELS, DATE OF APPROVAL 11/09 2020 FINAL INSPECTOR

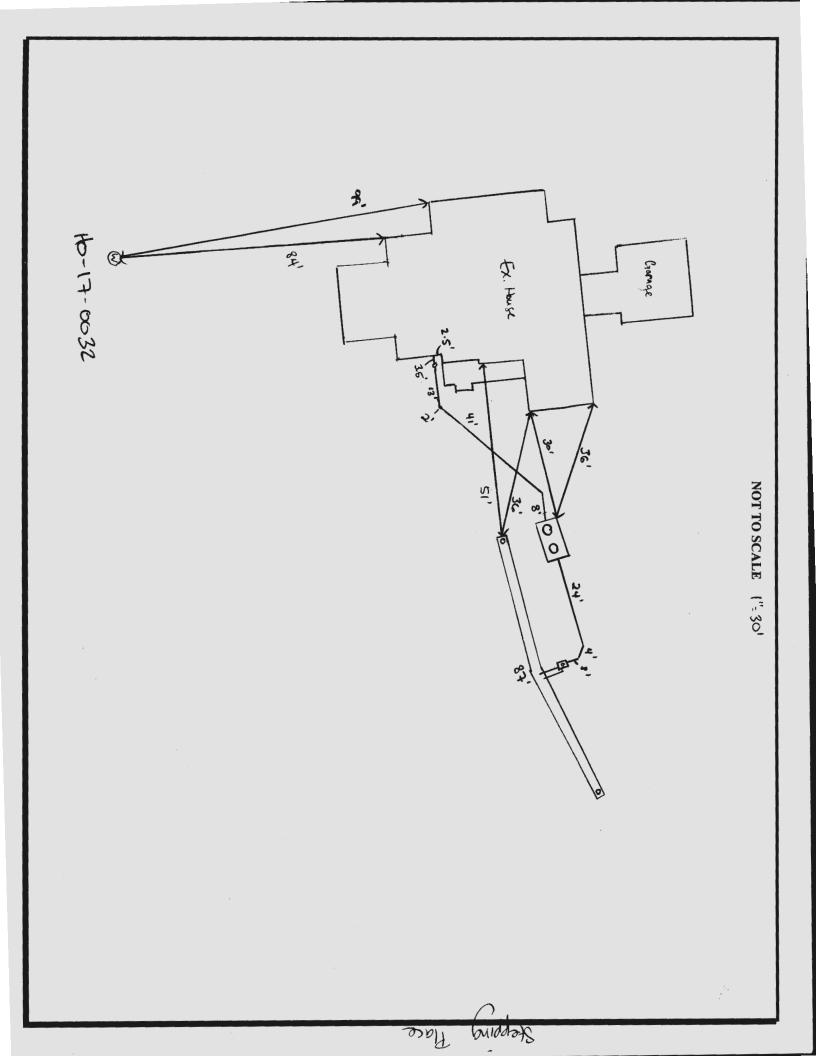

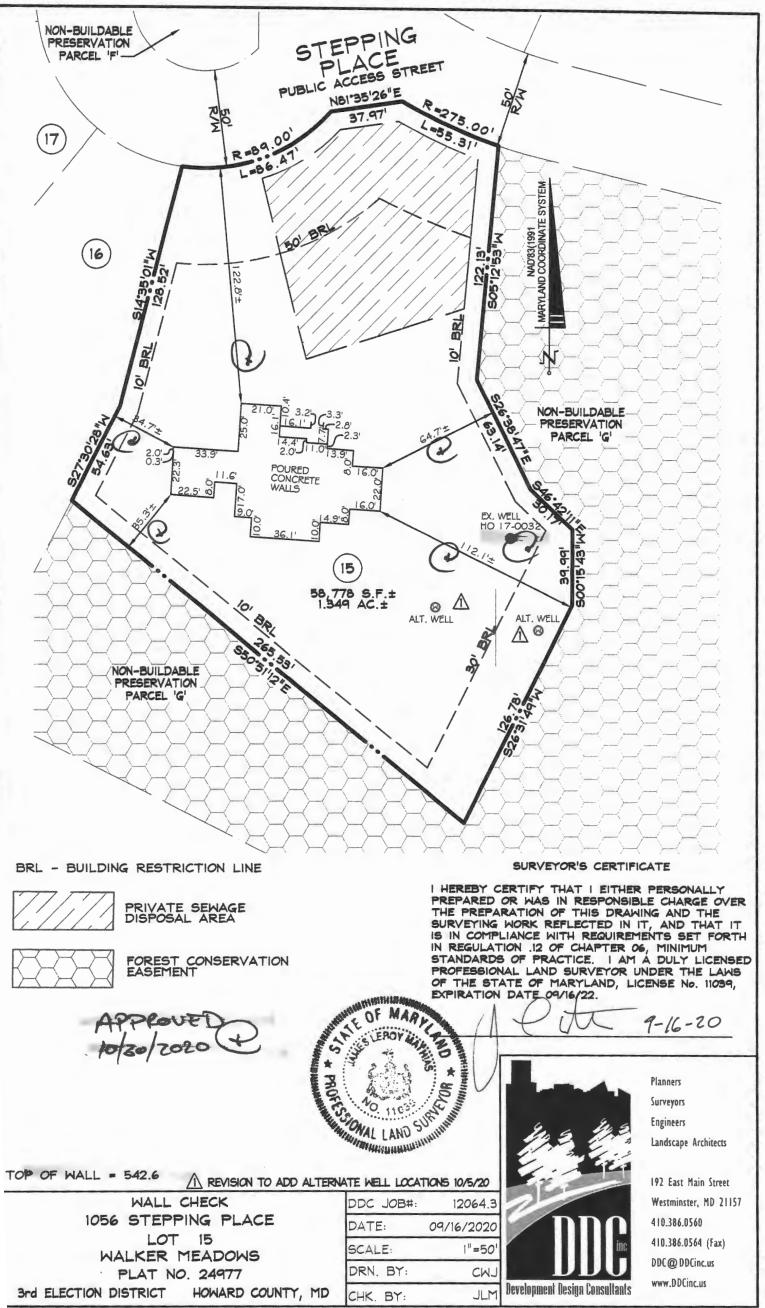

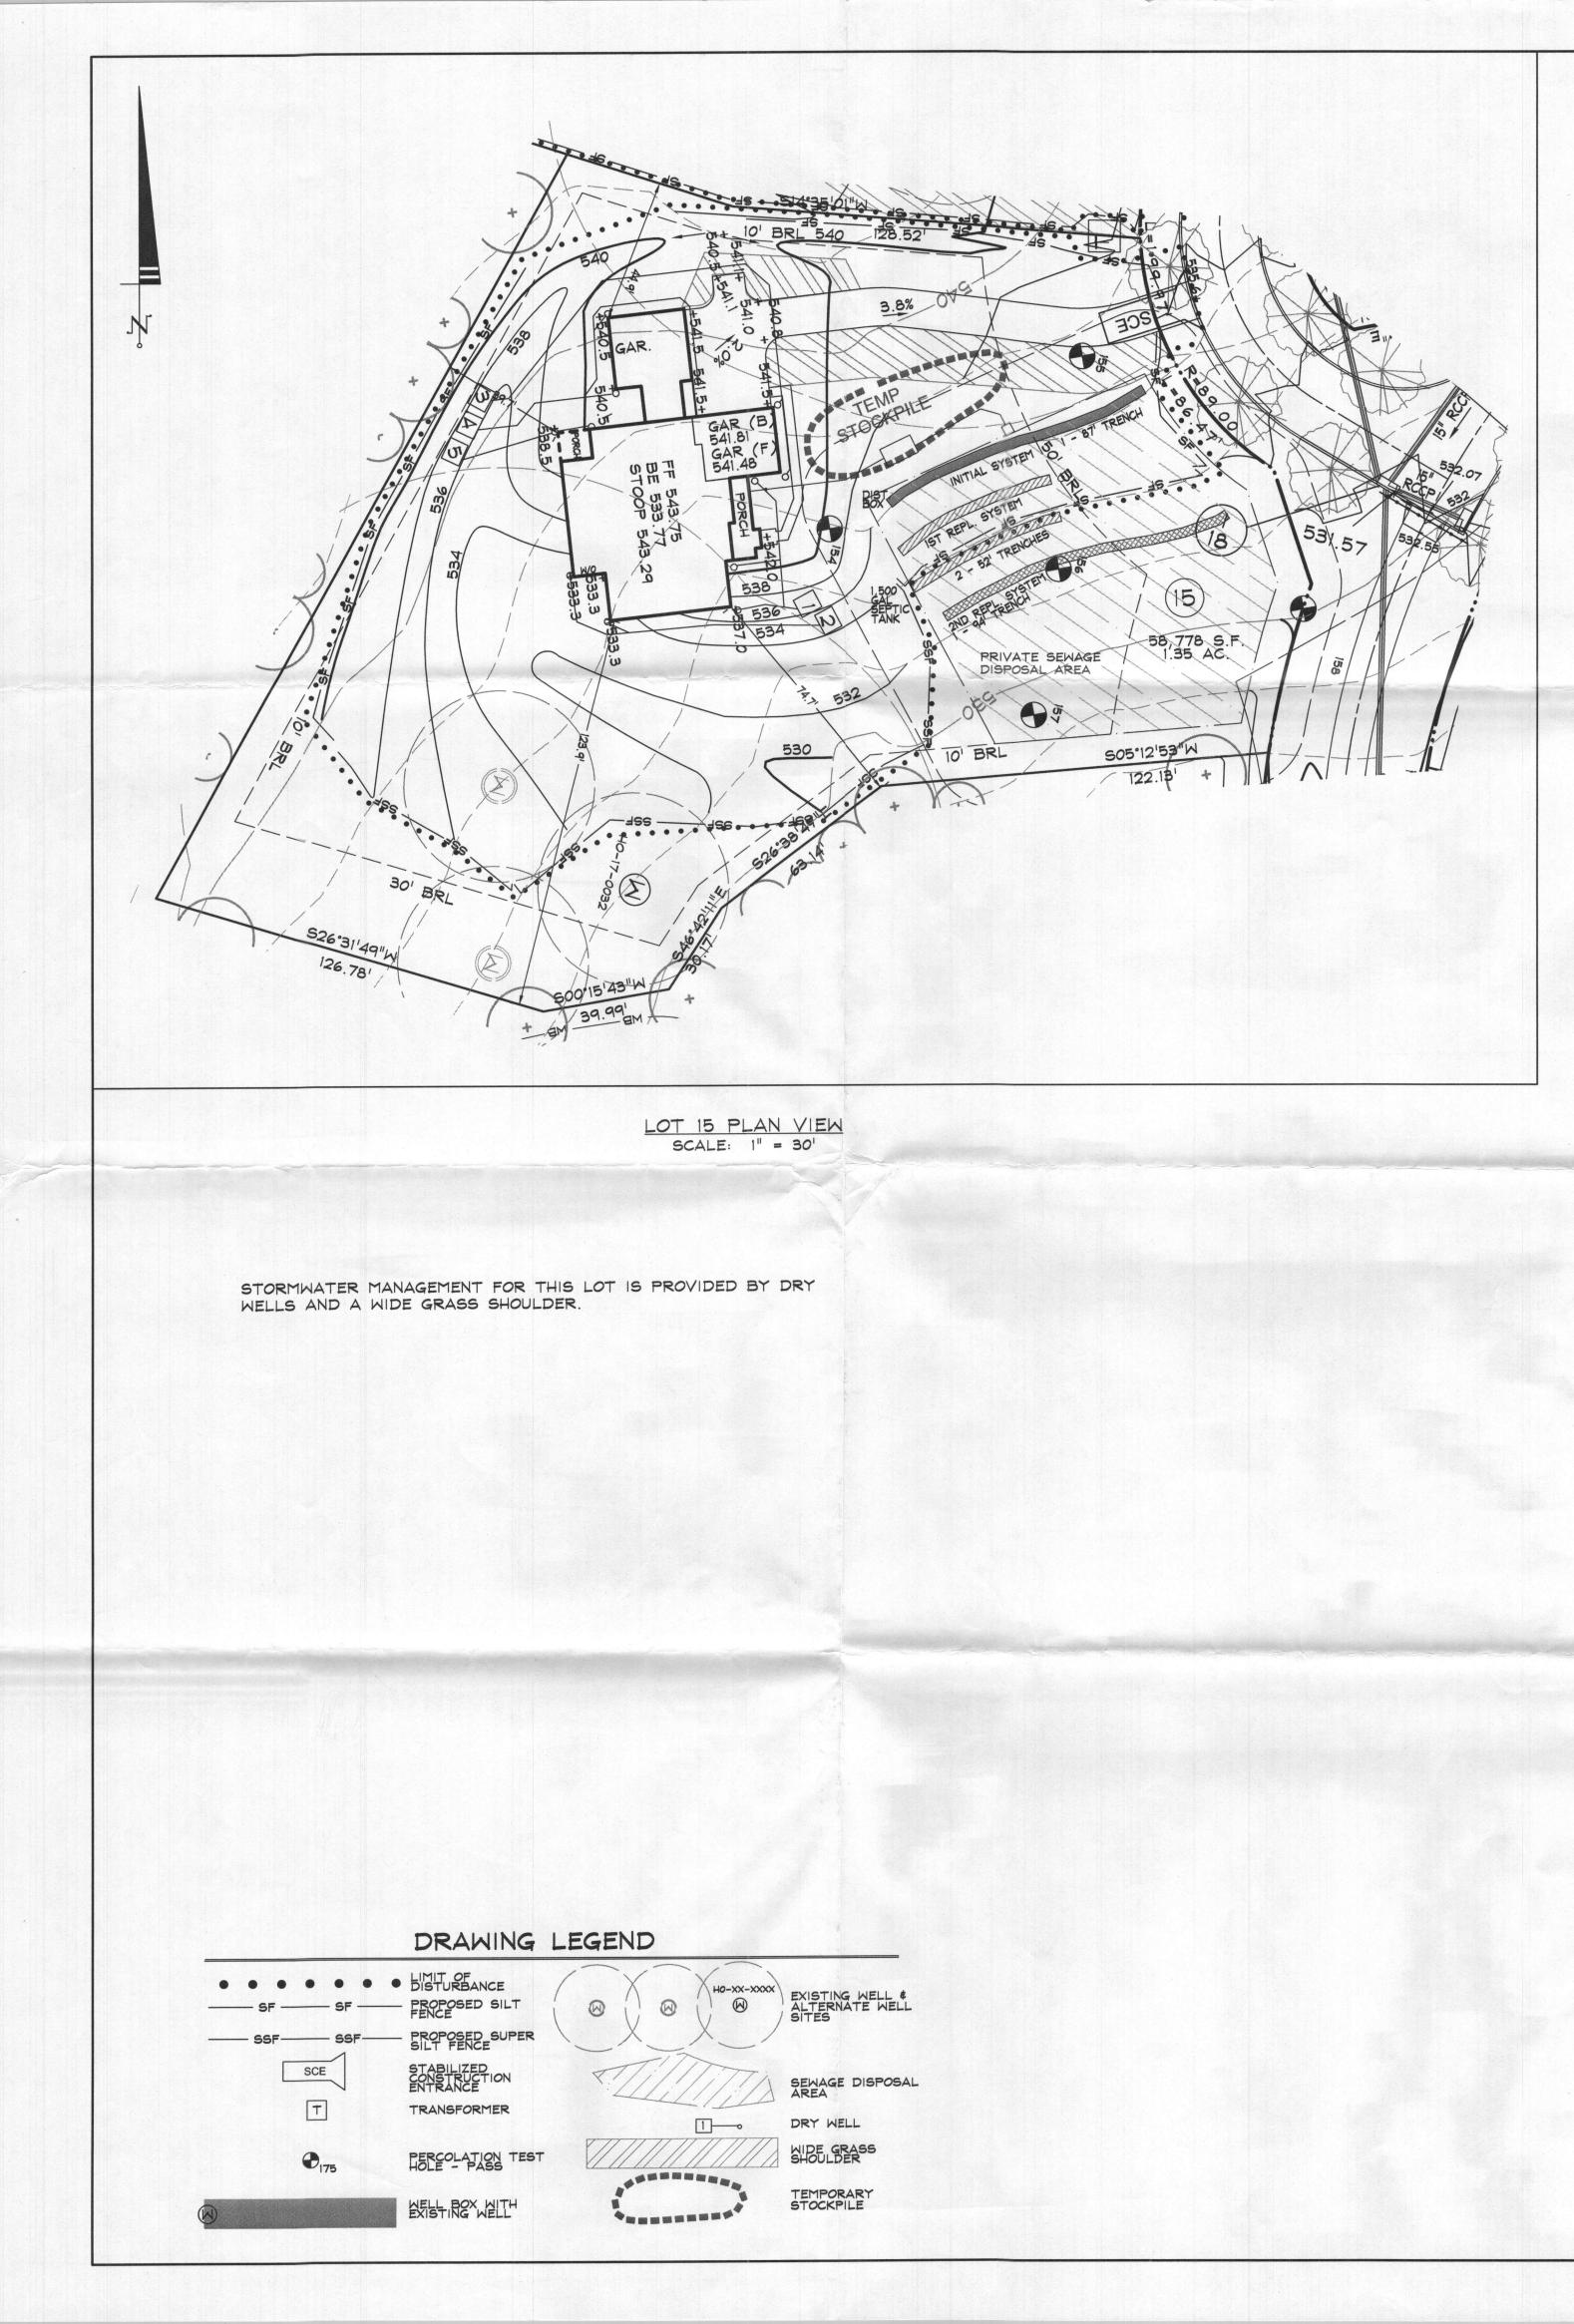

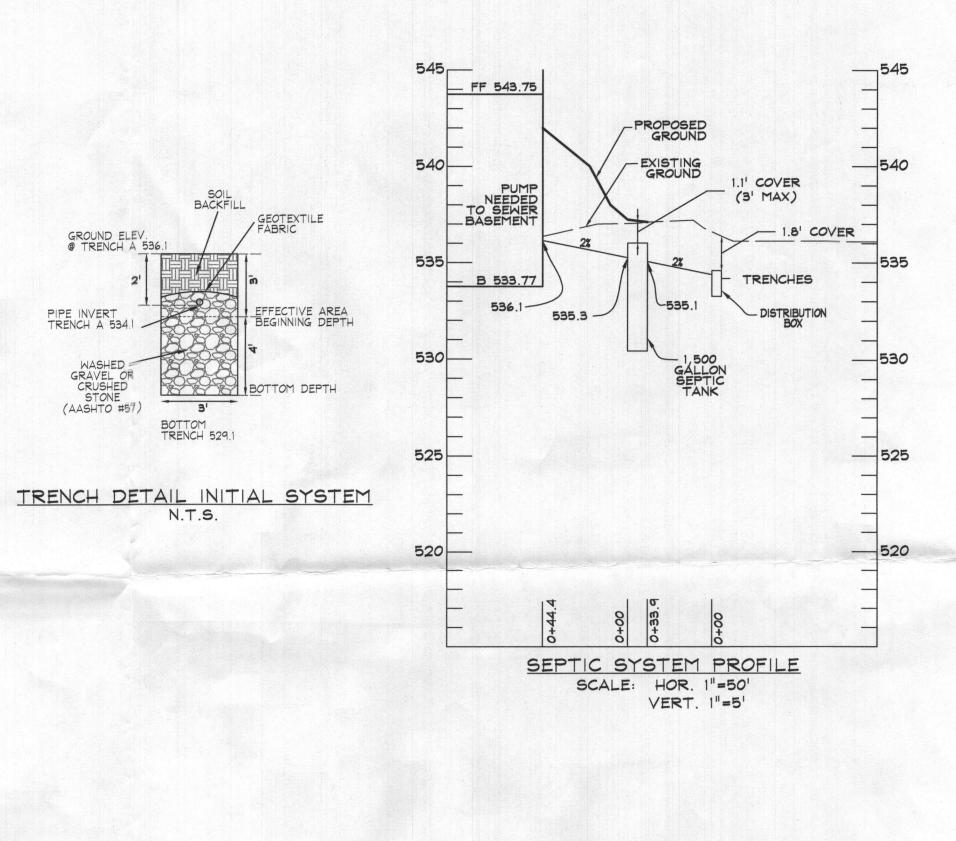

NOTES:

- 1. ANY CHANGE TO THE LOCATIONS OR DEPTHS TO ANY COMPONENTS MUST BE APPROVED BY THE ENGINEER AND THE HOWARD COUNTY HEALTH DEPARTMENT PRIOR TO INSTALLATION. A REVISED SITE PLAN MAY BE REQUIRED.
- 2. THE MAXIMUM EARTH COVER OVER THE TANK IS 3 FEET. GREATER COVER WILL REQUIRE A HEAVY LOAD BEARING TANK.
- 3. ELECTRICAL WORK FOR THE INSTALLATION MUST BE PERFORMED BY A LICENSED ELECTRICIAN.
- 4. THE WELL (TAG #HO-17-0032) HAS BEEN FIELD LOCATED AND IS ACCURATELY SHOWN.
- 5. ALL WELLS AND SEPTIC SYSTEMS LOCATED WITHIN 100' OF THE PROPERTY BOUNDARIES AND 200' DOWN GRADIENT OF ANY WELLS AND/OR SEPTIC SYSTEMS HAVE BEEN SHOWN.

TRENCH LENGTH AND SPACING CALCULATIOS TRENCH DESIGN (5 BDRM x 150 GPD/BDRM = 750 GPD) INITIAL SYSTEM & IST REPLACEMENT SYSTEM

750 GPD / 1.2 GPD/9 USE 3' WIDE TRENCH 625 SF / 3' WIDTH IST REPLACEMENT 750 GPD / 1.2 GPD/ USE 3' WIDE TRENCH 625 SF / 3' WIDTH

2ND REPLACEMENT 750 GPD / 1.2 GPD/ USE 3' WIDE TRENCH 625 SF / 3' WIDTH

10' MIN SPACING BET 1 - 87' LONG TRENCH 2 - 52' LONG TRENCH 1 - 94' LONG TRENCH

INSTALL INITIAL SYST

	DATA SOURCES.	
IST REPLACEMENT SYSTEM /SF (APP. RATE) = 625 SF CH W/ 48" OF EFFECTIVE AREA DEPTH = 208 LF x 0.42 = 87.5 LF MIN. TRENCH	EX. BOUNDARY SHOWN PE SHANABERGER AND LANE TOPOGRAPHY SHOWN PER AND FIELD RUN TOPOGRA ADJACENT WELL AND SEF APPROXIMATED FROM AD.	R BOUNDARY SURVEY BY DATED JUNE, 2014. AERIAL PHOTOGRAMMETRY PHY DATED 5/2014. TIC INFORMATION JACENT PLATS, HEALTH ND FIELD OBSERVATION ON ONMENTAL INFORMATION IGATION BY ECO-SCIENCE N OR ABOUT JUNE, 2014.
SYSTEM	JUNE 25, 2012. EX. ENVIRO SHOWN PER FIELD INVEST	ND FIELD OBSERVATION ON ONMENTAL INFORMATION IGATION BY ECO-SCIENCE
/SF (APP. RATE) = 625 SF CH W/ 36" OF EFFECTIVE AREA DEPTH = 208 LF \times 0.50 = 104 LF MIN. TRENCH	SOLUTIONS CONDUCTED O	N OR ABOUT JUNE, 2014.
SYSTEM	I della	Planners
/SF (APP. RATE) = 625 SF CH W/ 30" OF EFFECTIVE AREA DEPTH		Surveyors
= 208 LF x 0.45 = 94 LF MIN. TRENCH	4 Ko	Engineers
ETWEEN TRENCH EDGES	123 1	Landscape Architects
CHES FOR INITIAL SYSTEM	1	4
CHES FOR 1ST REPLACEMENT SYSTEM	12	192 East Main Street
CH FOR SECOND REPLACEMENT SYSTEM		Westminster, MD 21157
TEM DISTRIBUTION AS TWO 40 FOOT	DD	410.386.0560
VC).		410.386.0564 (Fax)
		DDC@DDCinc.us
lon plan		www.DDCinc.us
scotic system	Development Design Consult	ants
Approved Septic System Plan Approved Septic System Plan Health Department	OWNER:	DEVELOPER:
Approved County Stain Ste	ESC WALKER MEADOWS, L.C. 5074 DORSEY HALL DR., SUITE	NV HOMES 205 9720 PATUXENT WOODS DRIVE
How of your be	ELLICOTT CITY, MD 21042 410-720-3021	COLUMBIA, MD 21046 410-379-3391
TOGTON 5- BED STEP	SITE ADDRESS:	
- Chiller	S/E RIVER ROAD	
Bature	SYKESVILLE, MD 21784	
Signalars	WALKER	MEADOWS
	A RESUBDIVISIO DIEHL PROPER LOTS 1-34 \$ BUILDABLE PRESE PRESERVATION PARCEL B-K,	N OF LOT 2 OF THE RTY (PLAT #6937) RVATION PARCEL A \$ NON-BUILDABLE NON-BUILDABLE BULK PARCELS L-M
	1056 STEPP	
		ISITE SEWAGE TEM DESIGN PLAN
	5TH COUNCIL DISTRICT	ILII DESIGN FLAN
PROFESSIONAL CERTIFICATION I HEREBY CERTIFY THAT THESE DOCUMENTS WERE PREPARE OR APPROVED BY ME, AND THAT I AM A DULY LICENSED	D 3RD ELECTION DISTRICT	HOWARD COUNTY, MD
PROFESSIONAL ENGINEER UNDER THE LAWS OF THE STATE OF MARYLAND LICENSE NO. 21998 EXPIRATION DATE: 6/6/20	REVIS	IONS
4/16/20 DATE		
	NO. DESCRIPTION OF CH	IANGES DRN. REV. DATE
THE OF MARTIN	CO. FILE #: F-17-045	DES. BY: LJC
- Sher	TAX ACC. #: 03-601568	DRN. BY: LJC
	TAX MAP: 9	CHK. BY: WRD
and a second second	BLOCK / GRID: 6	DATE: 4/16/20
W WOWAL ENGINE	PARCEL #: 66	DDC JOB#: 12064.3
WILLIAM R. DEMARIO	ZONE / USE: RR-DEO	SHEET NUMBER:
	LONE / USE. KK-DEU	
PROFESSIONAL ENGINEER NO. 21998	DWG. SCALE: 1" = 30'	1 of 1

LATERALS (4-INCH PV)

	LOT 15 - R	RELATIVE DEPTHS	
	PIPE INVERT	EFFECTIVE AREA BEGINNING	MAXIMUM TRENCH BOTTOM
INITIAL SYSTEM TRENCH A	2'	3'	7'
IST REPLACEMENT TRENCH A	2'	3'	6'
IST REPLACEMENT TRENCH B	2'	3'	6'
2ND REPLACEMENT TRENCH A	2'	2.5'	6'

LOT 15 - APPROXIMATE ELEVATIONS

INVERT

ELEVATION

534.1

533.0

531.7

530.6

DATA SOURCES:

BOTTOM ELEVATION

529.1

529.0

527.7

526.6

GROUND

ELEVATION

536.1

535.0

533.7

532.6

INITIAL SYSTEM

TRENCH A

IST REPLACEMENT TRENCH A

IST REPLACEMENT

TRENCH B 2ND REPLACEMENT

TRENCH A