
RUSNOCK RESIDENCE PERMIT SET

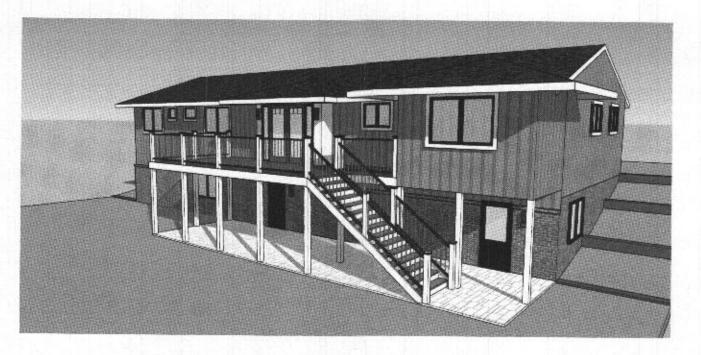


SQUA	ARE FOOTAG	BE .
	EXISTING	PROPOSED
TERRACE LEVEL	1,800 S.F.	1,800 S.F.*
FIRST FLOOR	1,543 S.F.	1,656 S.F.*
GARAGE	250 S.F.	250 S.F.
DECK	176 S.F.	392 S.F.
PATIO	162 S.F.	537 S.F.
TOTAL FINISHE	D AREA (ADI	OTION ONLY
	113 S.F.	77,011,011,21,
	113 3.1.	
TOTAL S	QUARE FOO	TAGE
4	,635 S.F.	

TOTAL FINISHED AREA*

3,456 S.F.

INDEX TO DRAWINGS SYMBOL KEY COVER SHEET **ELEVATION CALLOUT** A0.01 CODE REVIEW A0.02 SITE PLAN SECTION CALLOUT A1.01 DEMO TERRACE LEVEL PLAN A1.02 DEMO FIRST FLOOR PLAN A1.03 TERRACE LEVEL PLAN FIRST FLOOR PLAN A1.04 DETAIL CALLOUT A1.05 FIRST FLOOR WALL BRACING PLAN A1.06 ROOF PLAN ROOF FRAMING PLAN A1.07 A2.01 **EXTERIOR ELEVATIONS** A2.02 EXTERIOR ELEVATIONS INTERIOR ELEVATION A3.01 DETAILED CROSS-SECTIONS

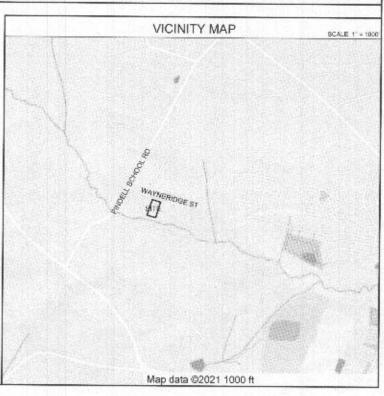

Bowley Jones Architects

CERTIFIED



I. ADRIENNE M. JONES, CERTIFY THAT THESE DOCUMENTS WERE PREPARED OR APPROVED BY ME. AND THAT I AM A DULY LICENSED ARCHITECT UNDER THE LAWS OF THE STATE OF MARYLAND, LICENSE NUMBER 17827, EXPIRATION DATE 9-8-2022

RUSNOCK RESIDENCE

SHEET TITLE
COVER SHEET

Project Number	21002	07/27/2
PERMIT	SET	
Num.	Description	Date
	U.C.A. LALLEY WAS	100000000000000000000000000000000000000

SHEET NUMBER

Design Loads - 2018 International Residential Code

Ground snow load - 25 psf
Wind speed - 115 mph
Attics with storage - 20 psf
Decks - 40 psf
Rooms (other than sleeping) - 40 psf
Handrails - 200 lb concentrated lateral load
Soil bearing capacity - 2.000 psf

Wood Framing

Must be spaced 16 inches on centers

Must be bolted to foundation with bolts of not less than one-half inch in diameter at 6 feet maximum centers

Minimum embedded to a depth of not less than 8 inches in placed concrete

Less than 15 inches in width of all wall supported thereon Pressure treated joists < 18" to ground

Provide 15 ½ heel at roof truss bearings for R-49 insulation installation Provide collar ties or structural ridge at framed roofs less than 3 ½ in 12 pitch

Deck construction must comply with all specifications provided in the Howard County Typical Deck Details Guide.

Wood and Door Openings

Must be double studs

Must have double headers

All headers must be set on top of the studs, and must be set on edge For all single window and door openings, not exceeding 48 inches, the headers shall not be less than double 2x4 supporting one floor or roof For all twin openings not exceeding 72 inches, the headers shall not be less than double 2x6 supporting one floor or roof

All triple openings not exceeding 8 feet, the headers shall not be less than double 2x8, and not exceeding 10 feet, not less than double 2x10 supporting one floor or roof. All headers must be braced at the top

Roof Framing

Roof sheathing panel nominal thickness from 3/8 inch to 7/8 inch.

Reference: 2018 IRC Table R503.2.1.1(1)
Eave overhang shall not exceed 24 inches

Rake overhang shall not exceed 12 inches

A readily accessible attic access opening not less than 22 inches by 30 inches shall be provided to any attic area having a clear height of over 30 inches

Access to the attic opening containing appliances shall be provided by a permanent or pull-down stairway in all new construction

Moisture Protection (Roof)

Ice barrier is required to be installed for new construction & re-roofing works with asphalt shingles, metal roof shingles, mineral-surfaced roll roofing, slate & slate-type shingles, wood shingles & wood shakes.

Reference: 2018 IRC R905.1.2

Drip edge is required for new construction & re-roofing works, shall be provided at eaves & rake edges of shingle roof. Reference: 2018 IRC R905.2.8.5

One and Two Family Dwellings Code Requirements

Stairways

Minimum clear width - 3 feet Minimum tread - 10-inches Maximum riser - 7 3/4 inches

Guardrail

Minimum height - 36-inches

Railing

Minimum height - 34 to 38-inches (required at least one side of stair)

Pickets

Maximum clear spacing between pickets - 4-inches

Ceiling height

Habitable rooms - 7 ft, 0 in Other areas - 6 ft, 8 in Under beams & ducts - 6 ft, 4 in

Bathrooms

Non-absorbent gypsum baseboard around shower & bath areas

Fire stopping

All duct chases, bulkheads, laundry chutes, metal flues, tub traps, and all shafts at each floor

Fuse box

Do not locate fuse box in clothes closets

Exterior stud walls

2x4 or 2x6, P.T. sole plates in contact with masonry or concrete

Wall coverings

Drywall - 1/2 inch

Habitable rooms

Minimum area - 70 sq. ft.

Minimum horizontal dimension - 7 feet

Garage Separation

Attached garage separation from residence and attic minimum 1/2" gypsum board. Habitable rooms above garage minimum 5/8" Type "X" gypsum board.

Non-combustible floor sloped to overhead door with 4" minimum elevation to residence floor.

Minimum 20 minute or 1-3/8" solid wood door with self-closer. No openings into sleeping areas.

MEP

All Electrical, Mechanical, and Plumbing Construction must be done in accordance with the adopted Howard County Codes and subject to field inspection. Table of Building Envelope Requirements*

Windows and Insulation

Window U Factor 0.35

Ceiling R-49 (or R-38 uncompressed)
Exterior Walls R-20 with 2x6 stud wall

R-13 + R-5 with 2x4 stud wall

Floor over unheated space R-19

*Notes

This table is based upon the International Energy Conservation Code, published by the International Code Council.

U-factors are MAXIMUM acceptable levels.

Insulation R-values are MINIMUM acceptable levels.

This table applies to single-family, wood frame residential

construction.
"Window" refers to any translucent or transparent material (i.e. glazing) in exterior openings of buildings, including skylights, sliding glass doors, the glass areas of opaque doors, and glass

Window U-factor must be determined from a National Fenestration Rating Council (NFRC) label on the product.

Window area % is the ratio of the rough opening of windows to the gross wall area, expressed as a percentage. Up to one percent of the total window area may be exempt from the U-factor requirement.

Opaque doors are not considered glazing (or windows) and must have a maximum U-factor of 0.35. One exempt door allowed. The code requires that windows be labeled in a manner to determine that they meet the IECC's air infiltration requirements; specifically, equal to or better than 0.30 cfm per square foot of window area (swinging doors below 0.50 cfm) as determined in accordance with AAMA/WDMA 101/I.S.2 (ASTM E 283). R-2 shall be added to the requirements for heated slabs. Floors over outside air must meet ceiling requirements. R-values for walls represent the sum of cavity insulation plus insulated sheathing, if any.

Prescriptive packages are based upon normal HVAC equipment efficiencies.

Bowley Jones Architects

CERTIFIED



I, ADRIENNE M. JONES, CERTIFY THAT THESE DOCUMENTS WERE PREPARED OR APPROVED BY ME, AND THAT I AM A DULY LICENSED ARCHITECT UNDER THE LAWS OF THE STATE OF MARYLAND, LICENSE NUMBER 17827, EXPIRATION DATE 9-8-2022

RUSNOCK RESIDENCE

FULTON, MD 20759


SHEET TITLE

CODE REVIEW

| PERMIT SET | Description | Date |


SHEET NUMBER

A0.01

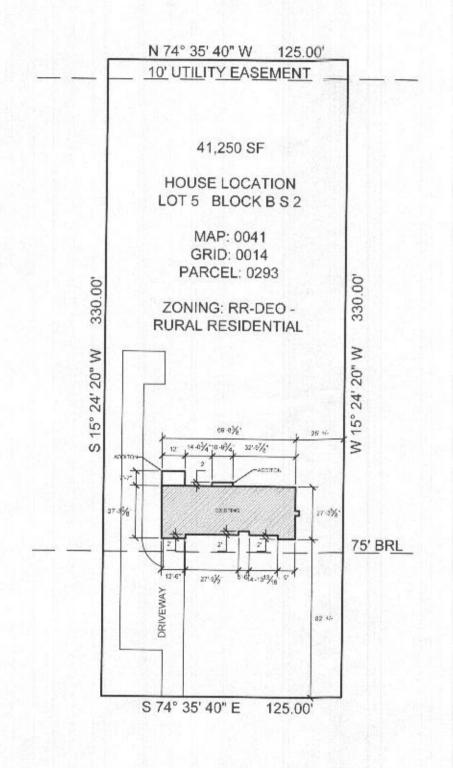

SITE PLAN SCALE: 1" = 50"



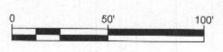

Bowley Jones Architects

CERTIFIED




I, ADRIENNE M. JONES, CERTIFY
THAT THESE DOCUMENTS WERE
PREPARED OR APPROVED BY
ME, AND THAT I AM A DULY
LICENSED ARCHITECT UNDER
THE LAWS OF THE STATE OF
MARYLAND. LICENSE NUMBER
17827, EXPIRATION DATE 9-8-2022

RUSNOCK RESIDENCE 11729 WAYNERIDGE STREET FULTON, MD 20759

SHEET TITLE SITE PLAN

Tojec humber	21002	07/27/2
PERMI	SET	
Num.	Description	Date
	The second second	

A0.02

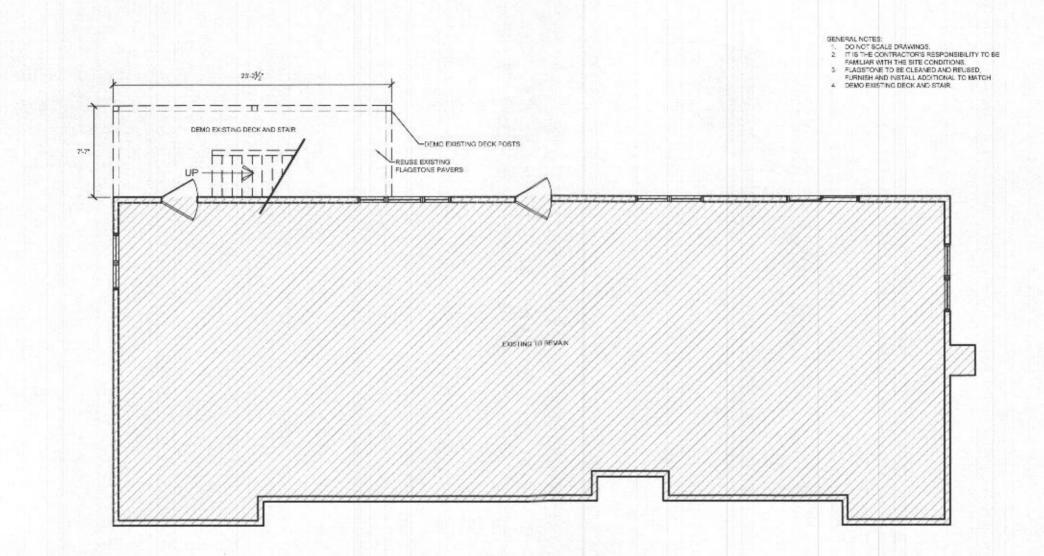

DEMO TERRACE LEVEL PLAN

SCALE: 1/8" = 1'-0"

Bowley Jones Architects

CERTIFIED



I, ADRIENNE M. JONES, CERTIFY
THAT THESE DOCUMENTS WERE
PREPARED OR APPROVED BY
ME, AND THAT I AM A DULY
LICENSED ARCHITECT UNDER
THE LAWS OF THE STATE OF
MARYLAND, LICENSE NUMBER
17827, EXPIRATION DATE 9-8-2022

RUSNOCK RESIDENCE 11729 WAYNERIDGE STREET FULTON, MD 20759

SHEET TITLE

DEMO TERRACE LEVEL PLAN

Project Married	The latest the second	Cex
	21302	07/27/21
PERMI	T SET	2) Testing
	Description	Date

SHEET NUMBER


DIND SIETHING SECUND STARS DIN SIE

DEMO FIRST FLOOR PLAN

SCALE: 1/8" = 1'-0"

Bowley Jones Architects

CERTIFIED

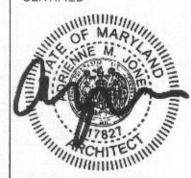

I. ADRIENNE M. JONES, CERTIFY THAT THESE DOCUMENTS WERE PREPARED OR APPROVED BY ME, AND THAT I AM A DULY LICENSED ARCHITECT UNDER THE LAWS OF THE STATE OF MARYLAND, LICENSE NUMBER 17827, EXPIRATION DATE 9-8-2022


RUSNOCK

SHEET TITLE

DEMO FIRST FLOOR PLAN

Project Service	21002	07/27/21
PERMIT	SET	
Num.	Description	Date

SHEET NUMBER

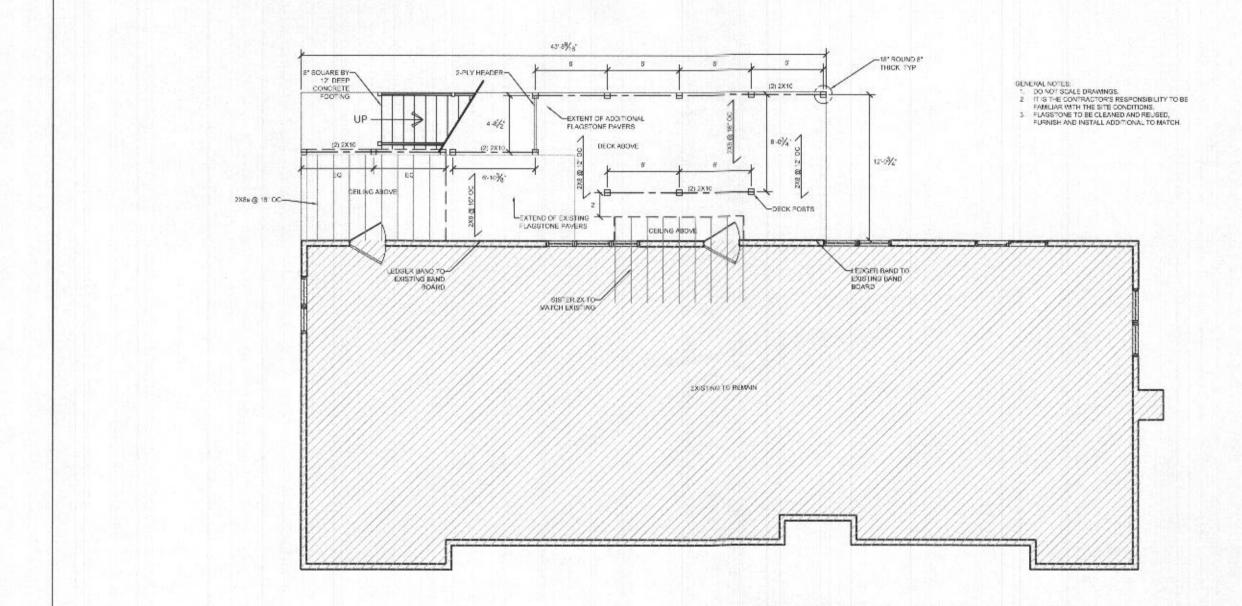

TERRACE LEVEL PLAN

SCALE: 1/8" = 1'-0"

Bowley Jones Architects

CERTIFIED



I. ADRIENNE M. JONES, CERTIFY THAT THESE DOCUMENTS WERE PREPARED OR APPROVED BY ME, AND THAT I AM A DULY LICENSED ARCHITECT UNDER THE LAWS OF THE STATE OF MARYLAND, LICENSE NUMBER 17827, EXPIRATION DATE 9-8-2022

RUSNOCK RESIDENCE


FULTON, MD 20759

SHEET TITLE

TERRACE LEVEL PLAN

Project N. mont	21002	07/27
PERMIT	SET	75 (32-2)
	Description	Date

SHEET NUMBER

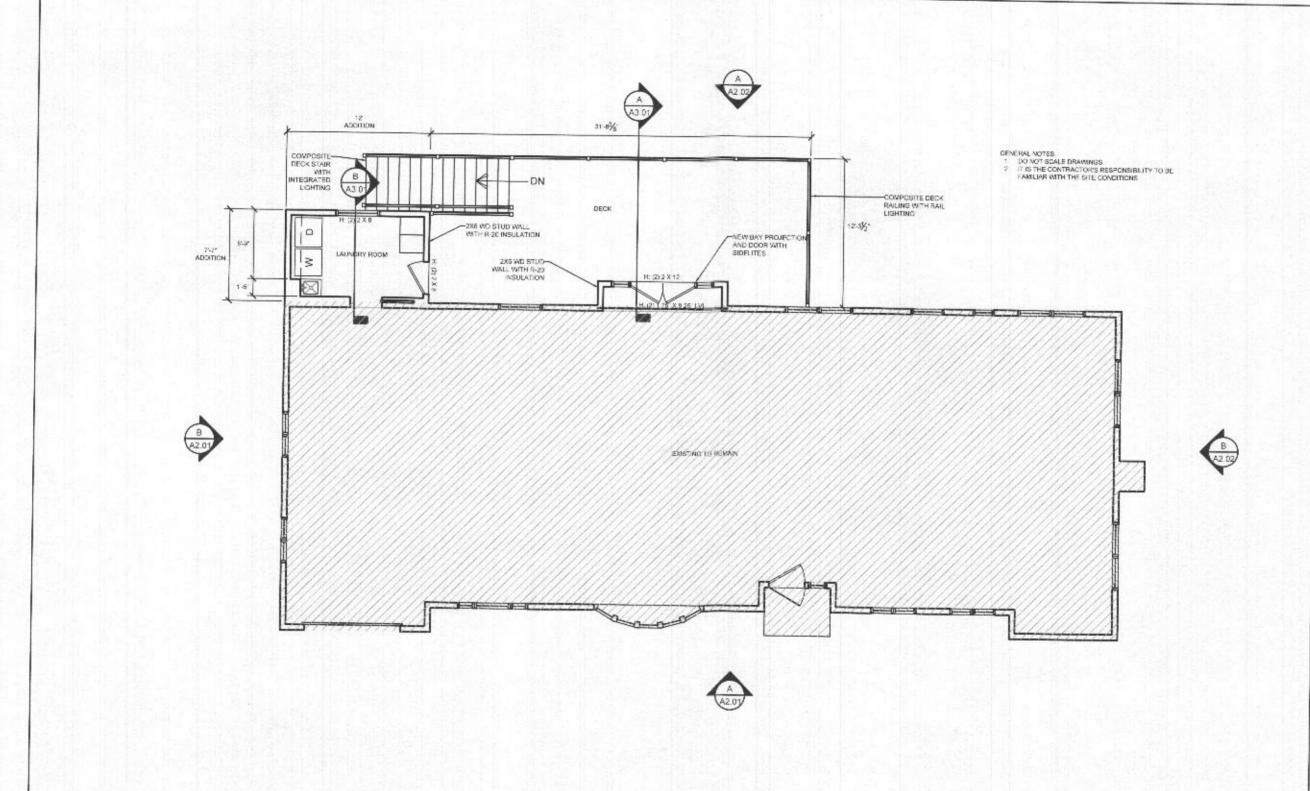

FIRST FLOOR PLAN

SCALE: 1/8" = 1'-0"

Bowley Jones Architects

CERTIFIED



I, ADRIENNE M, JONES, CERTIFY THAT THESE DOCUMENTS WERE PREPARED OR APPROVED BY ME, AND THAT I AM A DULY LICENSED ARCHITECT UNDER THE LAWS OF THE STATE OF MARYLAND. LICENSE NUMBER 17827, EXPIRATION DATE 9-8-2022

RUSNOCK
RESIDENCE
11729 WAYNERIDGE STREET
FULTON, MD 20759

SHEET TITLE

FIRST FLOOR PLAN

Tel Heral	21002	97/27/21
PERMI	TSET	
Num.	Description	Date

SHEET NUMBER