
HOWARD COUNTY DEPARTMENT OF INSPECTIONS, LICENSES AND PERMITS

ON-LINE PLAN DROP OFF

To: Plan Review Division		
From: Kaven Pitsley - (Name) Transforming A (Company)	rchitecture	
Telephone #: 301 776 2446	Email address into @transforming arc	hitecture.com
Permit Site Address 28 (A Kollin	of Fork way, alenwood Mp 277:	38
Permit Number: 822 0023 94		
Application On-Line File Date:	18/2022	
approval. These drawings represent the that this Department will not be respondented to the design or construction of	ed for online and the drawings are being dropped proposed work as outlined on the on-line applic ensible for any lost plans or documents. It is und of this project is made, revised plans will be sub-	ation. I understand erstood that if any
work commencement.	RECE JUN 16 M	
Signature of Authorized Agent	LICENSES & EF	- 1
	For Office Use Only	
Accepted by (initials):	on 6-16-22 (Date)	-
Received by Plan Review (initials):	Approved by R. Bricker on	
	R. Bricker on	
	6/17/22	

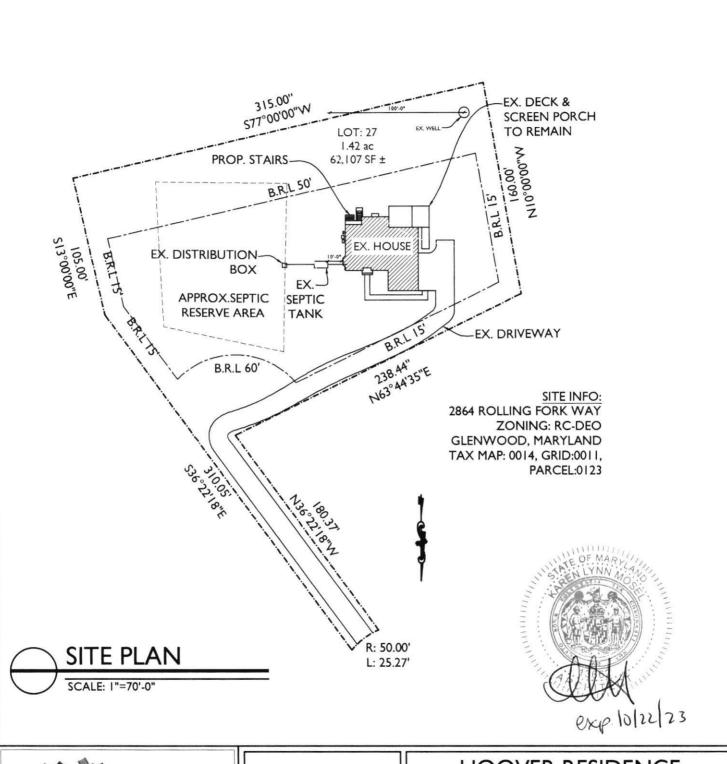



 $in fo@Transforming Architecture.com\\www.Transforming Architecture.com$

HOOVER RESIDENCE

2864 ROLLING FORK WAY GLENWOOD, MD 21738

SITE PLAN

SCALE AS NOTED

DATE: 06-16-22

PROJECT: 21-581

SCOPE OF WORK

RENOVATE 513 SOFT OF 1ST FLOOR TO UPDATE & OPEN UP KITCHEN, CONVERT PLAY ROOM TO LAUNDRY ROOM & OFFICE. ADD 63 SQFT DECK W/ STAIRS TO GRADE OFF LAUNDRY ROOM ON 1ST FLOOR.

ADD./ALT.: LVP IN OWNERS SUITE

A-100 PROJECT NOTES, SCHEDULES

DEMO PLANS, FOUNDATION PLAN & 2ND

A-102 IST FLOOR PLANS

EXTERIOR ELEVATIONS

IST FLOOR ELECTRICAL PLAN & NOTES

RESIDENTIAL NOTES & SPECIFICATIONS

GENERAL CONSTRUCTION NOTES I. THESE STRUCTURAL NOTES AND SPECIFICATIONS SHALL BE CONSIDERED PART OF THE FINAL DESIGN PACKAGE (INCLUDING CONSTRUCTION DRAWINGS) FOR THE PROJECT SPECIFICALLY DESCRIBED ABOVE. NEITHER THE STRUCTURAL NOTES NOR THE DRAWINGS ALONE ARE SUFFICIENT IN

DESCRIBING A COMPLETE DESIGN. 2. DO NOT SCALE DRAWINGS. WRITTEN DIMENSION ON DRAWINGS SHALL GOVERN. CONTRACTOR SHALL VERIFY AND BE RESPONSIBLE FOR ALL DIMENSIONS AND CONDITIONS AND SHALL NOTIFY THIS OFFICE OF ANY VARIATIONS FROM THE DIMENSIONS AND CONDITIONS SHOWN ON THESE DRAWINGS. SHOP DRAWINGS MUST BE SUBMITTED TO THE OWNER/ARCHITECT BEFORE PROCEEDING WITH FABRICATION OF ASSEMBLIES, STEEL, STAIRS, ROOF AND/OR FLOOR TRUSSES.

3. WHERE THERE IS CONFLICT BETWEEN DRAWINGS, SPECIFICATIONS OR DETAILS, THE CONTRACTOR SHALL CONTACT THE ARCHITECT FOR

CLARIFICATION. 4. PROVIDE TRANSITION STRIPS AT ALL CHANGES IN FLOOR FINISHES. 5. ALL CLOSETS ARE TO HAVE THE SAME FINISH AS THE ADJOINING ROOM UNLESS OTHERWISE NOTED.

6. PROVIDE PLUMBING FIXTURE ACCESS PANEL AT EACH TUB AND SHOWER ENCLOSURE AS REQUIRED BY LOCAL JURISDICTION. 7. PROVIDE HANDRAILS 34"-38" ABOVE NOSINGS ON ALL STAIRS. PROVIDE OR FLOOR BELOW. GUARDS SHALL BE MINIMUM 42" HIGH AND HAVE CLOSURES

SPACED TO PREVENT PASSAGE OF A 4" SPHERE. AND CHASE. IF OPEN WEB FLOOR TRUSSES ARE UTILIZED, PROVIDE 1/2" GB DRAFTSTOPPING, NOT TO EXCEED 1,000 SF.

9. PROVIDE A MINIMUM 6'-8" HEAD CLEARANCE FOR ALL STAIRS. STAIR RISERS SHALL NOT EXCEED 7-1/2" AND TREADS SHALL BE AT LEAST 10-1/2". 10. PROVIDE SOFFIT VENTS, RIDGE VENTS, OR GABLE END VENTS AS SHOWN ON THE DRAWINGS. MAINTAIN MINIMUM 1/300 FREE VENTILATION FOR HORIZONTALLY PROJECTED ROOF AREA. INSTALL PLASTIC OR CARDBOARD BAFFLES IN EACH TRUSS/RAFTER BAY TO MAINTAIN FREE AIR FLOW. 11. MECHANICAL, PLUMBING AND ELECTRICAL CONTRACTORS SHALL BE REQUIRED TO SEAL ALL PENETRATIONS IN FLOORS AND EXTERIOR WALLS

CAUSED BY THEIR TRADES. 12. ROUGH CARPENTRY CONTRACTORS SHALL SEAL ALL PANEL BUTT JOINTS AND PLATES AT FLOORS, CEILINGS, WINDOWS, DOOR FLANGES AND JAMBS. 13. SHEATHING PENETRATION SHALL BE PATCHED AND REPAIRED TO MANUFACTURER'S SPECIFICATIONS.

14. SLOPE ALL EXTERIOR PLATFORMS, PORCHES, WALKS AND GARAGE SLABS 1/8" IN 12" TO DRAIN, OR AS NOTED ON PLANS. 15. PROVIDE TERMITE PROTECTION INCLUDING SOIL TREATMENT BY LICENSED EXTERMINATOR.

SPECIFICATIONS - GENERAL CONDITIONS

I. ALL WORK SHALL CONFORM TO ALL LOCAL AND NATIONAL ORDINANCES & BUILDING CODES APPLICABLE TO THIS PROJECT, INCLUDING BUT NOT LIMITED TO INTERNATIONAL RESIDENTIAL CODE - 2018. 2. DIMENSIONS GIVEN ON SCHEDULES ARE NOMINAL. CONTRACTOR AND MANUFACTURERS ARE TO COORDINATE ALL DIMENSIONS CONCERNING

DOORS, PANELS, WINDOWS, EQUIPMENT, ETC. AND THEIR OPENINGS PRIOR TO FABRICATION AND CONSTRUCTION. 3. THE CONTRACTOR SHALL VERIFY ALL DIMENSIONS, GRADES, BOUNDARIES, AND REPORT IMMEDIATELY ANY DISCREPANCIES TO THE ARCHITECT AND/OR

4. DESIGN STANDARDS

USE GROUP: RESIDENTIAL CONST. TYPE: TWO STORY WOOD FRAME W/ SIDING. DESIGN LOADS (IRC TABLE 301.5) WIND LOAD: ± 15 ROOF LIVE LOAD: WIND SPEED: 115 MPH GROUND SNOW LOAD: 40 PSF IMPORT FACTOR: FLOOR LIVE LOAD (F.F.): 40 PSF EXP. FACTOR: FLOOR LIVE LOAD (S.F.): 30 PSF SEISMIC DESIGN CAT.: B ATTIC LIVE LOAD (ATTIC): 20 PSF WEATHERING: SEVERE 50 PSF ZONE: GARAGE LIVE LOAD: GUARD RAILS: 200 LBS. FORCE IN ANY DIRECTION SOIL BEARING: ASSUMED 2,000 PSF FROST LINE DEPTH - 30" TERMITE: VERY HEAVY DECAY: VERY HEAVY RADON RESISTANT CONSTRUCTION REQ'D: YES

CONCRETE

1. CONCRETE FOR THIS PROJECT SHALL BE NORMAL WEIGHT (145 PCF) AND CONCRETE WORK SHALL CONFORM TO AMERICAN CONCRETE INSTITUTE (ACI) STANDARD 318-99. 2. CONCRETE SHALL HAVE MINIMUM 28 DAY COMPRESSIVE STRENGTH OF 3000

3. ALL REINFORCING BAR SHALL BE GRADE 60 (FY-60,000 PSI) 4. ALL INTERIOR CONCRETE SLABS SHALL BE 4" THICK AND HAVE A MINIMUM 28 DAY COMPRESSIVE STRENGTH OF 3000 PSI WITH 6X6 - W1.4

x W1.4 WWF AND BE POURED OVER A SIX (6) MIL POLY VAPOR BARRIER4 OVER 4" POROUS GRANULAR FILL. 5. ALL INTERIOR CONCRETE SLABS 30'-0" OR GREATER IN ANY DIMENSION SHALL HAVE CONTROL JOINTS.

6.ALL EXTERIOR CONCRETE SLABS SHALL BE AIR ENTRAINED (AIR CONTENT BETWEEN 5% AND 7%) INCLUDING THE GARAGE SLAB. AND HAVE 4" GRANULAR FILL MIN BELOW CONCRETE SLAB. 7. WHERE PORCH (NOT MONOLITHICALLY POURED), PATIO OR OTHER

CONCRETE FLAT WORK ABUTS AN EXISTING CONCRETE SLAB PROVIDE A 1/2" ASPHALT IMPREGNATED FIBER BOARD EXPANSION JOINT. 8. ALL REINFORCING SHALL CONFORM TO "SPECIFICATIONS FOR DEFORMED BILLET-STEEL BARS FOR CONCRETE REINFORCEMENT" (ASTM 1 615-60). WELDED WIRE FABRIC SHALL CONFORM TO LATEST ASTM A-185.

9. REINFORCEMENT FOR THE ANCHORAGE OF CONNECTING WORK, IF NOT CONTINUOUS, AND REINFORCEMENT FOR TEMPERATURE AND ALL OTHER PURPOSES NOT SPECIFICALLY PROVIDED, SHALL LAP 30 BAR DIAMETERS OR 18" MINIMUM AT ALL SPLICES, OR SHALL HAVE DOWELS OF THE SAME BAR SIZE AND SPACING AS THAT OF REINFORCING TO BE SPLICED OR WORK TO BE CONNECTED.

10. MINIMUM CONCRETE PROTECTION FOR REINFORCEMENT: CONCRETE DEPOSITED AGAINST GROUND FORMED CONCRETE IN CONTATCT WITH GROUND FORMED CONCRETE NOT IN CONTACT WITH GROUND 12"

PREPARATION FOR SLAB

I. REMOVE ALL VEGATATION AND TOP SOIL CONTAINING ORGANIC MATERIALS FROM THE ENTIRE AREA TO BE COVERED BY THE BUILDING. 2. IF FILL IS REQUIRED TO RAISE SLAB, SCARIFY THE SUB GRADE TO A DEPTH OF 6" AND RECOMPACT TO A MINIMUM DENSITY OF 92% AND A MAXIMUM OF 98% OF STANDARD PROCTOR DENSITY (ASTM-D-698) WITH A MOISTURE CONTECT AT OR SLIGHTLY ABOVE OPTIMUM.

3. INSTALL FILL IN LOOSE LIFTS OF 8" THICK AND UNIFORMLY COMPACTED AS IN THE NOTE ABOVE. 4. FILL MATERIALS SHALL BE VERY SANDY TO CLAYEY SAND WITH A

PLASTICITY INDEX (P.I.) IF BETWEEN 2 AND 15. FOUNDATION PERIMETER INSULATION I. INSTALL EXPANDED RIGID CLOSED CELL POLYSTYRENE FOAM BORDER FED SPEC HH-I-542B. DENSITY 2.1 LBS PER CU. FT.: "R" VALUE PER 1" THICKNESS - 5.41 4. UTILITY PENETRATIONS

DIMENSION: MAX R: 7 1 MIN T:10"

SHEET INDEX

FLOOR FRAMING PLAN

INTERIOR ELEVATIONS

INTERIOR ELEVATIONS

STRUCTURAL STEEL NOTES I. MATERIALS STRUCTURAL STEEL AND PLATE ASTM A36 UNFINISHED BOLTS ASTM A307 HIGH-STRENGTH BOLTS ASTM A325

ASTM 1233, CLASS E70 WELDING ELECTRODES 2. BEAM TO BEAM AND COLUMN CONNECTIONS SHALL BE AISC STANDARD (FULL DEPTH) WHERE REACTIONS EXCEED MINIMUM CONDITIONS, THE APPROPRIATE CONNECTIONS SHALL BE DETERMINED BY FABRICATOR (CONTRACTOR)

3. ALL MAIOR CONNECTIONS SHALL BE HIGH STRENGTH FRICTION BOLTS OR WELDS OF EQUAL STRENGTH. ANCHOR BOLTS SHALL BE UNFINISHED BOLTS. 4. STEEL WORK SHALL BE FABRICATED AND ERECTED IN ACCORDANCE WITH LATEST AISC SPECIFICATIONS.

5. SUBMIT SHOP DRAWINGS FOR ALL STEEL WORK. 6. STEEL LINTELS - FOR ALL OPENINGS AND RECESSES IN STONE OR BRICK FACED WALLS NOT SPECIFICALLY DETAILED, PROVIDE ONE STEEL ANGLE FOR EACH 4 INCHES OF WALL THICKNESS, STEEL ANGLES TO HAVE MINIMUM BEARING OF 4" AT EACH END. HORIZONTAL LEG SHALL BE 3 1/2"

UNLESS OTHERWISE SHOWN. 7. LINTEL SCHEDULE (UNLESS NOTED OTHERWISE ON PLANS) NOTE: ALL LINTELS ARE TO RECEIVE SHOP APPLIED CORROSION PROTECTION. GUARDRAILS AT RAISED FLOORS, BALCONIES, ETC. 30" OR MORE ABOVE GRADE 8. STEEL BEAM POCKETS, SIZE AS INDICATED ON PLANS, BEAMS SHALL HAVE A MINIMUM BEARING OF 4" IN LENGTH MEASURED PARALLEL TO THE BEAM UPON SOLID MASONRY NOT LESS THAN 4" IN THICKNESS 8. PROVIDE NOMINAL 2X FIRE BLOCKING AT EVERY FLOOR INTERVAL, BULKHEAD OR UPON A METAL BEARING PLATE OF ADEQUATE DIMENSIONS TO DISTRIBUTE THE LOAD SAFELY. AREA AROUND BEAM TO RECEIVE

> PARGE FINISH. 9. 2x BEAM PLATE IS ANCHORED TO STEEL BEAM WITH 3/8" DIAMETER STEEL BOLTS OR EQUIVALENT POWER ACTIVATED FASTENERS AT 48" O/C. FASTENERS TO BE LOCATED A NEAR TO CENTER OF BEAM AS

10. STEEL BEAMS SHALL HAVE A MINIMUM BEARING OF 4 INCHES IN CONCRETE POCKETS AND A MINIMUM BEARING OF 3 INCHES ON STEEL COLUMNS. STEEL BEAMS SHALL BE CENTERED OVER COLUMNS BELOW.

I. MASONRY VENEER SHALL BE ATTACHED TO THE SUPPORTING WALL WITH CORROSION RESISTANT METAL TIES, EACH TIE SHALL BE 24" ON CENTER HORIZONTALLY AND SHALL SUPPORT NOT MORE THAN 1/4 SQUARE FEET OF WALL AREA. ADDITIONAL METAL TIES SHALL BE PROVIDED AROUND ALL WALL OPENINGS GREATER THAN 16". THESE TIES SHALL BE SPACED NOT MORE THAN 3' ON CENTER AND PLACED WITHIN 12" OF THE WALL OPENING. 2. CONCRETE MASONRY UNITS SHALL MEET ASTM C-90 GRADE A, 28 DAYS OLD BEFORE INSTALLATION. MINIMUM NET COMPRESSIVE STRENGTH OF

3. CARE AND PROPER MEASURES SHALL BE EMPLOYED TO PREVENT ANY SUPER IMPOSED LOADS (I.E. WIND LOADS, SHOVING OR OTHER LATERAL FORCES) FROM BULGING OR DISTORTING FINISHED MASONRY WALLS BY WAY OF SHORING, BRACING OR OTHER MEANS AS SITE REQUIRES.

4. USE TYPE "M" MORTAR FOR MASONRY BELOW GRADE IN CONTACT WITH 5. USE TYPE "N" MORTAR FOR EXTERIOR, ABOVE GRADE LOAD BEARING OR NON-LOAD BEARING MASONRY WALLS AND FOR OTHER AREAS IF NOT OTHERWISE NOTED. EXCEPTION - MASONRY CONSTRUCTION REQUIRING HEAT RESISTANT MORTAR SHALL HAVE A REFRACTORY AIR SETTING MORTAR. 6. BRICK VENEER TO BE INSTALLED W/MIN, 3/16" DIA/ WEEP HOLES SPACED AT A MAXIMUM OF 24" O.C. HORIZONTALLY.

HEADERS 1. ALL HEADERS ARE TO BE DOUBLE 2X12 UNLESS SPECIFICALLY NOTED OTHERWISE.

WOOD FRAMING

I. UNLESS OTHERWISE NOTED, ALL INTERIOR PARTITIONS TO BE CONSTRUCTED WITH 2X4 STUDS, 16" O.C., WITH DOUBLE TOP PLATE. MINIMUM 2X12 HEADER/LINTELS AT ALL OPENINGS IN BEARING OR EXTERIOR

WALLS. SHEATHING TO BE TO COX PLYWOOD OR OSB.

2. ALL FRAMING LUMBER SHALL BE SPF No. 1/No.2 AND HAVE A MINIMUM ALLOWABLE EXTREME FIBER BENDING STRESS OF 875 PSI AND A MINIMUM MODULUS OF ELASTICITY OF 1,400,000 PSI. 3. ALL FLOOR DECKS ARE TO BE GLUED TO SUPPORTING BEAMS AND JOIST

WITH PL-400 ADHESIVE AS MANUFACTURED BY "CONTECH" OR APPROVED 4. ALL WOOD BEAMS MADE OF TWO OR MORE MEMBERS SHALL BE GLUED WITH PL-400 ADHESIVE AND NAILED TOGETHER @ 12"

5. ALL WOOD POSTS MADE UP OF MULTIPLE PIECES SHALL BE GLUED WITH PL-400 ADHESIVE AND NAILED @ 12" O.C. BOTH SIDES. 6. DIRECTLY UNDER PARTITIONS WHICH RUN TO JOISTS (AND ARE OTHERWISE UNSUPPORTED) INSTALL DOUBLE JOISTS.

7. ALL RAFTERS AND JOISTS SHALL HAVE WOOD OR METAL CROSSBRIDGING AT 8' O.C. OR AT CENTER OF SPAN WHICHEVER IS LESS. 8. CONTINUOUS LOAD PATH: STEEL HARDWARE CONNECTORS TO GUARD AGAINST UPLIFT FORCES SHALL BE INSTALLED FROM THE FOUNDATIONS TO THE ROOF RAFTERS AT ALL STUDS. THESE SHALL INCLUDE BUT ARE NOT LIMITED TO FOUNDATION CONNECTORS, FLOOR TO FLOOR CONNECTORS. AND ROOF RAFTER HURRICANE CONNECTORS/ANCHORS.

9. MINIMUM BEARING FOR WOOD JOIST, RAFTERS AND BEAMS SHALL BE 3 2" ON WOOD AND 4" ON MANSONRY 10. INSTALL WOOD JOIST HANGER & WOOD BEAM HANGER CONNECTIONS AS FOLLOWS:

JOIST HANGER MIN. CAPACITY - 800# BEAM HANGER MIN. CAPACITY - 3500# 11. INSTALL MINIMUM DOUBLE STUDS AT JAMBS OF ALL OPENINGS IN WALLS OR AS SHOWN ON PLAN. 12. ALL MANUFACTURED TRUSSES ARE TO BE IN ACCORDANCE WITH ASCE

13. FOUNDATION ANCHORAGE SILL PLATES AND WALLS SUPPORTED DIRECTLY ON CONT. FOUNDATIONS SHALL BE ANCHORED ACCORDING TO IRC R403.1.6. 14. ALL SILL PLATES AND LUMBER IN CONTACT WITH CONCRETE OR MASONRY SHALL BE PRESSURE TREATED SOUTHERN YELLOW PINE.

I. ALL FINISHES SHALL BE CLASS C OR BETTER WITH A FLAME SPREAD OF 76-200 OR BETTER AND A SMOKE DEVELOPED INDEX OF 0-450.

BUILDING THERMAL ENVELOPE. THE BUILDING THERMAL ENVELOPE SHALL BE DURABLY SEALED TO LIMIT INFILTRATION. THE SEALING METHODS BETWEEN DISSIMILAR MATERIALS SHALL ALLOW FOR DIFFERENTIAL EXPANSION AND CONTRACTION. THE FOLLOWING SHALL BE CAULKED, GASKETED, WEATHER STRIPPED OR OTHERWISE SEALED WITH AN AIR BARRIER MATERIAL, SUITABLE FILM OR SOLID MATERIAL:

I. ALL JOINTS, SEAMS AND PENETRATIONS. 2. SITE-BUILT WINDOWS, DOORS AND SKYLIGHTS. 3. OPENINGS BETWEEN WINDOW AND DOOR ASSEMBLIES AND THEIR

RESPECTIVE JAMBS AND FRAMING. 5. DROPPED CEILINGS OR CHASES ADJACENT TO THE THERMAL ENVELOPE.

7. WALLS AND CEILINGS SEPARATING A GARAGE FROM CONDITIONED SPACES. 8. BEHIND TUBS AND SHOWERS ON EXTERIOR WALLS. COMMON WALLS BETWEEN DWELLING UNITS.

10. ATTIC ACCESS OPENINGS. 11. RIM IOIST JUNCTION. 12. OTHER SOURCES OF INFILTRATION.

		RC)(0	M	1	FIN	VIS	H	1 SC	HE	E	J	JL	E	
				FI	.()(OR			WALL	S	C	EIL	IN	G R	EMARKS
	ROOM NAME															
		LV.P.	EXISTING TO REMAIN	STONE W/ BRICK FACE	CARPET	UNFINISHED	CONCRETE	OA OVE		EXISTING TO REMAIN		PAINTED GYP. BD.	BEAD BOARD	EXISTING TO REMAIN		
	GARAGE		X		I	П	II	\perp	Ι	X				X		
	KITCHEN	X)				X				
	EX. SCREEN PORCH		X							X				X		
	EX. DECK		X							X				X		
:	FAMILY ROOM	X)						X		Control of the second
	MULTI-PURPOSE ROOM	X				-)				X				
	BATHROOM		X							X				X		
	PLAY ROOM	X)						X		
	FOYER	X)						X		
	DINING ROOM	X)						X		
	CLOSET	X						>						X		
					+	-								+		
	HALLWAY	X				1)	(X		
200	BEDROOM I		X							X				X		
	BEDROOM 2		X							X				X		
	BEDROOM 3		X							X				X		
	OVA/A JEDG DEDD O ONA		100			-				1				100		

					T T T T T T T T T T T T T T T T T T T
ROOM	NO.	DESIGNATION	W-D-H	TYPE	REMARKS:
					OWNER TO SUPPLY APPLIANCES
	K-01	FILLER	1.5-X-34.5	BASE	TRIM
	K-02	BD	27-24-34.5	BASE	BASE DOUBLE DOOR
×	K-03	SB	36-24-34.5	BASE	SINK BASE
	K-04	PANEL	.75-24-72	TALL	TALL PANEL
_	K-05	FILLER	3-X-108	TALL	TALL FILLER
Ŧ.	K-06	FILLER	1-X-51	WALL	WALL FILLER
Ĭ Ā	K-07	W	27-12-51	WALL	WALL CABINET
KITCHEN (K)	K-08	W	36-24-33	WALL	WALL CABINET
~	K-09	FILLER	2-X-34.5	BASE	BASE FILLER
	K-10	BD	27-24-34.5	BASE	BASE THREE DRAWER
	K-11	В	9-24-34.5	BASE	BASE SPICE PULL OUT
	K-12	В	9-24-34.5	BASE	BASE TRAY DIVIDER
	K-13	BD	27-24-34.5	BASE	BASE THREE DRAWER
8. 5	K-14	FILLER	2-X-51	WALL	WALL FILLER
X	K-15	w	33-12-51	WALL	WALL DOUBLE DOOR
1	K-16	W	54-X-X	WALL	HOOD
	K-17	W	33-12-51	WALL	WALL DOUBLE DOOR
6	1-01	В	30-24-34.5	BASE	BASE MICROWAVE CAB
0	1-02	В	42-24-34.5	BASE	BASE DOUBLE DOOR
\{\xi	1-03	PANEL	24-X-X	BASE	BASE PANEL
ISI	1-04	SB	24-24-34.5	BASE	SINK BASE
KITCHEN ISLAND (I)	1-05	Т	18-24-34.5	BASE	BASE TRASH PULL OUT
ģ	1-06	В	36-18-34.5	BASE	BASE DOUBLE DOOR CABINET
2	1-07	В	36-18-34.5	BASE	BASE DOUBLE DOOR CABINET
	L-01	FILLER	3-N/A-108	TALL	TALL FILLER
	L-02	W	27-24-30	WALL	WALL DOUBLE DOOR
	L-03	FILLER	3-N/A-108	TALL	TALL FILLER
55.0	L-04	w	27-24-30	WALL	WALL DOUBLE DOOR
U	L-05	FILLER	3-24-108	TALL	TALL FILLER BOX
LAUNDRY/OFFICE	L-06	SB	36-24-34.5	BASE	SINK BASE
XX	L-07	В	36-24-34.5	BASE	BASE DOUBLE DOOR
S.	L-08	UC	33-24-102	TALL	TALL UTILITY CABINET
5	L-09	FILLER	.75-N/A-108	TALL	TALL FILLER
5	L-10	LEG	6-6-34.5	BASE	BASE LEG
	L-II	FILLER	3-X-42	WALL	WALL FILLER
VSC 21	L-12	W	33-12-42	WALL	WALL DOUBLE DOOR
	L-13	W	33-12-42	WALL	WALL DOUBLE DOOR
	L-14	FILLER	3-X-42	WALL	WALL FILLER
	L-15	В	36-24-34.5	BASE	BASE FOUR DRAWER
	L-16	CUSTOM	36-24-66	TALL	CUSTOM CABINET

	e _e e	DOO	R S	CH	EDULE
DOOR		OR	SADDLE	BEL	REMARKS
NC	. SIZE.	INT/EXT	N S	\$ B	ALL DOORS U.N.O: 6 PANEL
001	139.5"×79.5"	EXT.	YES		DOUBLE SLIDING DOOR - OSCI
002	3/0x6/8	EXT.	YES	IHR	SINGLE DOOR - FIRE RATED & INSULATED
003	5/0×6/8	EXT.	YES		SLIDING DOOR

	REINFOR	CED CONCRETI	AND MASONRY FOUN	IDATION WALLS
MAX. WALL HT. (FT.)	MAX.	100.000	VERT. REINFORCEMENT FOR 10" NOMINAL WAL	
н. (г.)	BACKFILL HT.	200	SOIL CLASSES	
		GW,GC,SW & SP SOILS	GM, GC, SM, SM-SC & ML SOILS	SC, MH, ML-CL & INORG. CL SOILS
	5	#4 @ 56" O.C.	#4 @ 56" O.C.	#4 @ 48" O.C.
	6	#4 @ 56" O.C.	#4 @ 40" O.C.	#4 @ 32" O.C.
9	7 #4 @ 56" O.C. #5 @ 48" O.C. #6 @ 48	#6 @ 48" O.C.		
7		#4 @ 16" O.C.		
	9	#5 @ 40" O.C.	#6 @ 40" O.C.	#7 @ 40" O.C.
			RT. REINFORCEMENT SI R 8" NOMINAL WALL TI	
	5	#4 @ 48" O.C.	#4 @ 48" O.C.	#5 @ 48" O.C.
	6	#4 @ 48" O.C.	#5 @ 48" O.C.	#6 @ 48" O.C.
9	7	#5 @ 48" O.C.	#6 @ 48" O.C.	#6 @ 32" O.C.
7	8	#5 @ 40" O.C.	#6 @ 32" O.C.	#6 @ 24" O.C.
	9	#6 @ 40" O.C.	#6 @ 24" O.C.	#6 @ 16" O.C.
			RT. REINFORCEMENT SI R 12" NOMINAL WALL T	
	7'-4"	#4 @ 72" O.C.	#5 @ 72" O.C.	#6 @ 72" O.C.
	8'-0"	#5 @ 72" O.C.	#6 @ 72" O.C.	#6 @ 64" O.C.
10	8'-8"	#5 @ 72" O.C.	#7 @ 72" O.C.	#6 @ 48" O.C.
10	9'-4"	#6 @ 72" O.C.	#6 @ 48" O.C.	#6 @ 40" O.C.
	10'-0"	#6 @ 64" O.C.	#6 @ 40" O.C.	#6 @ 32" O.C.

STEEL LINTEL SCHEDULE (U.N.O.)								
STEEL ANGLE SIZE	ZE # STORIES ABOVE		OVE	# OF 1/2" REBARS				
	NONE	ONE	TWO					
3 x 3 x 1/4	6' - 0"	3' - 6"	3' - 0"					
4 x 3 x 1/4	8' - 0"	5' - 0"	3' - 0"					
6 x 3-1/2 x 1/4	14' - 0"	8' - 0"	3' - 6"	2				
2 - 6 x 3-1/2 x 1/4	20' - 0"	11' - 0"	11' - 0"	4				

HEADER SC	HEDULE (U.N.O.)
OPENING SIZE	HEADER SIZE
OPENINGS UP TO 3'	(2) 2×10
OPENINGS GREATER THAN 3' UP TO 6'	(2) 1.75 x 9.50 1.9E MICROLAM
OPENINGS GREATER THAN 6' UP TO 8'	(2) 1.75 x 11.875 1.9E MICROLAM

			n 187	APPLIANCE	SC	HEDU	LE	
	LOCATION	NO.	QTY.	EQUIPMENT	EX.	MANUF.	MODEL#	REMARKS
	KITCHEN	01	2	24" W. DISHWASHER	NO		JDPSS244LL	
	KITCHEN	02	1	36" W. SINK	NO			-
	KITCHEN	03	1	36" W. FRIDGE/FREEZER	NO		JFFCF72DKL	W/ ICE KIT
K	KITCHEN	04	1	18" W. SINK	NO			
FLOOR	KITCHEN	05	1	24" W. MICROWAVE	NO			W/ TRIM KIT
	KITCHEN	06	1	48' W. GAS STOVE	NO		JGRP548HL	W/ GAS FLEX LINE
2	KITCHEN	07	1.1	54" W. EXHAUST FAN	NO			
	LAUNDRY	08	2	WASHER	NO		ELFW7637BW	W/ STACK KIT
	LAUNDRY	09	2	DRYER	NO		ELFE7637BW	TTT STACK KIT
	LAUNDRY	10	-1	36" W. SINK	NO			

WINDOW SCHEDULE									
		~	REMARKS						
TYPE MAT.	SIZE.	OPERATION							
Α	VINYL	2/0×3/0	DOUBLE HUNG	OSCI					
В	VINYL	5/0×3/4	SLIDING - SPLIT SASH	OSCI					
C	VINYL	31.75×23.5	TRANSOM	OSCI					
D	VINYL	31.75×61.5	DOUBLE HUNG	OSCI					

*EGRESS



13953 Brighton Dam Road Clarksville, MD 21029 301-776-2666

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PROJECT PHASE

PERMIT

PROJECT TITLE

HOOVER

2864 Rolling Fork Way Glenwood, MD 21738


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21-581 PROJECT NUMBER 06/16/2022 DATE AS NOTED

DRAWING TITLE

PROJ. NOTES,

SHEET NUMBER



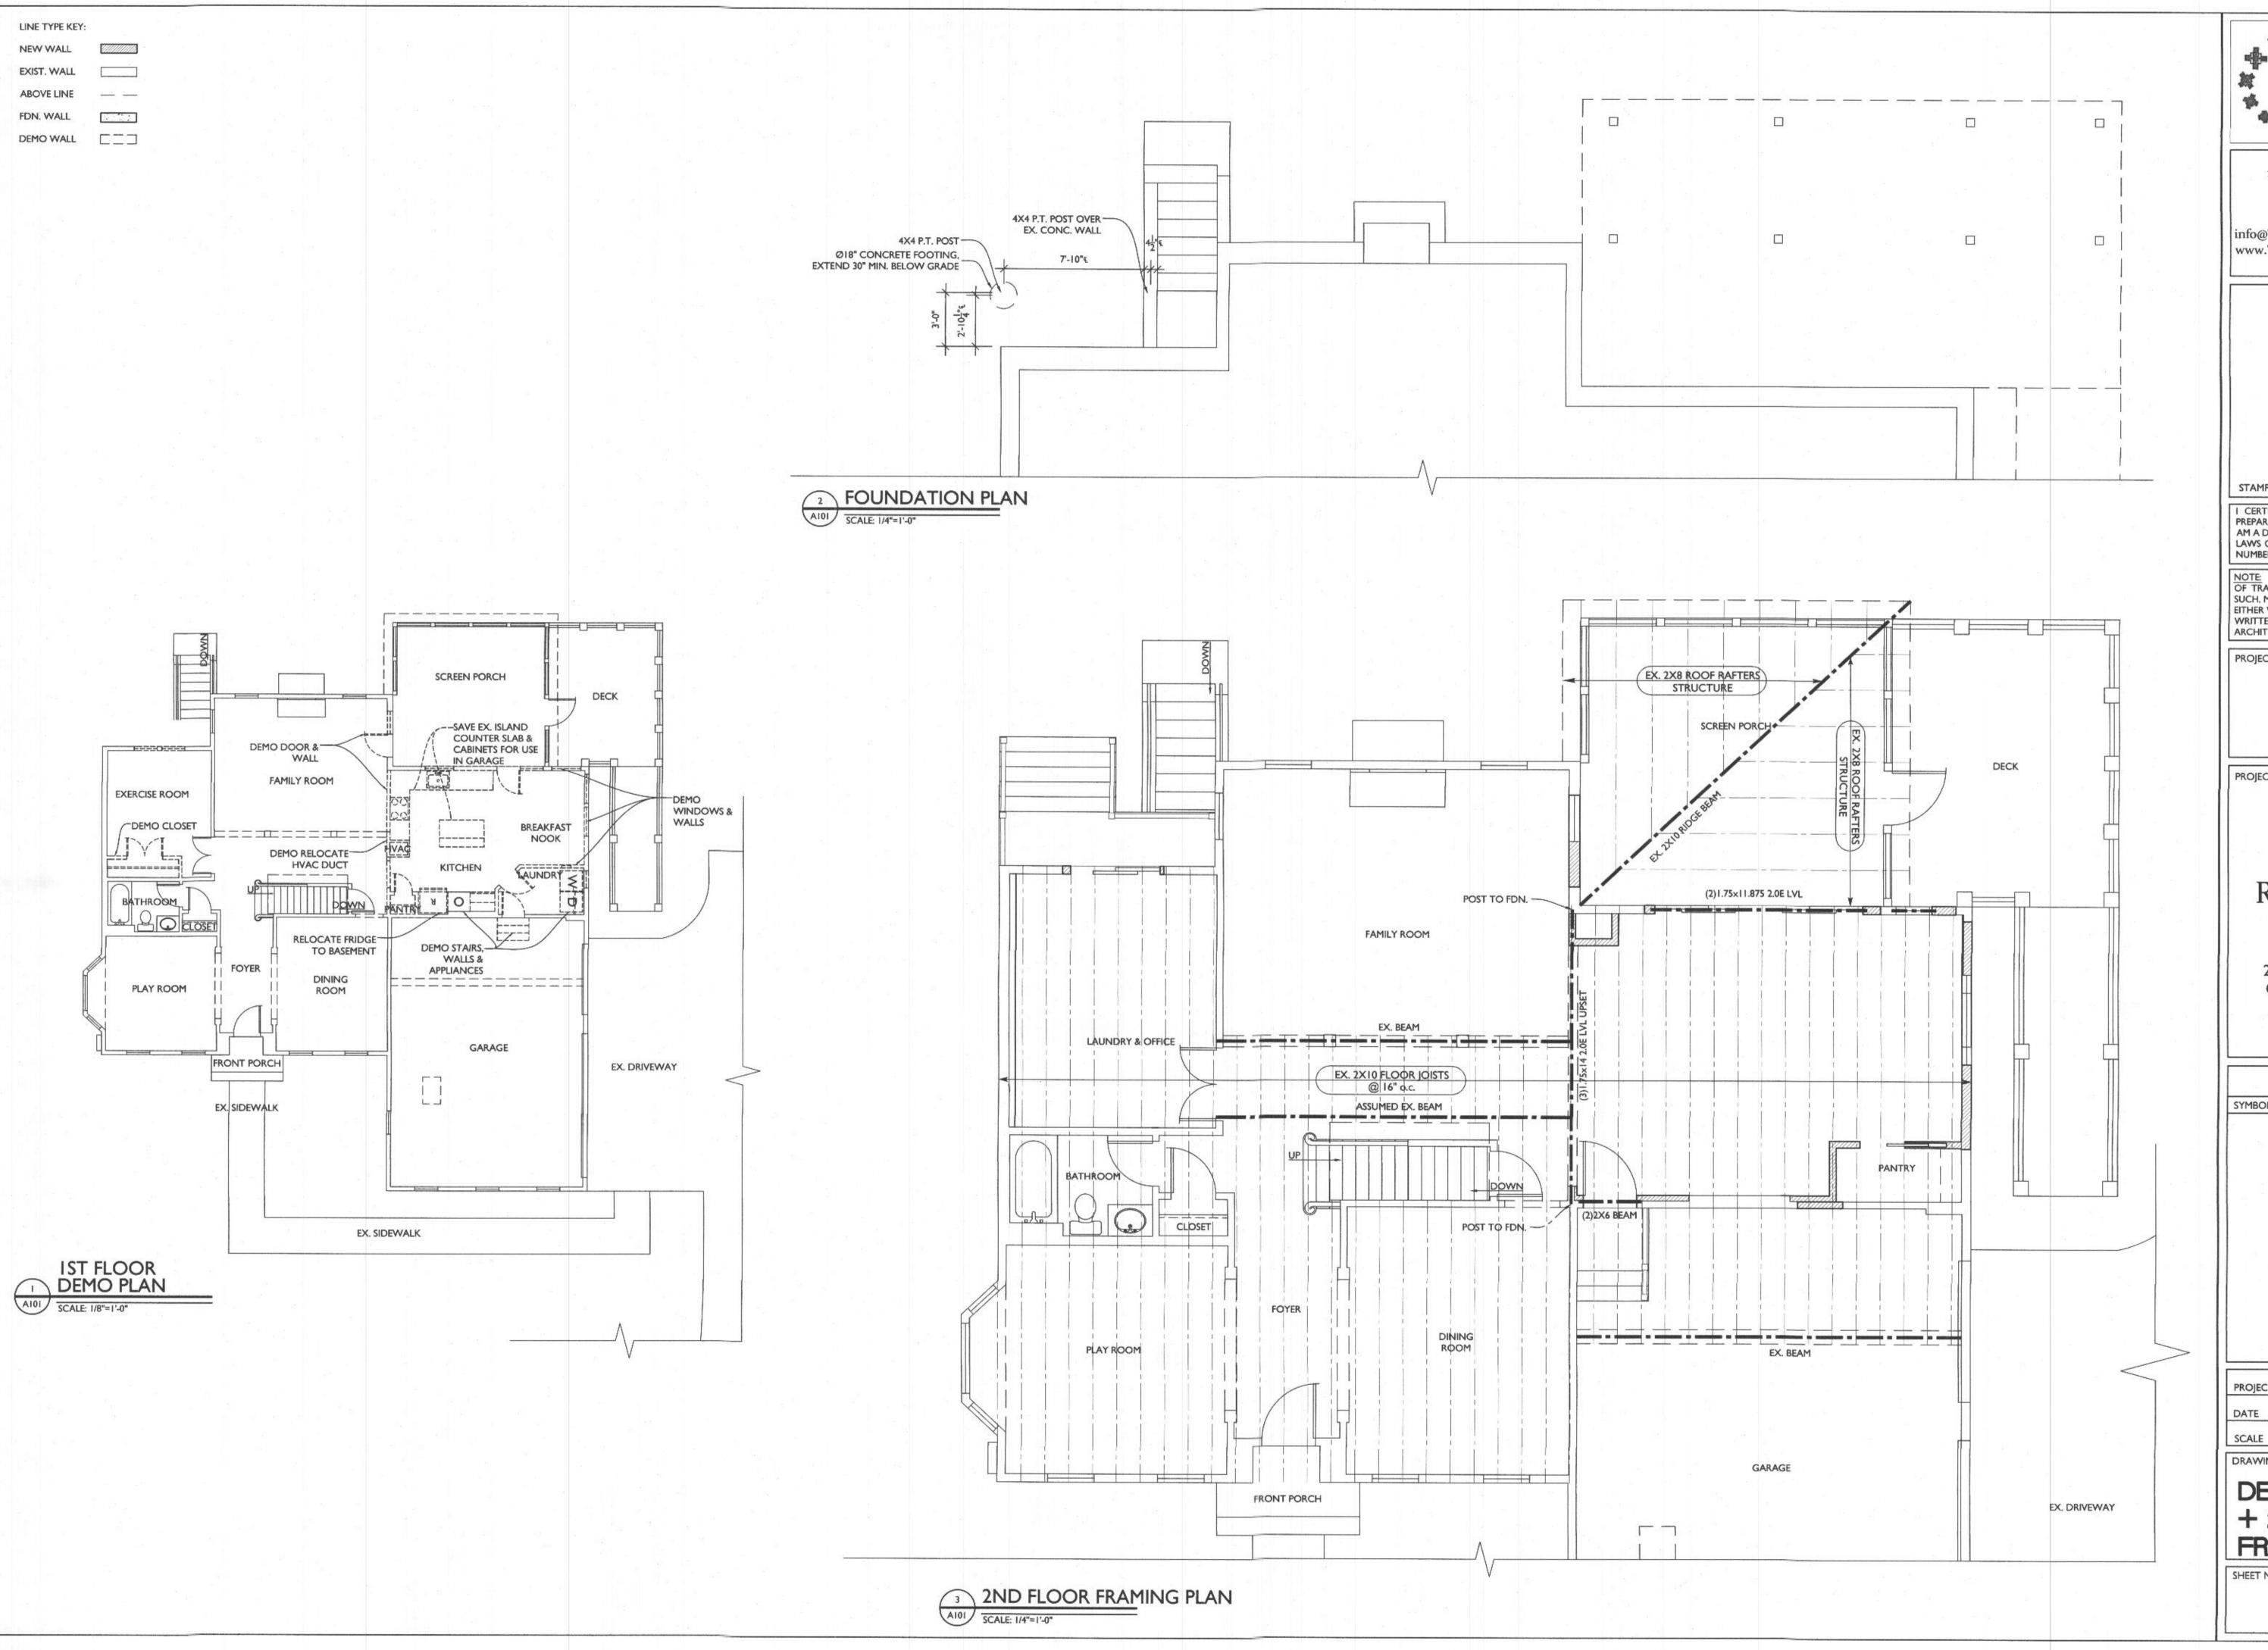

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PROJECT PHASE

PERMIT

PROJECT TITLE

HOOVER RESIDENCE

2864 Rolling Fork Way Glenwood, MD 21738

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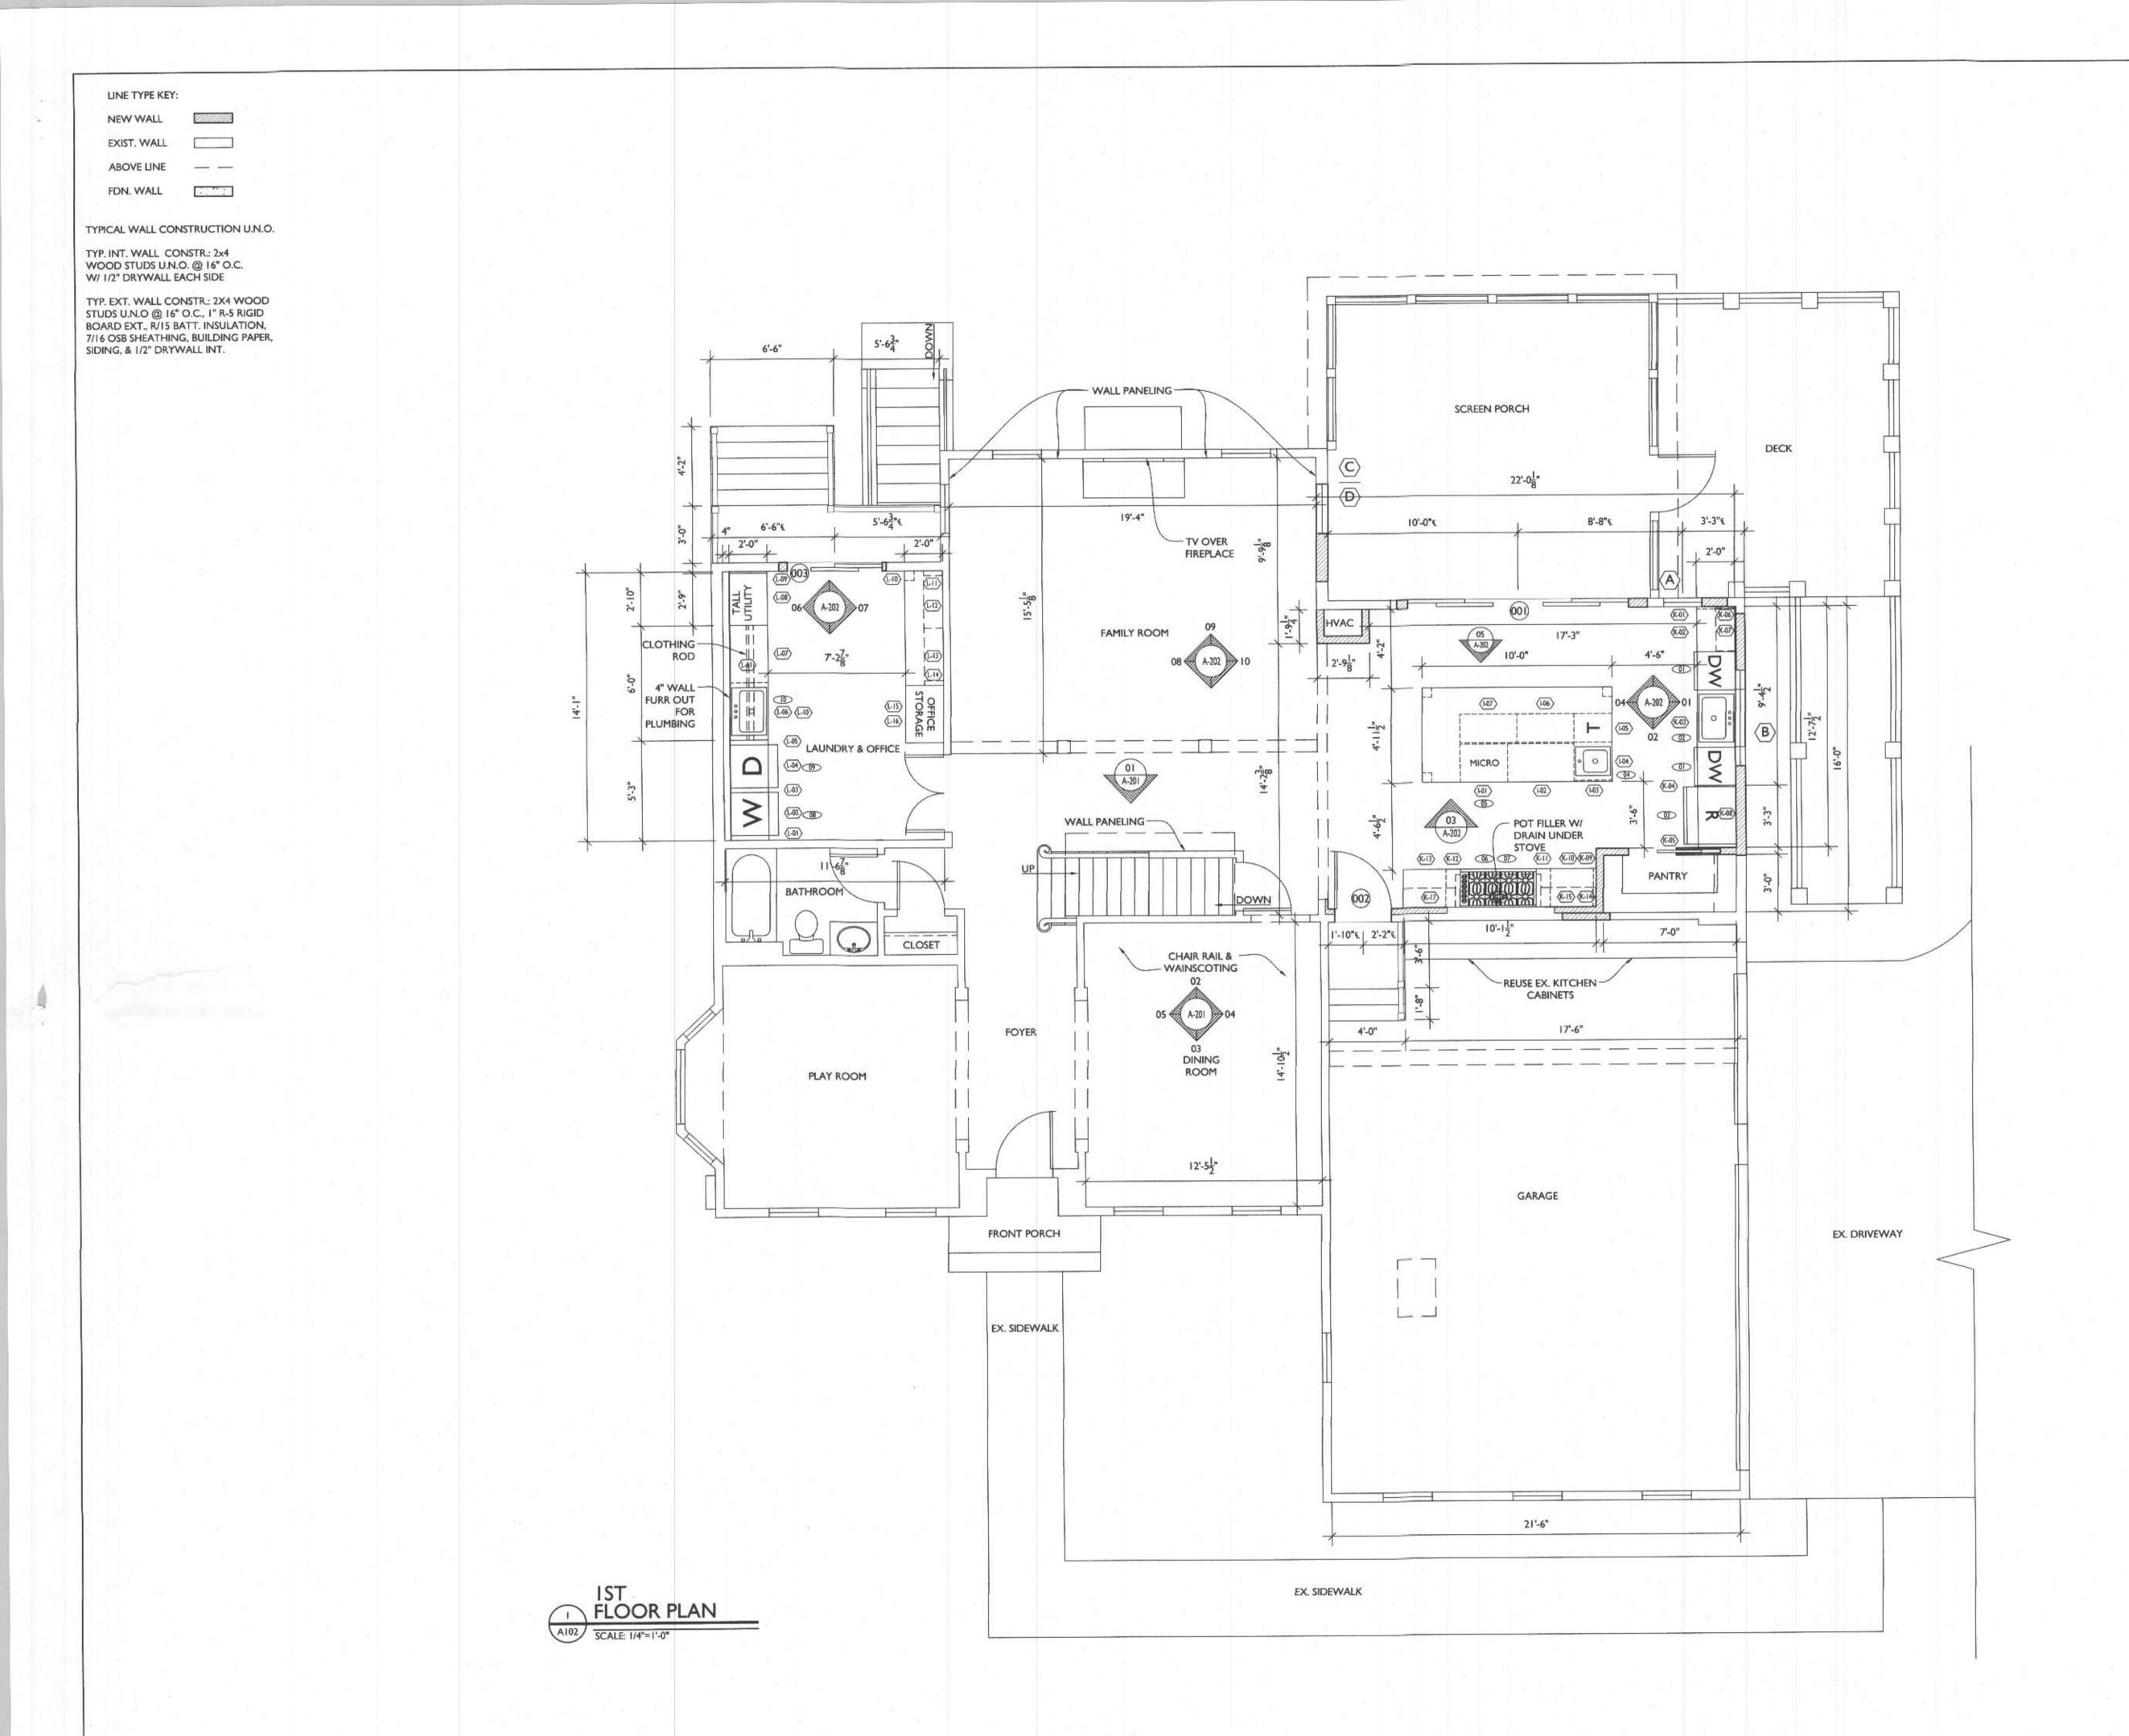
21-581 PROJECT NUMBER 06/16/2022 AS NOTED

DRAWING TITLE

DEMO, FDN., + 2ND FLR FRAMING PLAN

SHEET NUMBER

A-101





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PROJECT PHASE

PERMIT

PROJECT TITLE

THE HOOVER RESIDENCE

2864 Rolling Fork Way Glenwood, MD 21738

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 PROJECT NUMBER
 21-581

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 06/16/2022


 SCALE
 AS NOTED

DRAWING TITLE

1ST FLOOR PLAN

SHEET NUMBER

A-102

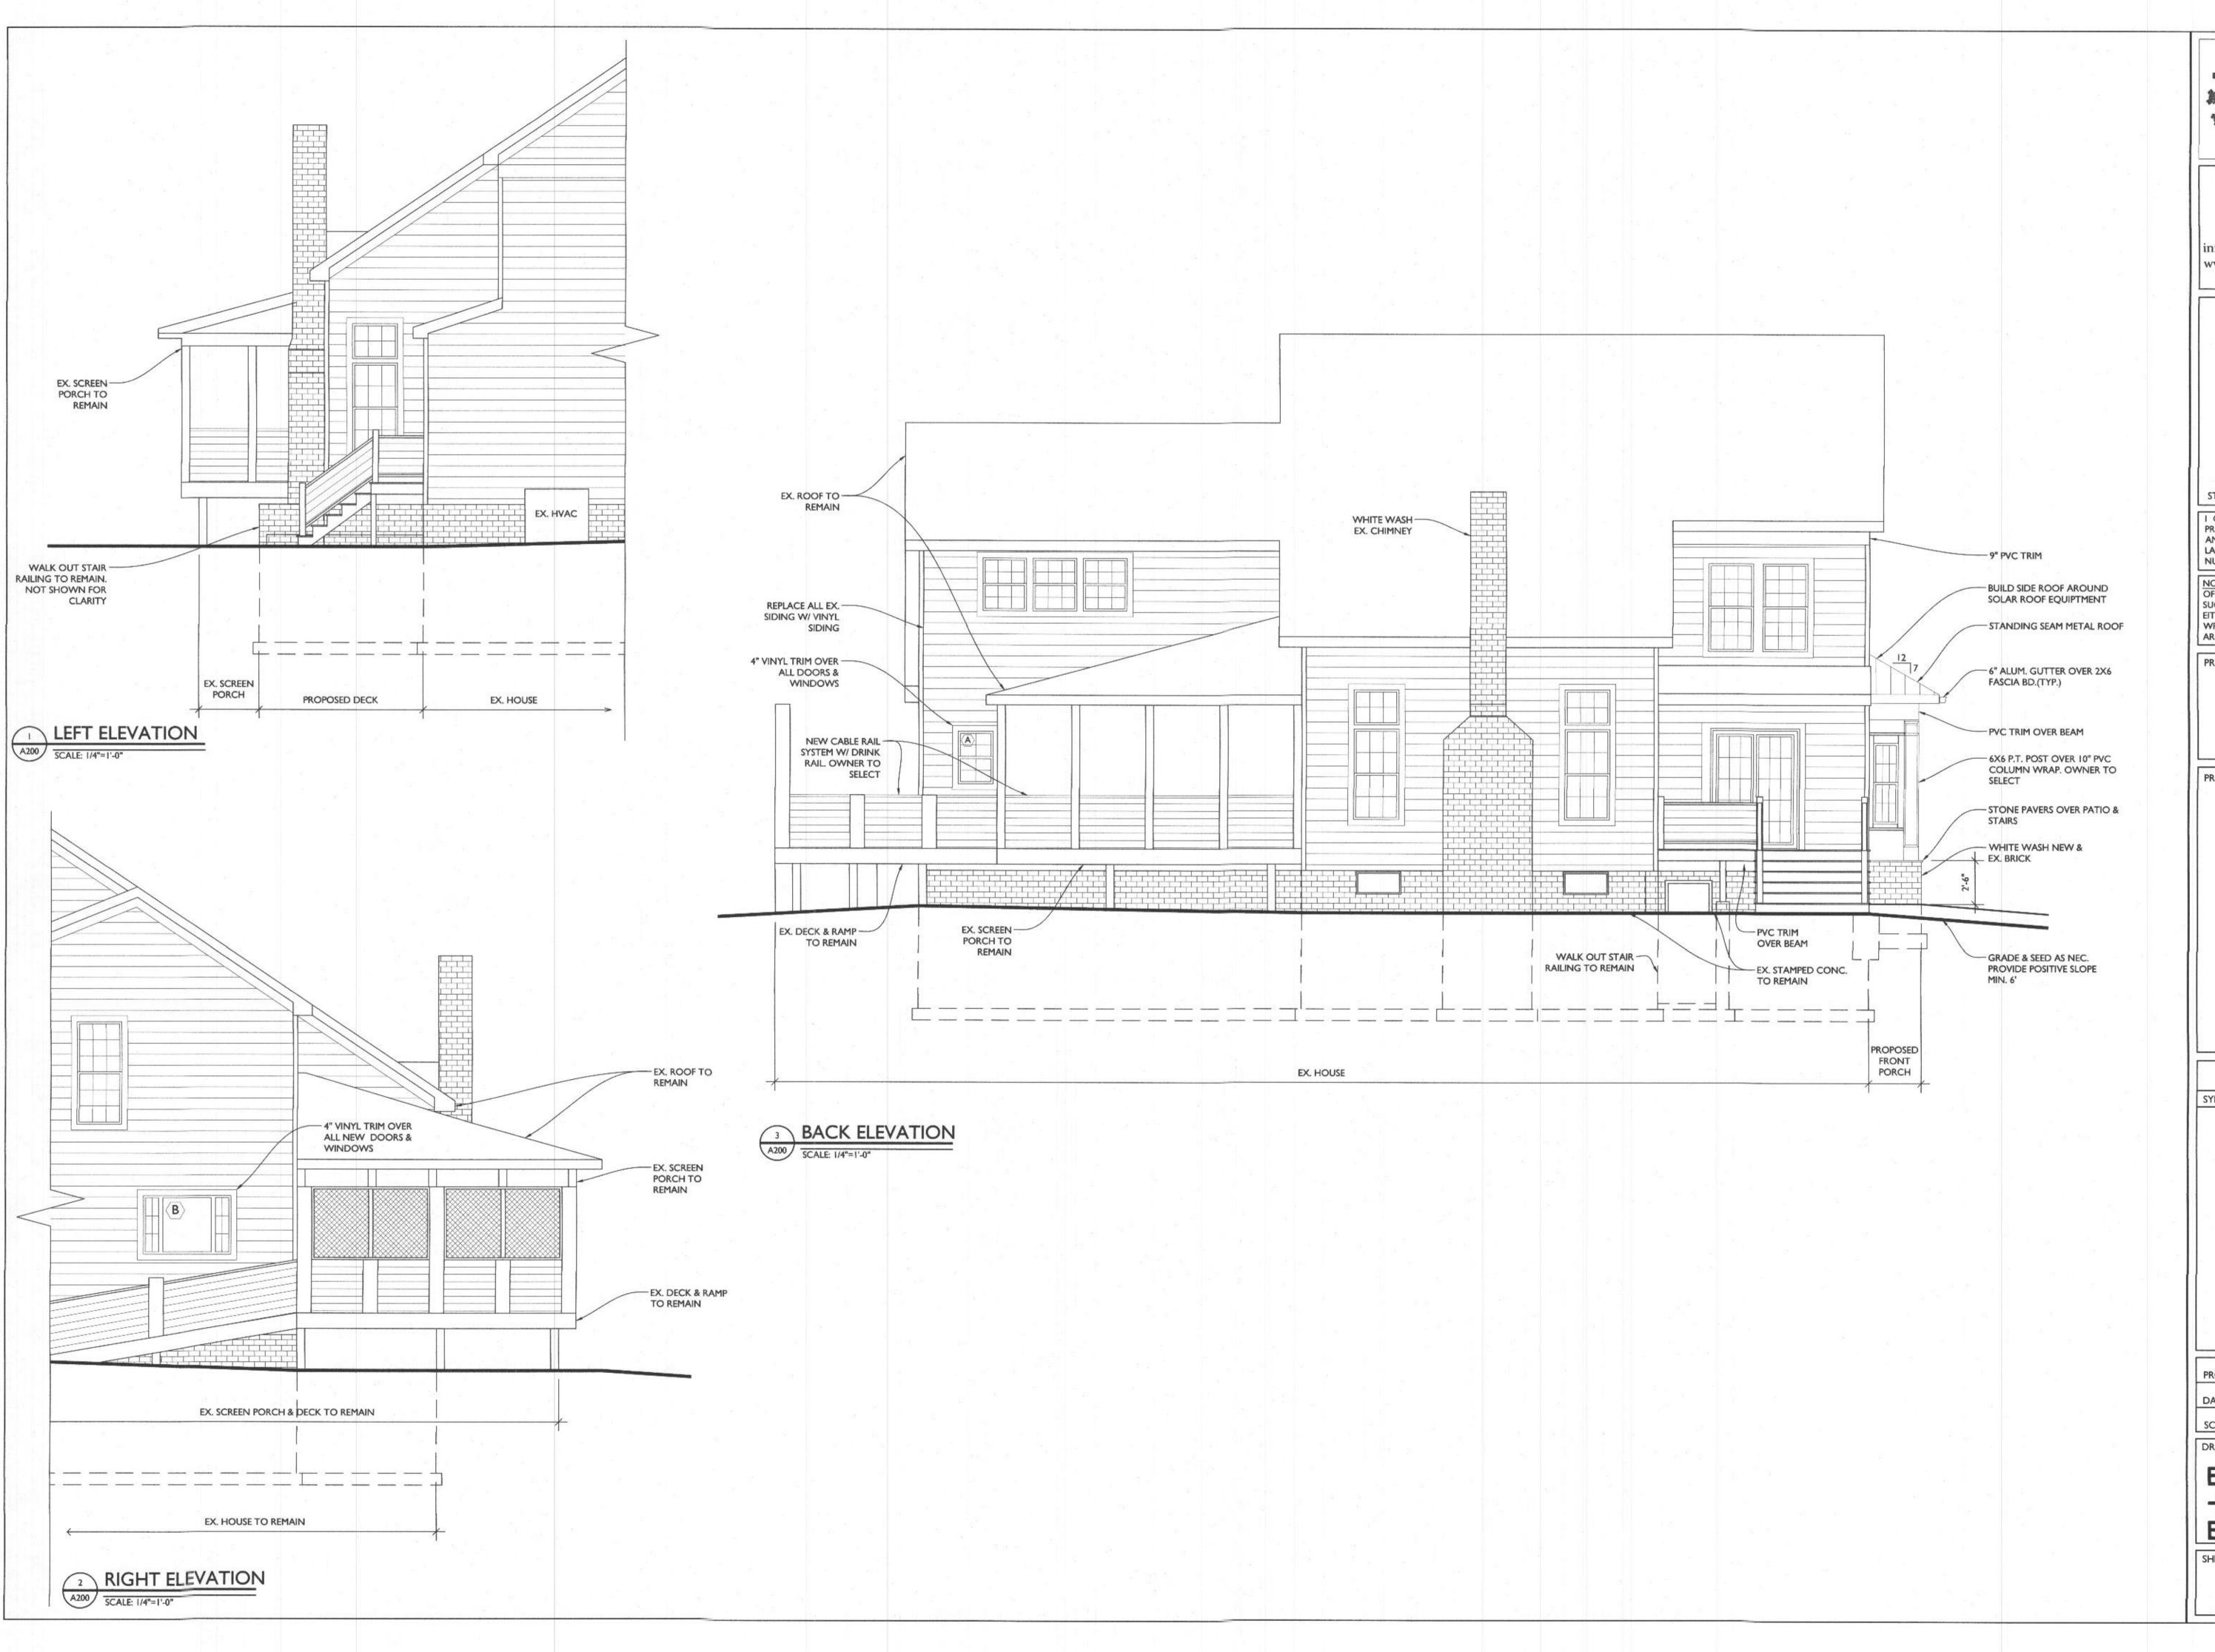



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PROJECT PHASE

PERMIT

PROJECT TITLE

THE HOOVER RESIDENCE

2864 Rolling Fork Way Glenwood, MD 21738

SYMBOL	DATE	ISSUED FOR
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 PROJECT NUMBER
 21-581

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 06/16/2022


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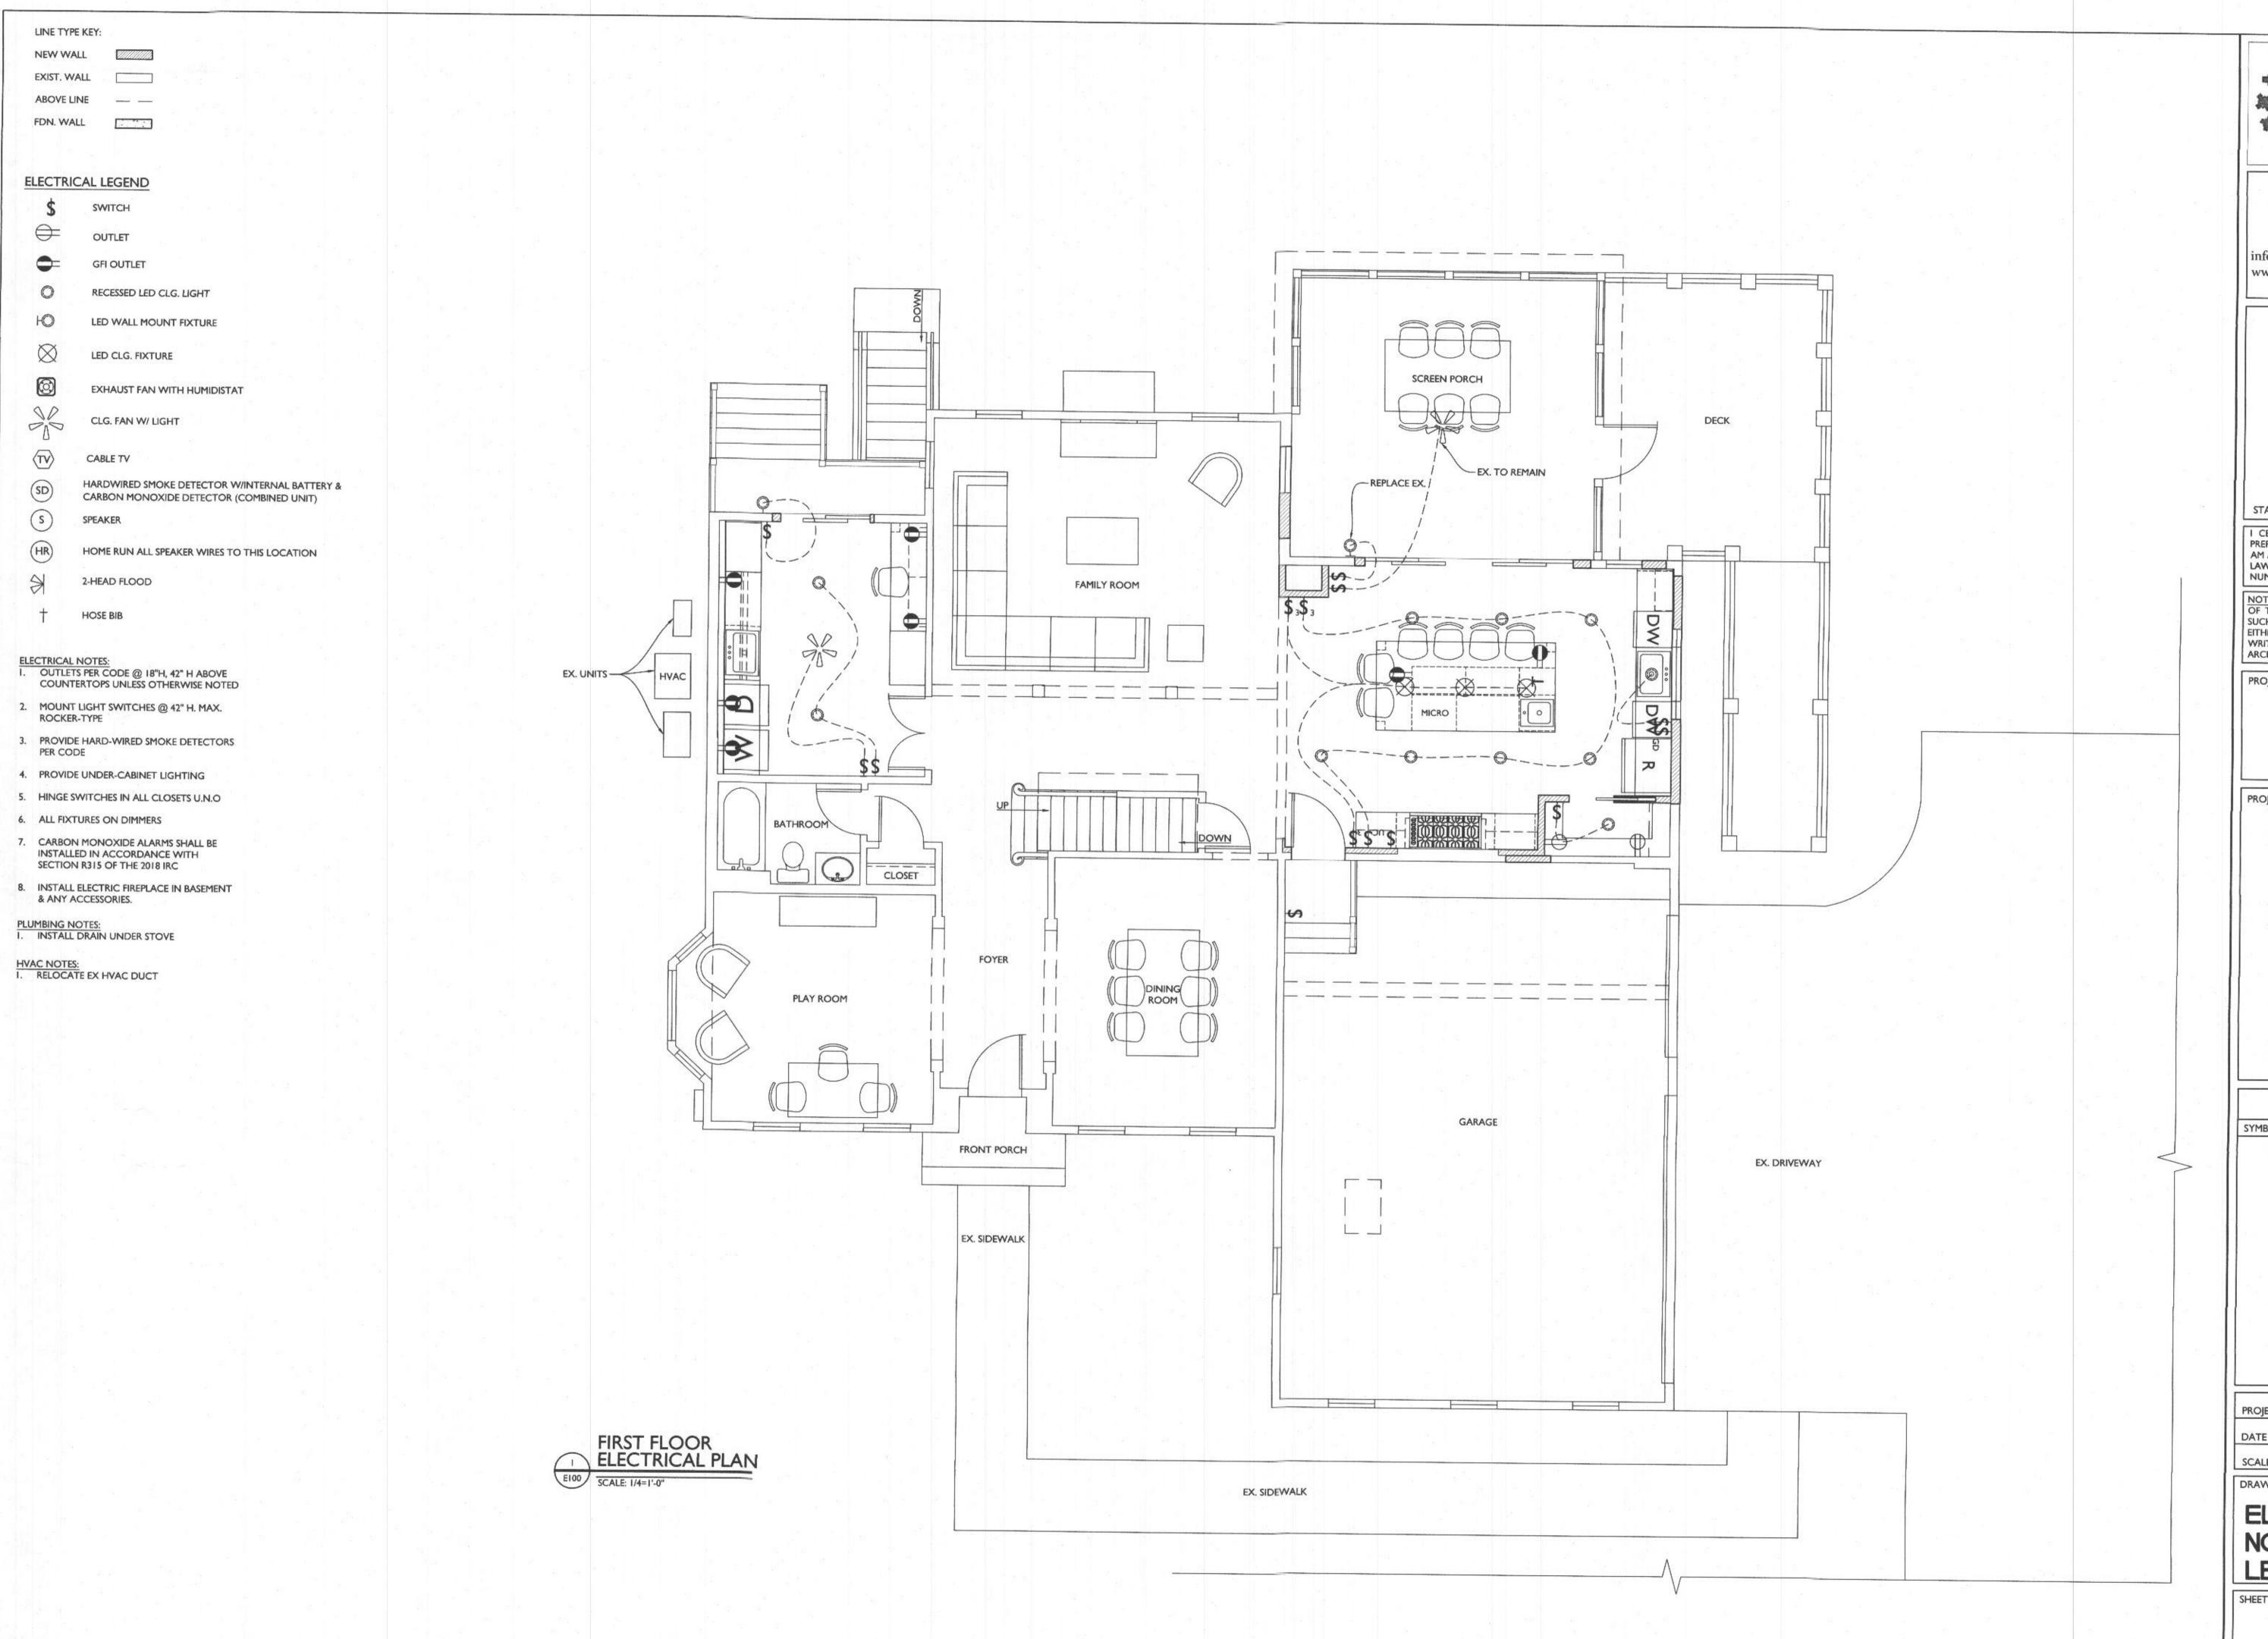
DRAWING TITLE

EXTERIOR + INTERIOR ELEVATIONS

SHEET NUMBER

A-200



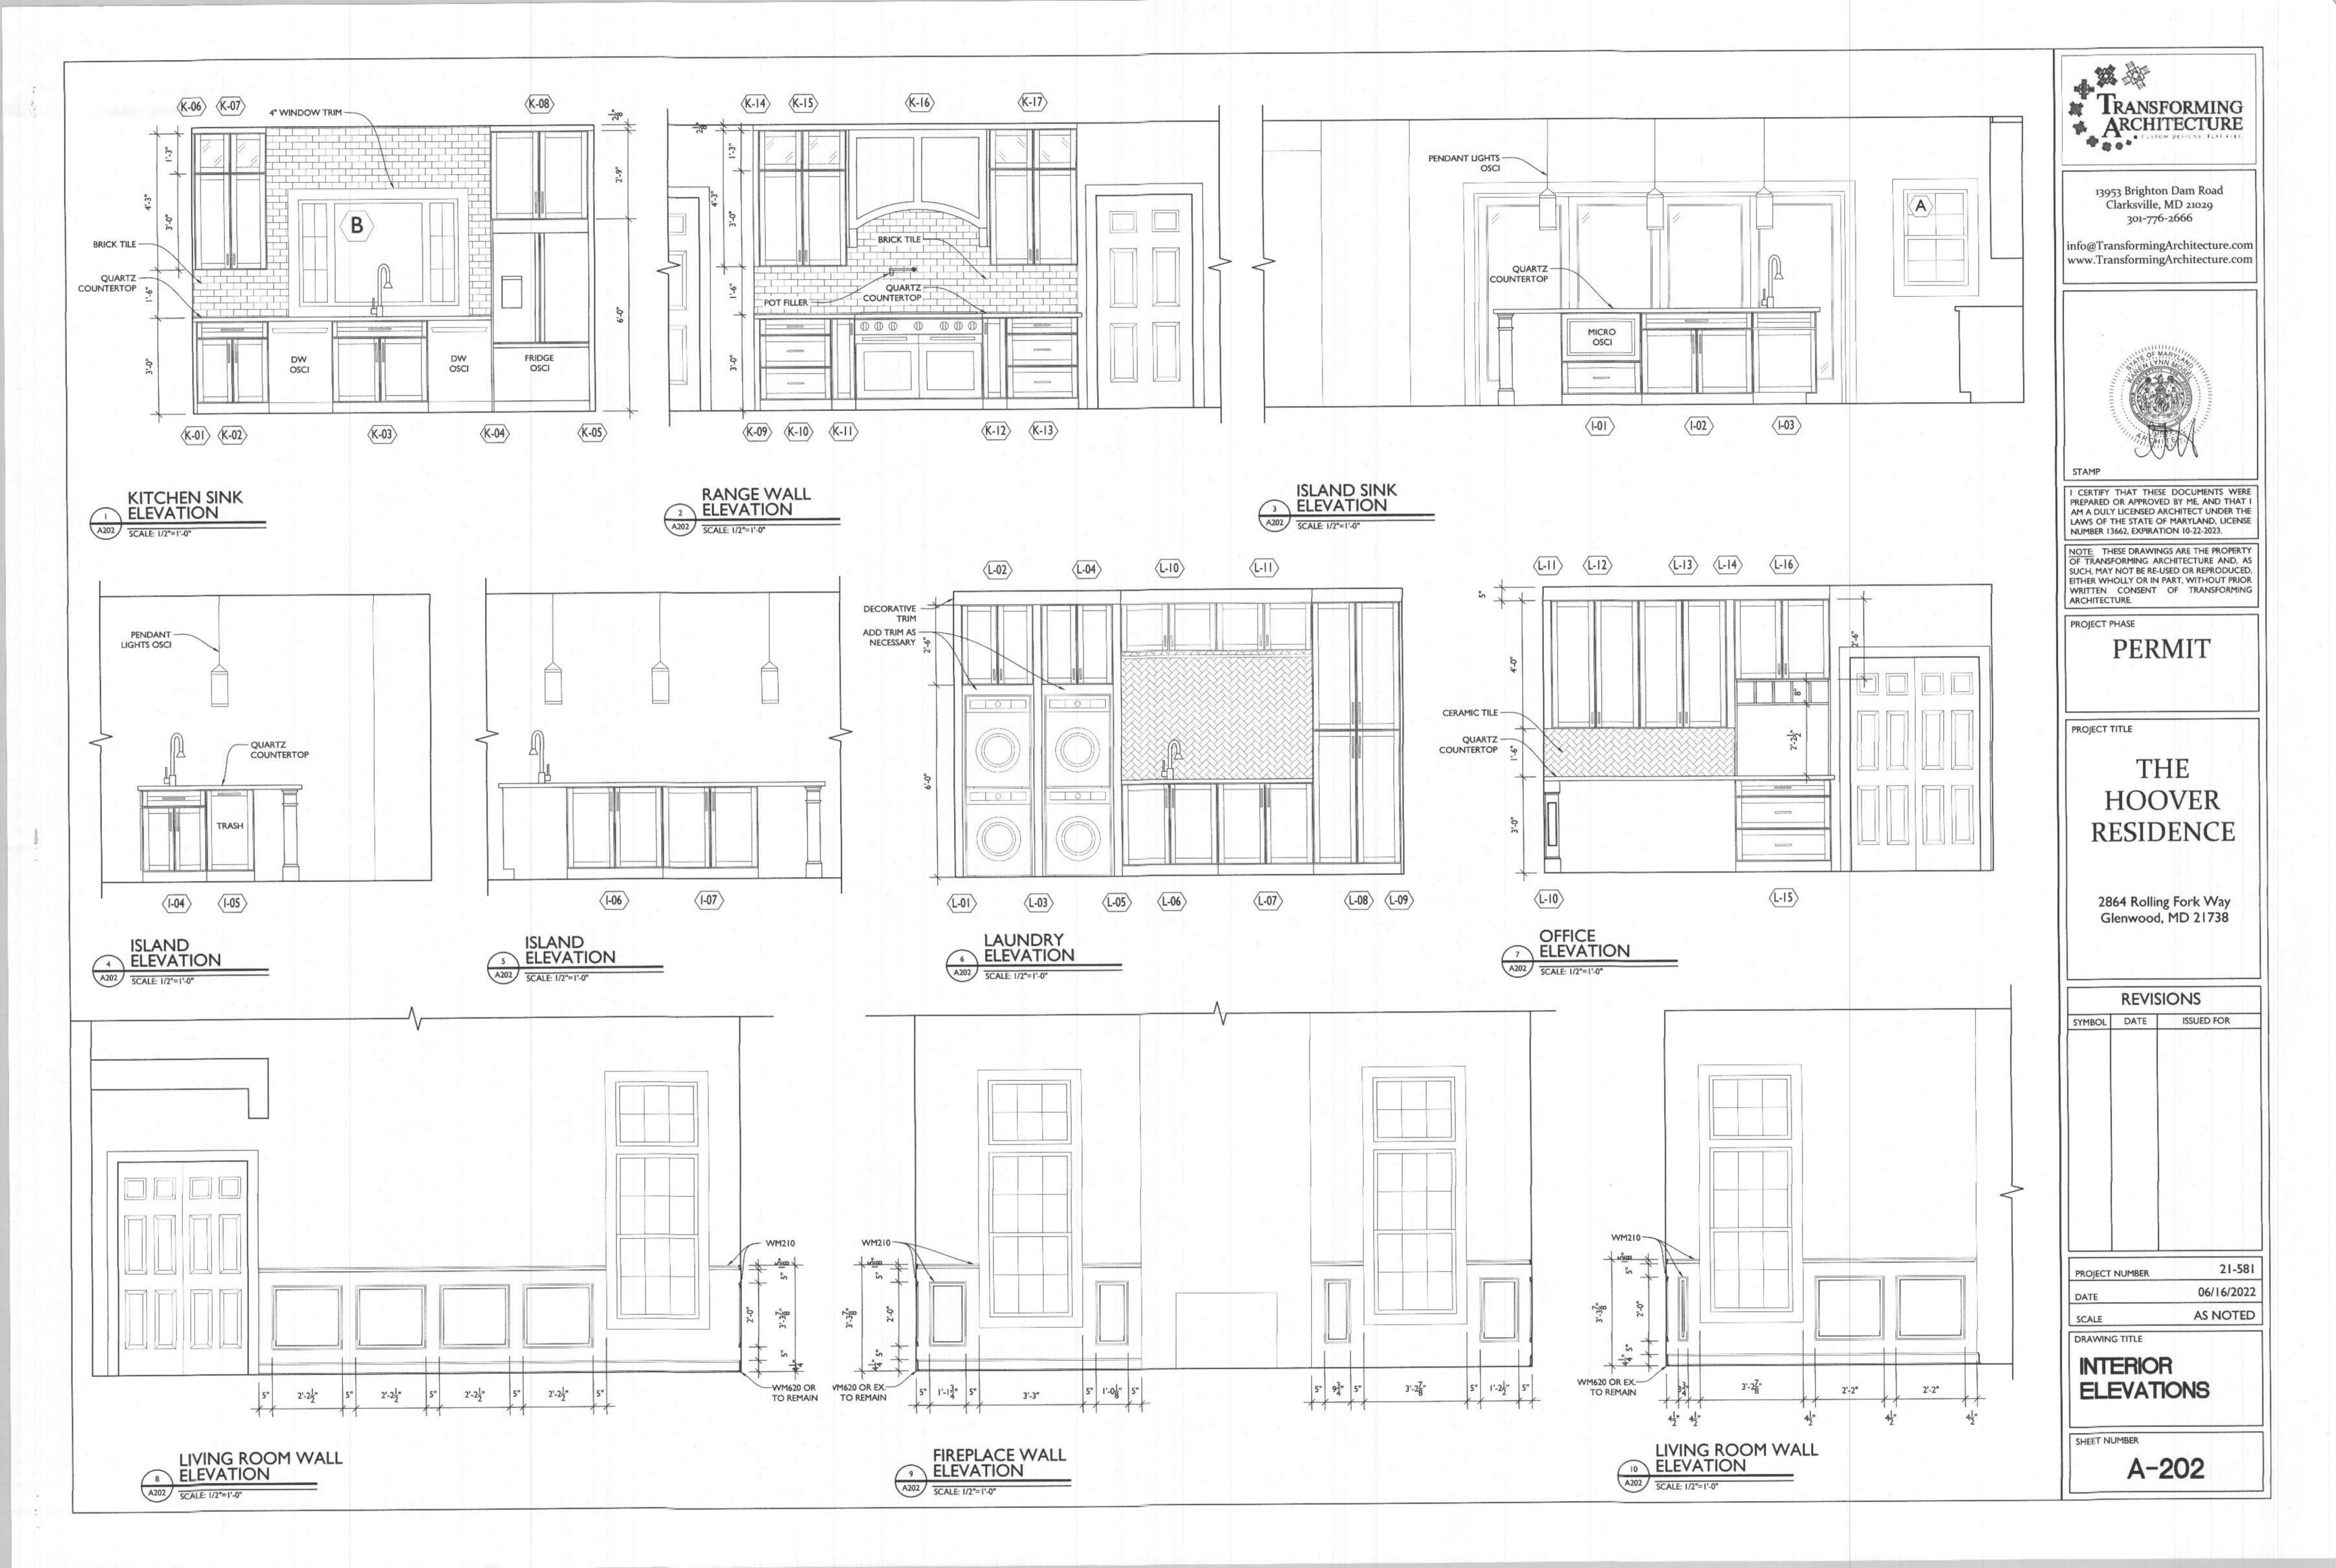



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PROJECT PHASE

PERMIT

PROJECT TITLE

THE HOOVER RESIDENCE

2864 Rolling Fork Way Glenwood, MD 21738

SYMBOL DATE ISSUED FOR

 PROJECT NUMBER
 21-581

 DATE
 06/16/2022

 SCALE
 AS NOTED

DRAWING TITLE

ELEC. PLAN NOTES + LEGEND

SHEET NUMBER

E-100