


DIMENSIONAL HAIR STUDIO NEW SALON CONSTRUCTION

FLOOR PLANS HVAC **NEW WORK** DESIGNED CHECKED

DRAWN APPROVED

FILE NO. DATE: 08/18/2022

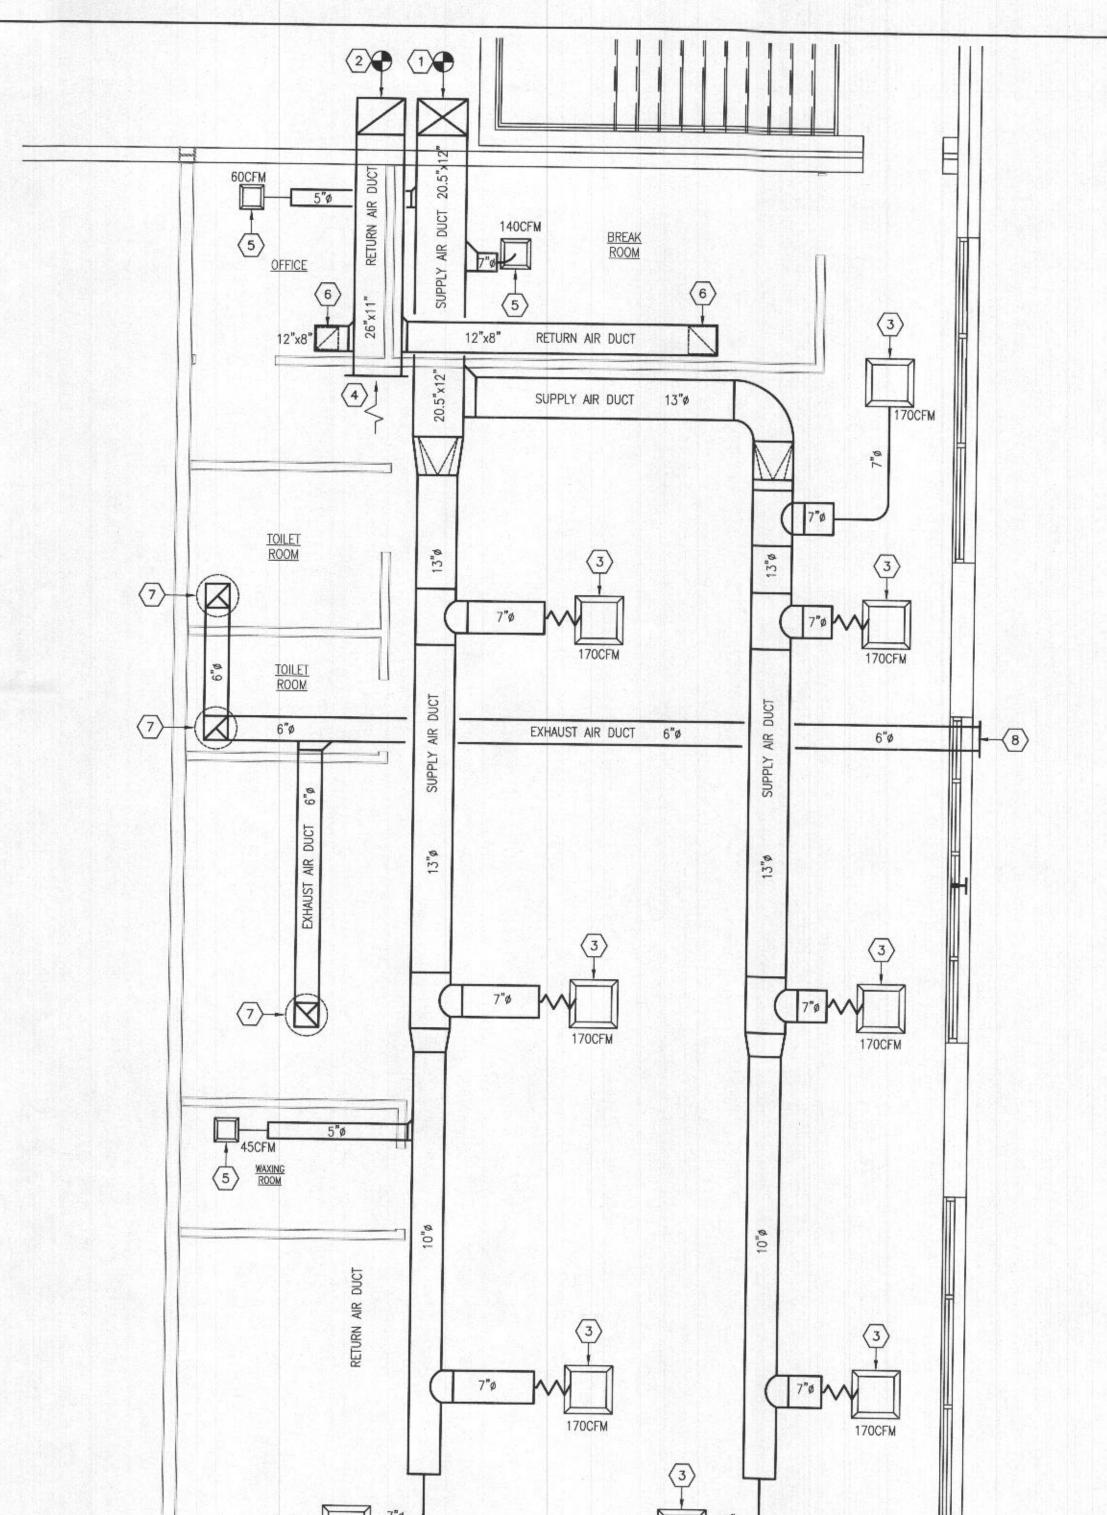

FLOOR PLAN - HVAC - NEW WORK
SCALE: 1/4" = 1'-0"

GENERAL NOTES

- 1. THE INSTALLATION SHALL BE ACCORDING TO APPLICABLE STATE AND COUNTY CODES.
- 2. THE DUCTWORK SHALL BE GALVANIZED STEEL.
- 3. THE DUCTWORK SUPPORT SHALL BE GALVANIZED STEEL RODS AND HANGERS; THE SPACE BETWEEN THE SUPPORTS SHALL BE ACCORDING TO SMACNA.
- 4. TEST AND BALANCE HVAC SYSTEM.

DRAWING NOTES:

- (1) CONNECT NEW 20.5"x12" SUPPLY AIR DUCT TO EXISTING AIR HANDLING UNIT ON ROOF.
- (2) CONNECT NEW 26"x11" RETURN AIR DUCT TO EXISTING AIR HANDLING UNIT ON ROOF.
- 3 24"X24" SUPPLY AIR LOUVERED FACE DIFFUSER IN CEILING.
- 4 RETURN AIR GRILLE.
- (5) 12"X12" SUPPLY AIR LOUVERED FACE DIFFUSER IN CEILING.
- 6 8"X8" RETURN AIR REGISTER IN CEILING.
- PROVIDE AND INSTALL NEW EXHAUSTS FAN.
- 8 NEW EXHAUST AIR DUCT TO OUTSIDE.

LEGEND							
SYMBOL	ABBREV.	DESCRIPTION					
(1)	RX.	EXISTING DUCTWORK, PIPING, OR EQUIPMENT TO B REMOVED. EXISTING PIPING OR EQUIPMENT TO REMAIN. NEW DUCTWORK, PIPING, OR EQUIPMENT CONNECT NEW TO EXISTING AT THIS POINT REMOVE EXISTING TO THIS POINT					
	AFF DWG. DN EA. EX RA SA	DRAWING NOTE ABOVE FINISHED FLOOR DRAWING DOWN EACH EXISTING RETURN AIR SUPPLY AIR					

PROFESSIONAL CERTIFICATION
I HEREBY CERTIFY THAT THESE DOCUMENTS WERE PREPARED OR APPROVED BY ME, AND THAT I AM A DULY LICENSED PROFESSIONAL ENGINEER UNDER THE LAWS OF THE STATE OF MARYLAND. LICENSE NO. 36251 EXPIRATION DATE: 08/31/2024

> RECEIVED DRAWING NO. SEP 1 3 2022 LICENSES & PERMITS

DIMENSIONAL HAIR STUDIO NEW SALON CONSTRUCTION

FLOOR PLANS PLUMBING

NEW WORK DESIGNED CHECKED APPROVED

DATE: 08/18/2022

SEP 13

LICENSES

NOTES **GENERAL NOTES** REMOVAL OF ALL EXISTING PIPING AND FIXTURES INDICATED ON THE DEMOLITION WORK PLAN SHALL BE COORDINATED WITH THE INSTALLATION OF ALL NEW PIPE CONNECTIONS, NEW FIXTURE LOCATIONS, NEW WALLS, AND NEW FLOOR TILES. 2. THE CONTRACTOR SHALL BE RESPONSIBLE FOR VERIFING THE LOCATIONS OF PIPING AND PIPE SIZES. DRAWING NOTES (1) CONNECT NEW SANITARY, NEW CW, AND NEW HW. INSTALL NEW SALON WASHING STATION, NEW STRAINER & NEW HAIR TRAP. PROVIDE NEW HW & CW 1/4 TURN, SCREWED, ANGLE SHUT-OFF VALVES AT WALL. 2) CONNECT NEW SANITARY, NEW CW, AND NEW HW. INSTALL NEW SALON PEDICURE STATION, NEW STRAINER & NEW HAIR TRAP. PROVIDE NEW HW & CW 1/4 TURN, SCREWED, ANGLE SHUT-OFF VALVES (8) INSTALL NEW 82 GALLON WATER HEATER, CONNECT NEW CW, HW & EXPANSION TANK.

CONNECT NEW SANITARY, NEW CW, AND NEW HW. INSTALL NEW SINK, NEW STRAINER, AND NEW P-TRAP. PROVIDE NEW HW & CW 1/4 TURN, SCREWED, ANGLE SHUT-OFF VALVES AT WALL. 4 CONNECT NEW SANITARY, NEW CW, AND NEW HW. INSTALL NEW LAVATORY, NEW STRAINER, NEW P-TRAP AND NEW KEY STOP. PROVIDE NEW HW & CW 1/4 TURN, SCREWED, ANGLE SHUT-OFF VALVES AT WALL. (5) CONNECT NEW SANITARY AND NEW CW. INSTALL NEW WATER CLOSET WITH NEW FLUSH VALVE.

6 CONNECT NEW 3/4"CW TO EXISTING 1"CW. (7) CONNECT NEW 4"SAN TO EXISTING 4"SAN BELOW CONCRETE SLAB.

(9) CONNECT NEW SANITARY, CW AND HW TO NEW WASHING MACHINE CONNECTIONS.

10 CONNECT NEW 2"VENT TO EXISTING 3"VENT.

REMOVE EXISTING SPRINKLER HEAD AND CONNECT NEW SPRINKLER PIPING TO EXISTING.

PROVIDE AND INSTALL NEW LIGHT HAZARD PENDANT SPRINKLER HEAD AND PIPING TO NEW ROOM BELOW. COORDINATE THE LOCATION OF THE NEW SPRINKLER HEAD WITH THE LOCATION OF THE LIGHTS. REFER TO SPRINKLER HEAD DETAIL THIS SHEET.

PROVIDE AND INSTALL NEW LIGHT HAZARD UPRIGHT SPRINKLER HEAD AND PIPING TO NEW ROOM BELOW. COORDINATE THE LOCATION OF THE NEW SPRINKLER HEAD WITH THE LOCATION OF THE LIGHTS. REFER TO SPRINKLER HEAD DETAIL THIS SHEET.

LEGEND DESCRIPTION SYMBOL ABBREV. EXISTING DUCTWORK, PIPING, OR EQUIPMENT TO BE RX. ____ REMOVED. EXISTING PIPING OR EQUIPMENT TO REMAIN. NEW DUCTWORK, PIPING, OR EQUIPMENT CONNECT NEW TO EXISTING AT THIS POINT REMOVE EXISTING TO THIS POINT 1 DRAWING NOTE ABOVE FINISHED FLOOR AFF C.O. CLEANOUT DWG. DRAWING DN DOWN EACH EA. EXISTING EX FD FLR FLOOR DRAIN FLOOR REMOVE EXISTING RX. TYP. TYPICAL VTR VENT THRU ROOF

COLD WATER

HOT WATER

- BRANCH LINE REDUCER COUPLING CEILING PLATE NEW CEILING SPRINKLER HEAD PENDENT DEFLECTOR


CW

BREAK ROOM **+** 13 1-1/4"-EX. 2" 1-1/4"-**+** 13 1-1/4"---1-1/4"---TOILET ROOM 11 EX. 2" EX. 2" TOILET ROOM EX. UPRIGHT SPRINKLER HEAD -13 1-1/4"---EX. UPRIGHT SPRINKLER HEAD -12 EX. 2" EX. 2"-EX. UPRIGHT EX. UPRIGHT SPRINKLER HEAD -SPRINKLER HEAD -EX. 2"-EX. 2"

FLOOR PLAN - SPRINKLERS - NEW WORK

SCALE: 1/4" = 1'-0"

NEW PLUMBING FIXTURE SCHEDULE							
25010	FIXTURE	PIPE CONNECTIONS			MOUNTING	REMARKS	
DESIG.		C.W.	H.W.	SAN.	ARRANGEMENT	NEWARKO	
P-1	WATER CLOSET	1/2"	-	4"	FLOOR MOUNTED	HANDICAP	
P-2	WATER CLOSET	1/2"	-	4"	FLOOR MOUNTED	_	
P-3	LAVATORY	1/2"	1/2"	1-1/2"	WALL MOUNTED	HANDICAP	
P-4	LAVATORY	1/2"	1/2"	1-1/2"	WALL MOUNTED		
P-5	SINK	1/2"	1/2"	1-1/2"	COUNTER MOUNT	STAINLESS STEEL	
P-6	WASHING MACHINE	1/2"	1/2"	1-1/2"			
P-7	REFRIGERATOR	1/2"					
P-8	HAIR WASH	1/2"	1/2"	1-1/2"			
P-9	PEDICURE	1/2"	1/2"	1-1/2"			

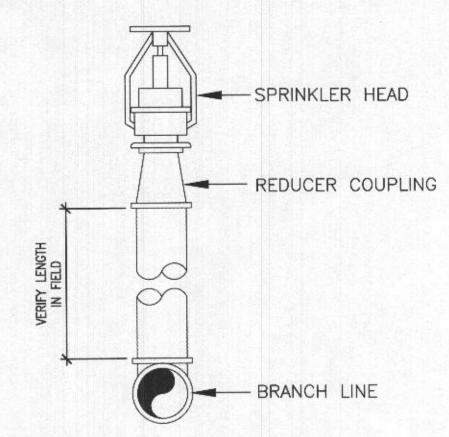

SPRINKLER HEAD DETAILS NOT TO SCALE

SHEET TITLE DRAWN FILE NO.

DRAWING NO.

P-1.1

2"VENT— NEW 4"SANITARY BELOW EX. 4" SANITARY CONCRETE SLAB -BELOW SLAB ---- NEW 4"SANITARY BELOW CONCRETE SLAB - NEW 4"SANITARY BELOW CONCRETE SLAB - NEW 3/4"CW AND 2"VENT-3/4"HW ABOVE CEILIING 2"VENT-P - NEW 3/4"CW AND 3/4"HW ABOVE CEILIING - NEW 3/4"CW AND 1-1/4" 3/4"HW ABOVE CEILING VENT ----3/4"HW ABOVE CEILIING

-NEW 3/4"CW AND

3/4"HW ABOVE CEILING

EX. 1"CW

ABOVE CEILING -

EX. 3" VENT

UP THRU ROOF-

FLOOR PLAN - PLUMBING - NEW WORK

SCALE: 1/4" = 1'-0"

FLOOR PLANS ELECTRICAL **NEW WORK** DESIGNED CHECKED


DRAWN APPROVED

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DATE: 08/18/2022

DRAWING NO.

E-1.1

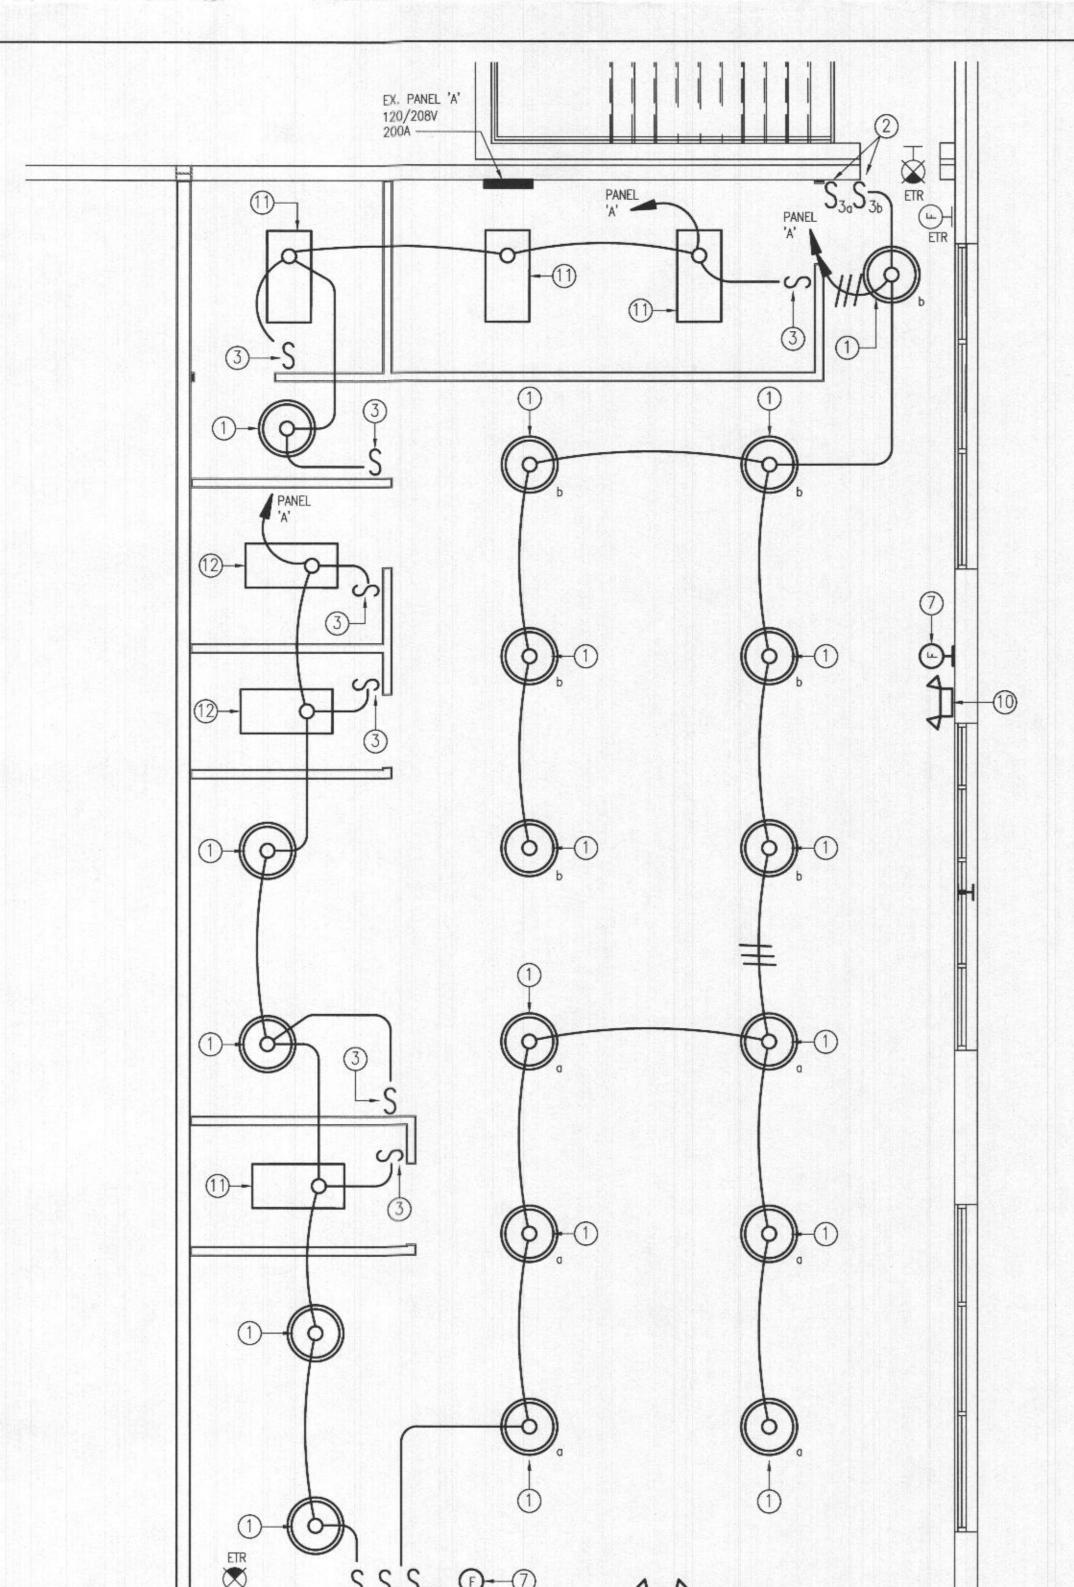

FLOOR PLAN - ELECTRICAL - LIGHTING SCALE: 1/4" = 1'-0"



ACTUAL EXISTING CONDITIONS PRIOR TO FABRICATION OR PERFORMANCE OF ANY WORK.

CONTRACTOR SHALL FIELD VERIFY SOURCE PANELS PRIOR TO COMMENCEMENT OF WORK.

ELECTRICAL GENERAL NOTES

- PROVIDE AND INSTALL NEW PENDANT MOUNTED LED LIGHTING FIXTURE IN LOCATIONS SHOWN AND EXTEND #12 WIRING AND RACEWAY TO PANEL 'A'.
- PROVIDE AND INSTALL NEW RECESSED THREE-WAY TOGGLE SWITCH(ES) AND EXTEND #12 WIRING IN NEW RACEWAY AND NEW 3/4" FLEXIBLE METAL CONDUIT TO NEW LIGHTING FIXTURES.

INFORMATION SHOWN ON THIS DRAWING PERTAINING TO EXISTING CONDITIONS HAS BEEN OBTAINED FROM AVAILABLE BUILDING DRAWINGS OR GENERAL FIELD OBSERVATIONS AND MAY NOT INDICATE ACTUAL EXISTING CONDITIONS IN DETAIL OR DIMENSION. THE CONTRACTOR IS RESPONSIBLE FOR DETERMINING THE

- PROVIDE AND INSTALL NEW RECESSED SINGLE POLE TOGGLE SWITCHES AND EXTEND #12 WIRING IN NEW RACEWAY AND NEW 3/4" FLEXIBLE METAL CONDUIT TO NEW LIGHTING FIXTURES.
- (4) PROVIDE AND INSTALL RECESSED DUPLEX RECEPTACLE MOUNTED 18" ABOVE FINISHED FLOOR AND EXTEND #12 WIRING AND RACEWAY TO NEW 1P 15A CIRCUIT BREAKER IN 'PANEL A'.
- PROVIDE AND INSTALL DEDICATED RECESSED DUPLEX RECEPTACLE MOUNTED 18" ABOVE FINISHED FLOOR AND EXTEND #12 WIRING AND RACEWAY TO NEW 1P 15A CIRCUIT BREAKER IN 'PANEL A'.
- PROVIDE AND INSTALL NEW POWER POLE TO EXTEND ABOVE CEILING.
- PROVIDE AND INSTALL NEW WALL MOUNTED FIRE ALARM HORN/STROBE AT LOCATION SHOWN AND CONNECT TO EXISTING FIRE ALARM SYSTEM. NEW FIRE ALARM CABLE SIZE AND TYPE TO MATCH EXISTING IN FIELD. NEW HORN/STROBE TO BE EDWARDS SYSTEMS TECHNOLOGY "757 SERIES TEMPORAL HORN" NOTIFICATION DEVICE. UPON COMPLETION, TEST AND RE-CERTIFY FIRE ALARM
- WATER HEATER CONNECTION: EXTEND #12 WIRING AND RACEWAY TO NEW 1P 20A CIRCUIT BREAKER IN
- 9 NEW EXHAUST FAN PROVIDED BY MECHANICAL. EXTEND #12 WIRING AND RACEWAY TO NEW 15A CIRCUIT BREAKER IN EXISTING PANEL 'A'. SIZE OVERLOAD PER MANUFACTURER'S NAMEPLATE DATA AND
- PROVIDE AND INSTALL NEW WALL MOUNTED EMERGENCY LIGHTING UNIT WITH (2) FULLY ADJUSTABLE 7.2W SEALED BEAM LAMPS, 120/277VAC INPUT, AND SELF— DIAGNOSTIC ELECTRONICS. NEW LIGHTING UNIT TO BE DUAL-LITE 'EZ-2' SERIES, OR APPROVED EQUAL.
- PROVIDE AND INSTALL NEW RECESSED LED LIGHTING FIXTURE IN LOCATIONS SHOWN AND EXTEND #12 WIRING AND RACEWAY TO PANEL 'A'.
- PROVIDE AND INSTALL NEW SURFACED MOUNTED LED LIGHTING FIXTURE IN LOCATIONS SHOWN AND EXTEND #12 WIRING AND RACEWAY TO PANEL 'A'.

PROFESSIONAL CERTIFICATION I HEREBY CERTIFY THAT THESE DOCUMENTS WERE PREPARED OR APPROVED BY ME, AND THAT I AM A DULY LICENSED PROFESSIONAL ENGINEER UNDER THE LAWS OF THE STATE OF MARYLAND. LICENSE NO. 36251 EXPIRATION DATE: 08/31/2024

V VOLTS

LEGEND SYMBOL DESCRIPTION 2X4 SURFACE MOUNTED LED LIGHT FIXTURE. PENDANT MOUNTED DOWNLIGHT FIXTURE - INDICATES CONTROLLING SWITCHES SINGLE POLE TOGGLE SWITCH - SUBSCRIPT INDICATES FIXTURES CONTROLLED BY THE SWITCH(TYPICAL FOR ALL LIGHTING SWITCHES) 48" A.F.F. SURFACE OR RECESSED MOUNTED ELECTRIC PANELBOARD (208Y/120V). SOLID LIGHT LINE WEIGHT DESIGNATES EXISTING WORK TO REMAIN ON DEMOLITION AND NEW WORK ---DASHED HEAVY LINE WEIGHT DESIGNATES REMOVAL WORK ON DEMOLITION PLANS. SOLID HEAVY LINE WEIGHT DESIGNATES NEW WORK ON NEW WORK PLANS. DRAWING NOTE - DEMOLITION. DRAWING NOTE - NEW WORK. WALL MOUNTD EXIT SIGN. MOUNT 7'-6" A.F.F., OR 6" ABOVE DOOR UNLESS NOTED OTHERWISE. SHADED AREA INDICATES STENCIL FACE. DUPLEX GROUNDING TYPE CONVENIENCE RECEPTACLE (NEMA 5-20R) RECESSED WALL MOUNTED -18" A.F.F. DUPLEX GROUNDING TYPE GROUND FAULT INTERRUPTER (GFI) TYPE, CONVENIENCE RECEPTACLE (NEMA 5-20R) RECESSED WALL MOUNTED 8" ABOVE COUNTER. WHERE THERE IS NO COUNTER, MOUNT 48" A.F.F. EMERGENCY BATTERY LIGHTING UNIT, WALL MOUNTED 7'-6" A.F.F., UNLESS NOTED OTHERWISE. CONNECT TO UNSWITCHED HOT LEG OF BRANCH CIRCUIT. HOMERUN TO PANELBOARD WITH PANELBOARD IDENTIFICATION. NUMBER OF ARROWS INDICATES QUANTITY OF CIRCUITS. NUMBER OF HASH MARKS INDICATES QUANTITY OF #12 CONDUCTORS (UNLESS NOTED OTHERWISE), NOT INCLUDING GROUND WIRE. WHERE NO HASH MARKS APPEAR TWO

AMPS, AMPERES

A.F.F. ABOVE FINISHED FLOOR

CONDUCTORS PLUS GROUND CONDUCTOR IN 3/4" CONDUIT (UNLESS NOTED OTHERWISE) ARE

ABBREVIATIONS

GRD GROUND KELVIN

PNL PANEL

COLOR RENDERING INDEX NEC NATIONAL ELECTRICAL CODE POLE

ETR EXISTING TO REMAIN

EX. PANEL 'A'

120/208V

200A ---

FLOOR PLAN - ELECTRICAL - POWER

SCALE: 1/4" = 1'-0"

SEP 1 3 2022

FICE, DIVISIO