

SECOND LEVEL CEILING FRAMING PLAN SCALE 1/4"=1'-0

KEY NOTES:

- 1. EXISTING TRUSSES, 24" O.C WITH FLAT CEILING.
- 2. NEW ENGINEERED TRUSSES WITH TRAY CEILING IN MASTER BEDROOM.
- 3. NEW TURNED GABLE OVER BUILD CENTERED ON WINDOWS BELOW, 8/12 PITCH. NEW ASPHALT SHINGELS.
- 4. EXISTING ROOF OVER EXISTING FIRST FLOOR FAMILY ROOM AND PORCH. INSTALL STANDING SEAM METAL ROOFING
- 5. NEW OVERBUILD ROOF OVER FOYER AND NEW PORCH, 12/12 PITCH WITH ASPHALT SHINGELS.
- 6. NEW 4/12 PITCH ROOF. INSTALL STEEL STANDING SEAM METAL ROOFING, COLOR TO BE SELECTED.
- NEW OVERBUILD ROOF OVER NEW BEDROOM. 12/12 PITCH WITH ASPHALT SHINGLES, COLOR TO BE SELECTED.
- 8. NEW (3) 2 X 8 MINIMUM HEADER AT EXTERIOR WINDOW OPENINGS. 9. NEW UPSET (3) 1 $\frac{3}{4}$ X 14" LVL HEADER.
- 9. NEW UPSET (3) 1 4/7 X 14" LVL HEADER 10.NEW (2) 1 3/4" X 7 1/4" LVL HEADER.
- 11.NEW (2) $1\frac{3}{4}$ " X $7\frac{3}{4}$ " X $7\frac{1}{4}$ " LVL HEADER, UPSET.



Field & Tung Structural Engineers
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Third Floor
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PROJECT NAME:

SCHLEIGH RESIDENCE

11830 RAMSBURG ROAD MARRIOTSVILLE, MD 21104

WINTHORPE DESIGN & BUILD, INC.

13050 WAINWRIGHT ROAD Highland MD 20777 301-854-2092



DRAWING TITLE:


STRUCTURAL LAYOUT SECOND LEVEL CEILING

No.	Description	Date

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S.02.3

SCALE AS INDICATED

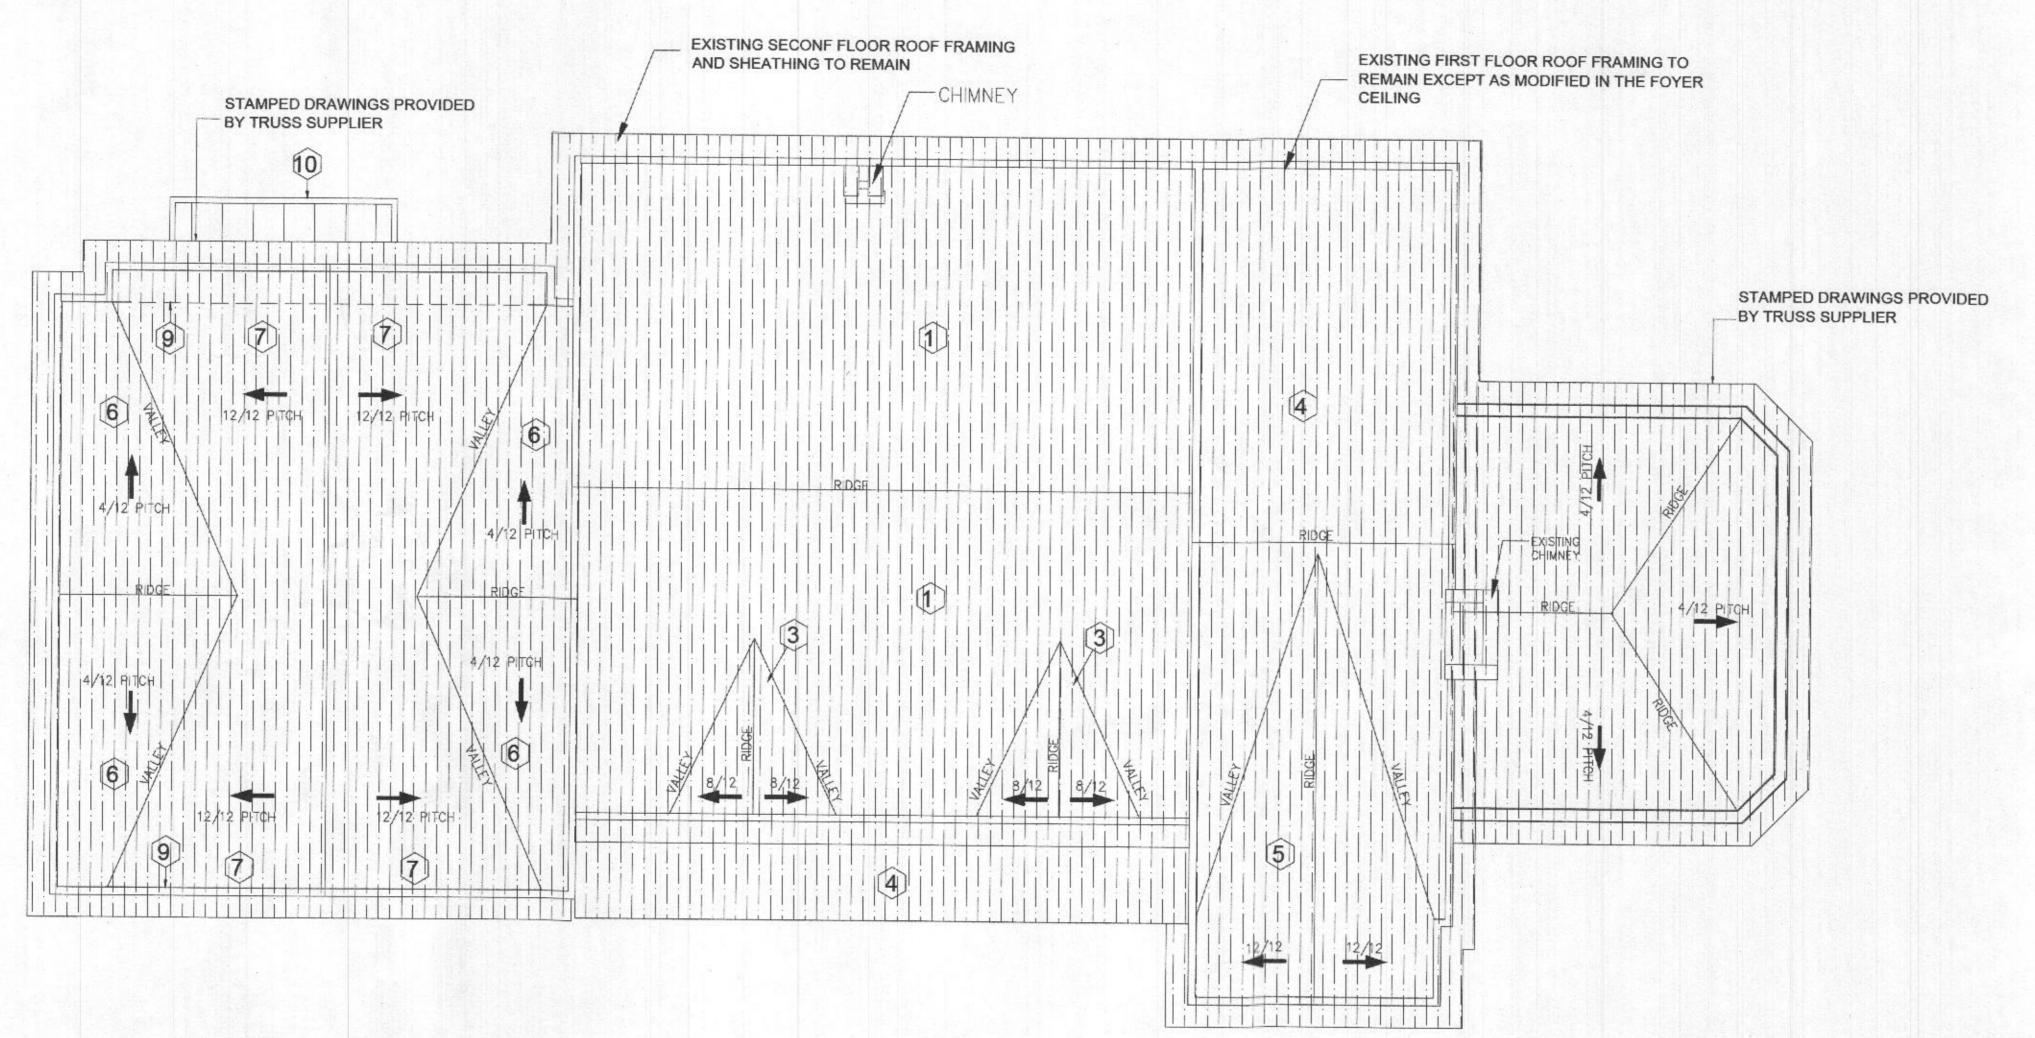

ROOF FRAMING PLAN Scale: 1/4" = 1'-0"

KEY NOTES:

- 1. EXISTING TRUSSES, 24" O.C WITH FLAT CEILING.
- 2. NEW ENGINEERED TRUSSES WITH TRAY CEILING IN MASTER BEDROOM.
- 3. NEW TURNED GABLE OVER BUILD CENTERED ON WINDOWS BELOW, 8/12 PITCH, 2X6 RAFTERS.
- NEW ASPHALT SHINGLES.
- 4. EXISTING ROOF OVER EXISTING FIRST FLOOR FAMILY ROOM AND PORCH. INSTALL STANDING SEAM METAL ROOFING
- 5. NEW OVERBUILD ROOF OVER FOYER AND NEW PORCH, 12/12 PITCH WITH ASPHALT
- SHINGLES USING 2X6 RAFTERS.
- 6. NEW 4/12 PITCH ROOF. INSTALL STEEL STANDING SEAM METAL ROOFING, COLOR TO BE SELECTED.
- 7. NEW OVERBUILD ROOF OVER NEW BEDROOM. 12/12 PITCH WITH ASPHALT SHINGLES, COLOR TO BE SELECTED.
- 8. NEW (2) 2 X 6 HEADER @ OPENING 3' LESS 9. NEW CONTINUOUS (3) 1 3" X 11 7" LVLV HEADER BELOW
- 10.NEW 2X6 RAFTERS, 16" O.C OVER TUB AREA WITH STANDING SEAM ROOF.



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DRAWING TITLE:

ROOF PLAN

No.	Description	Date

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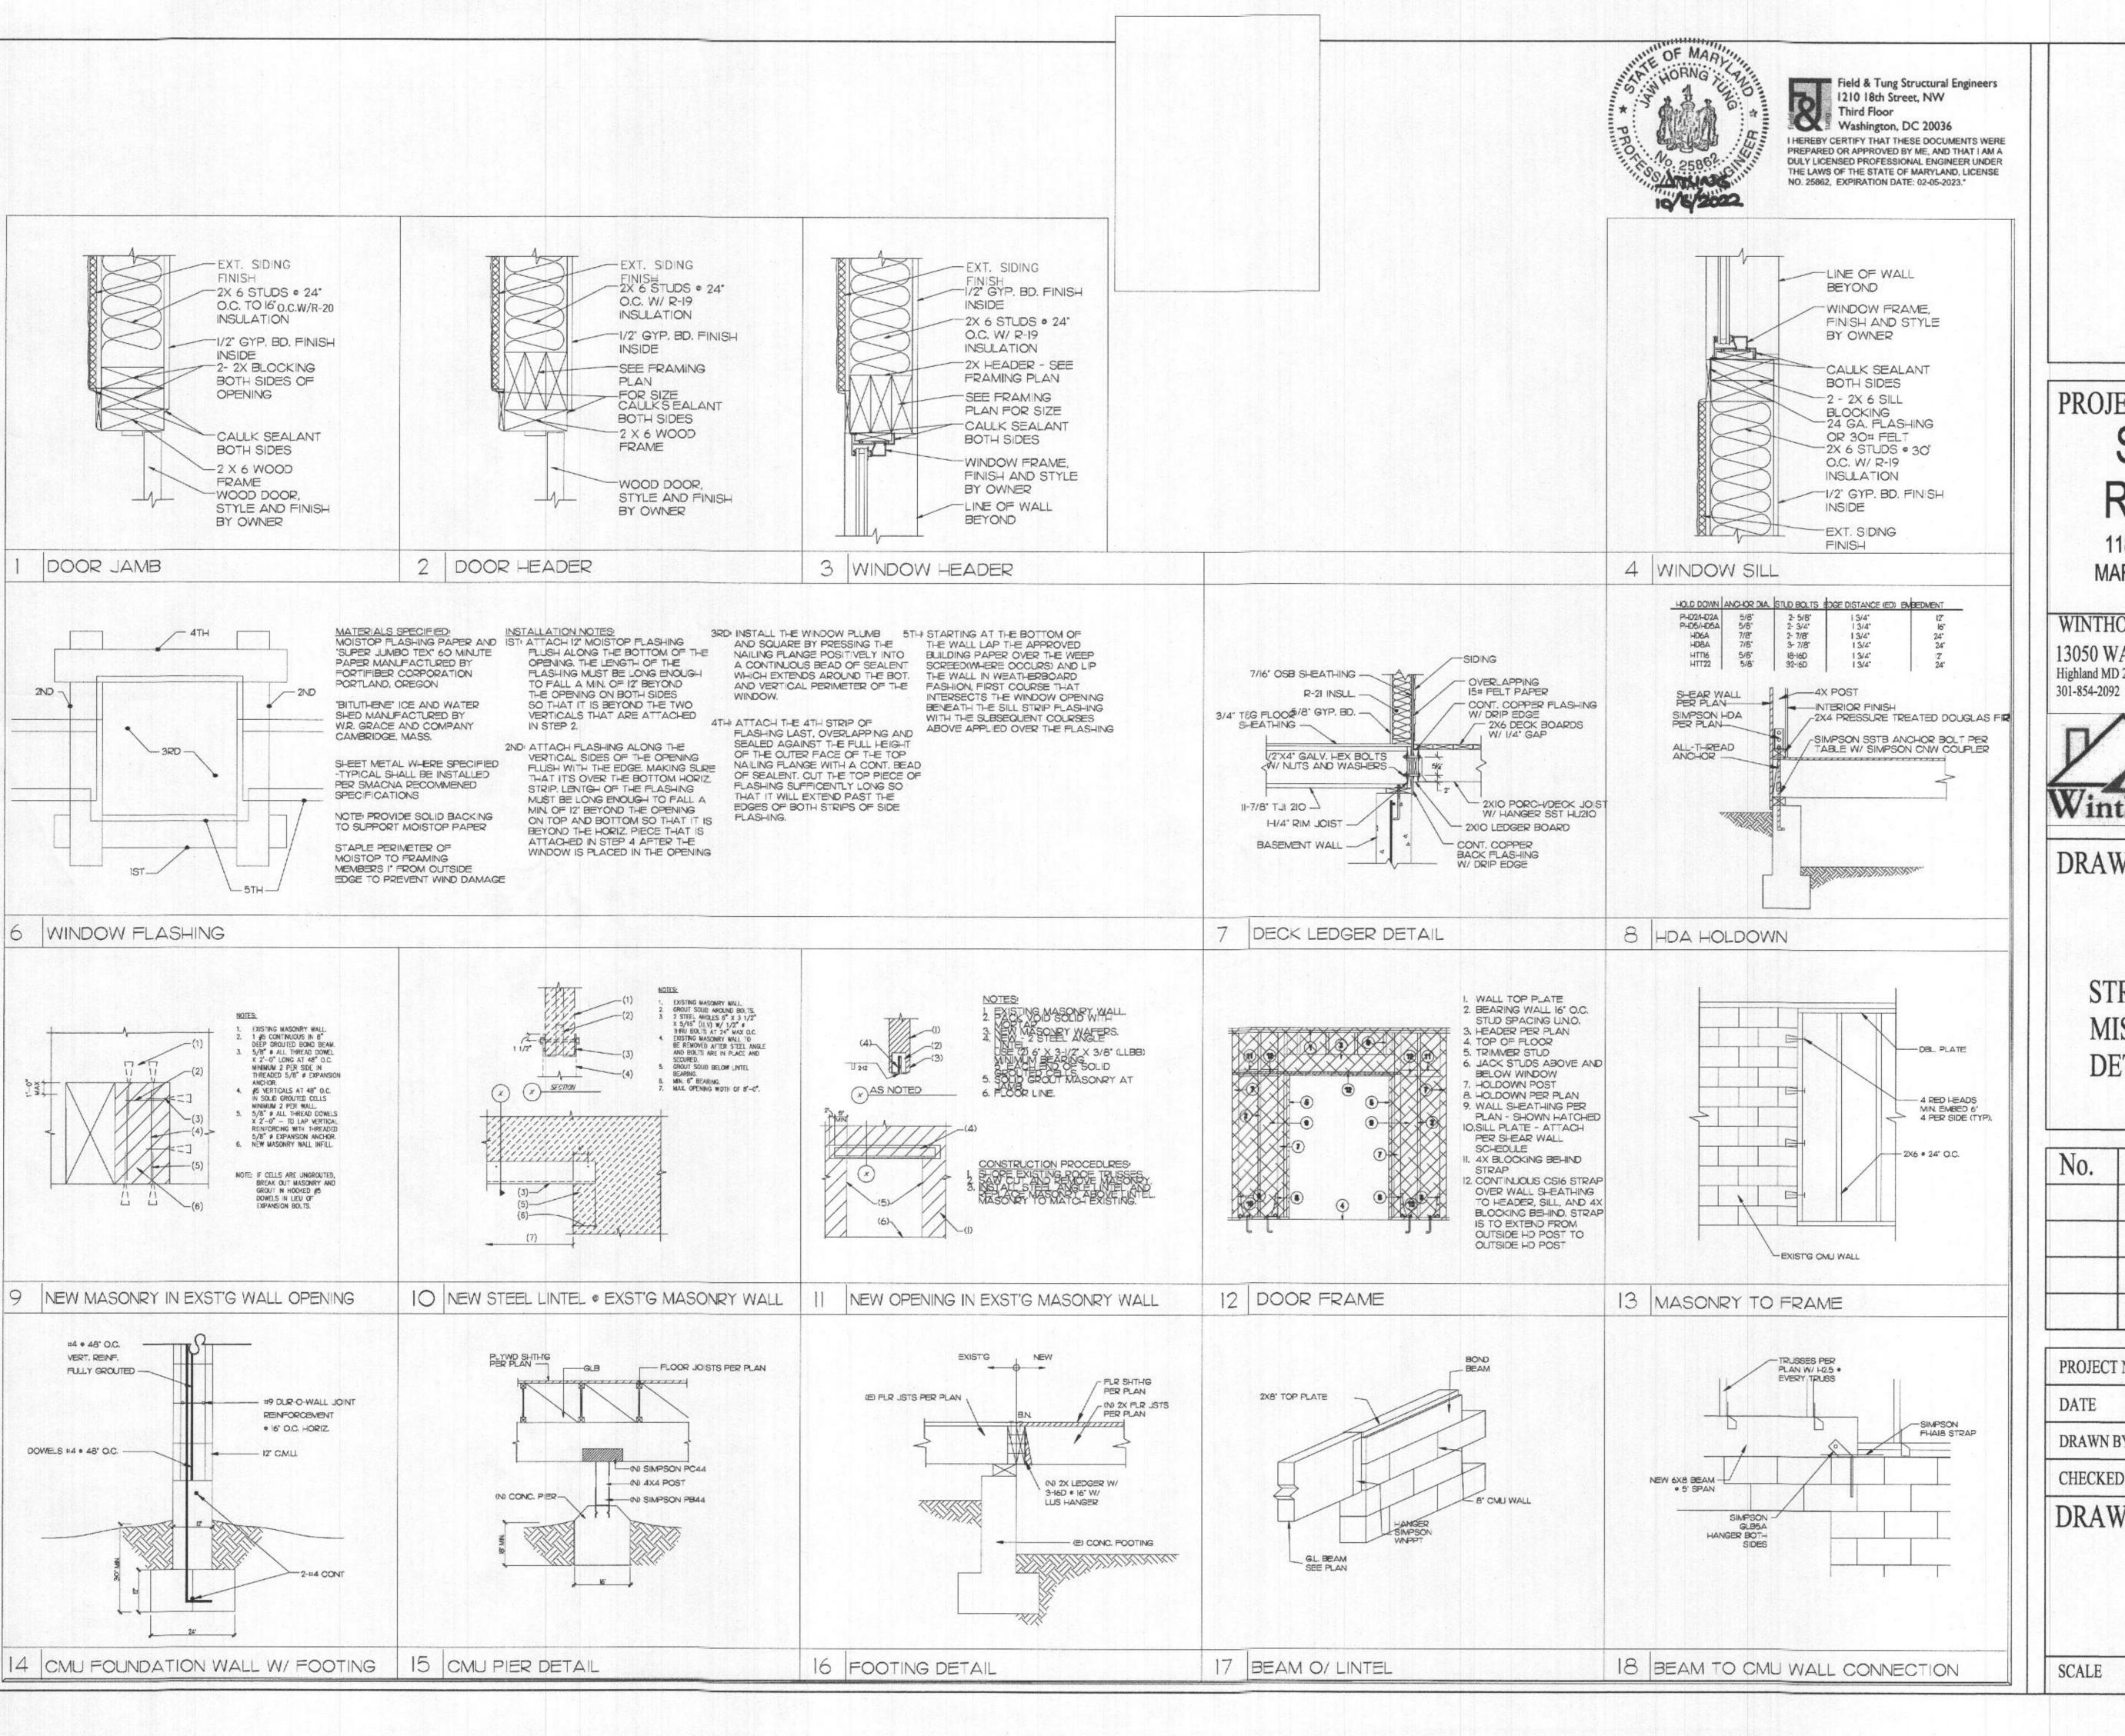
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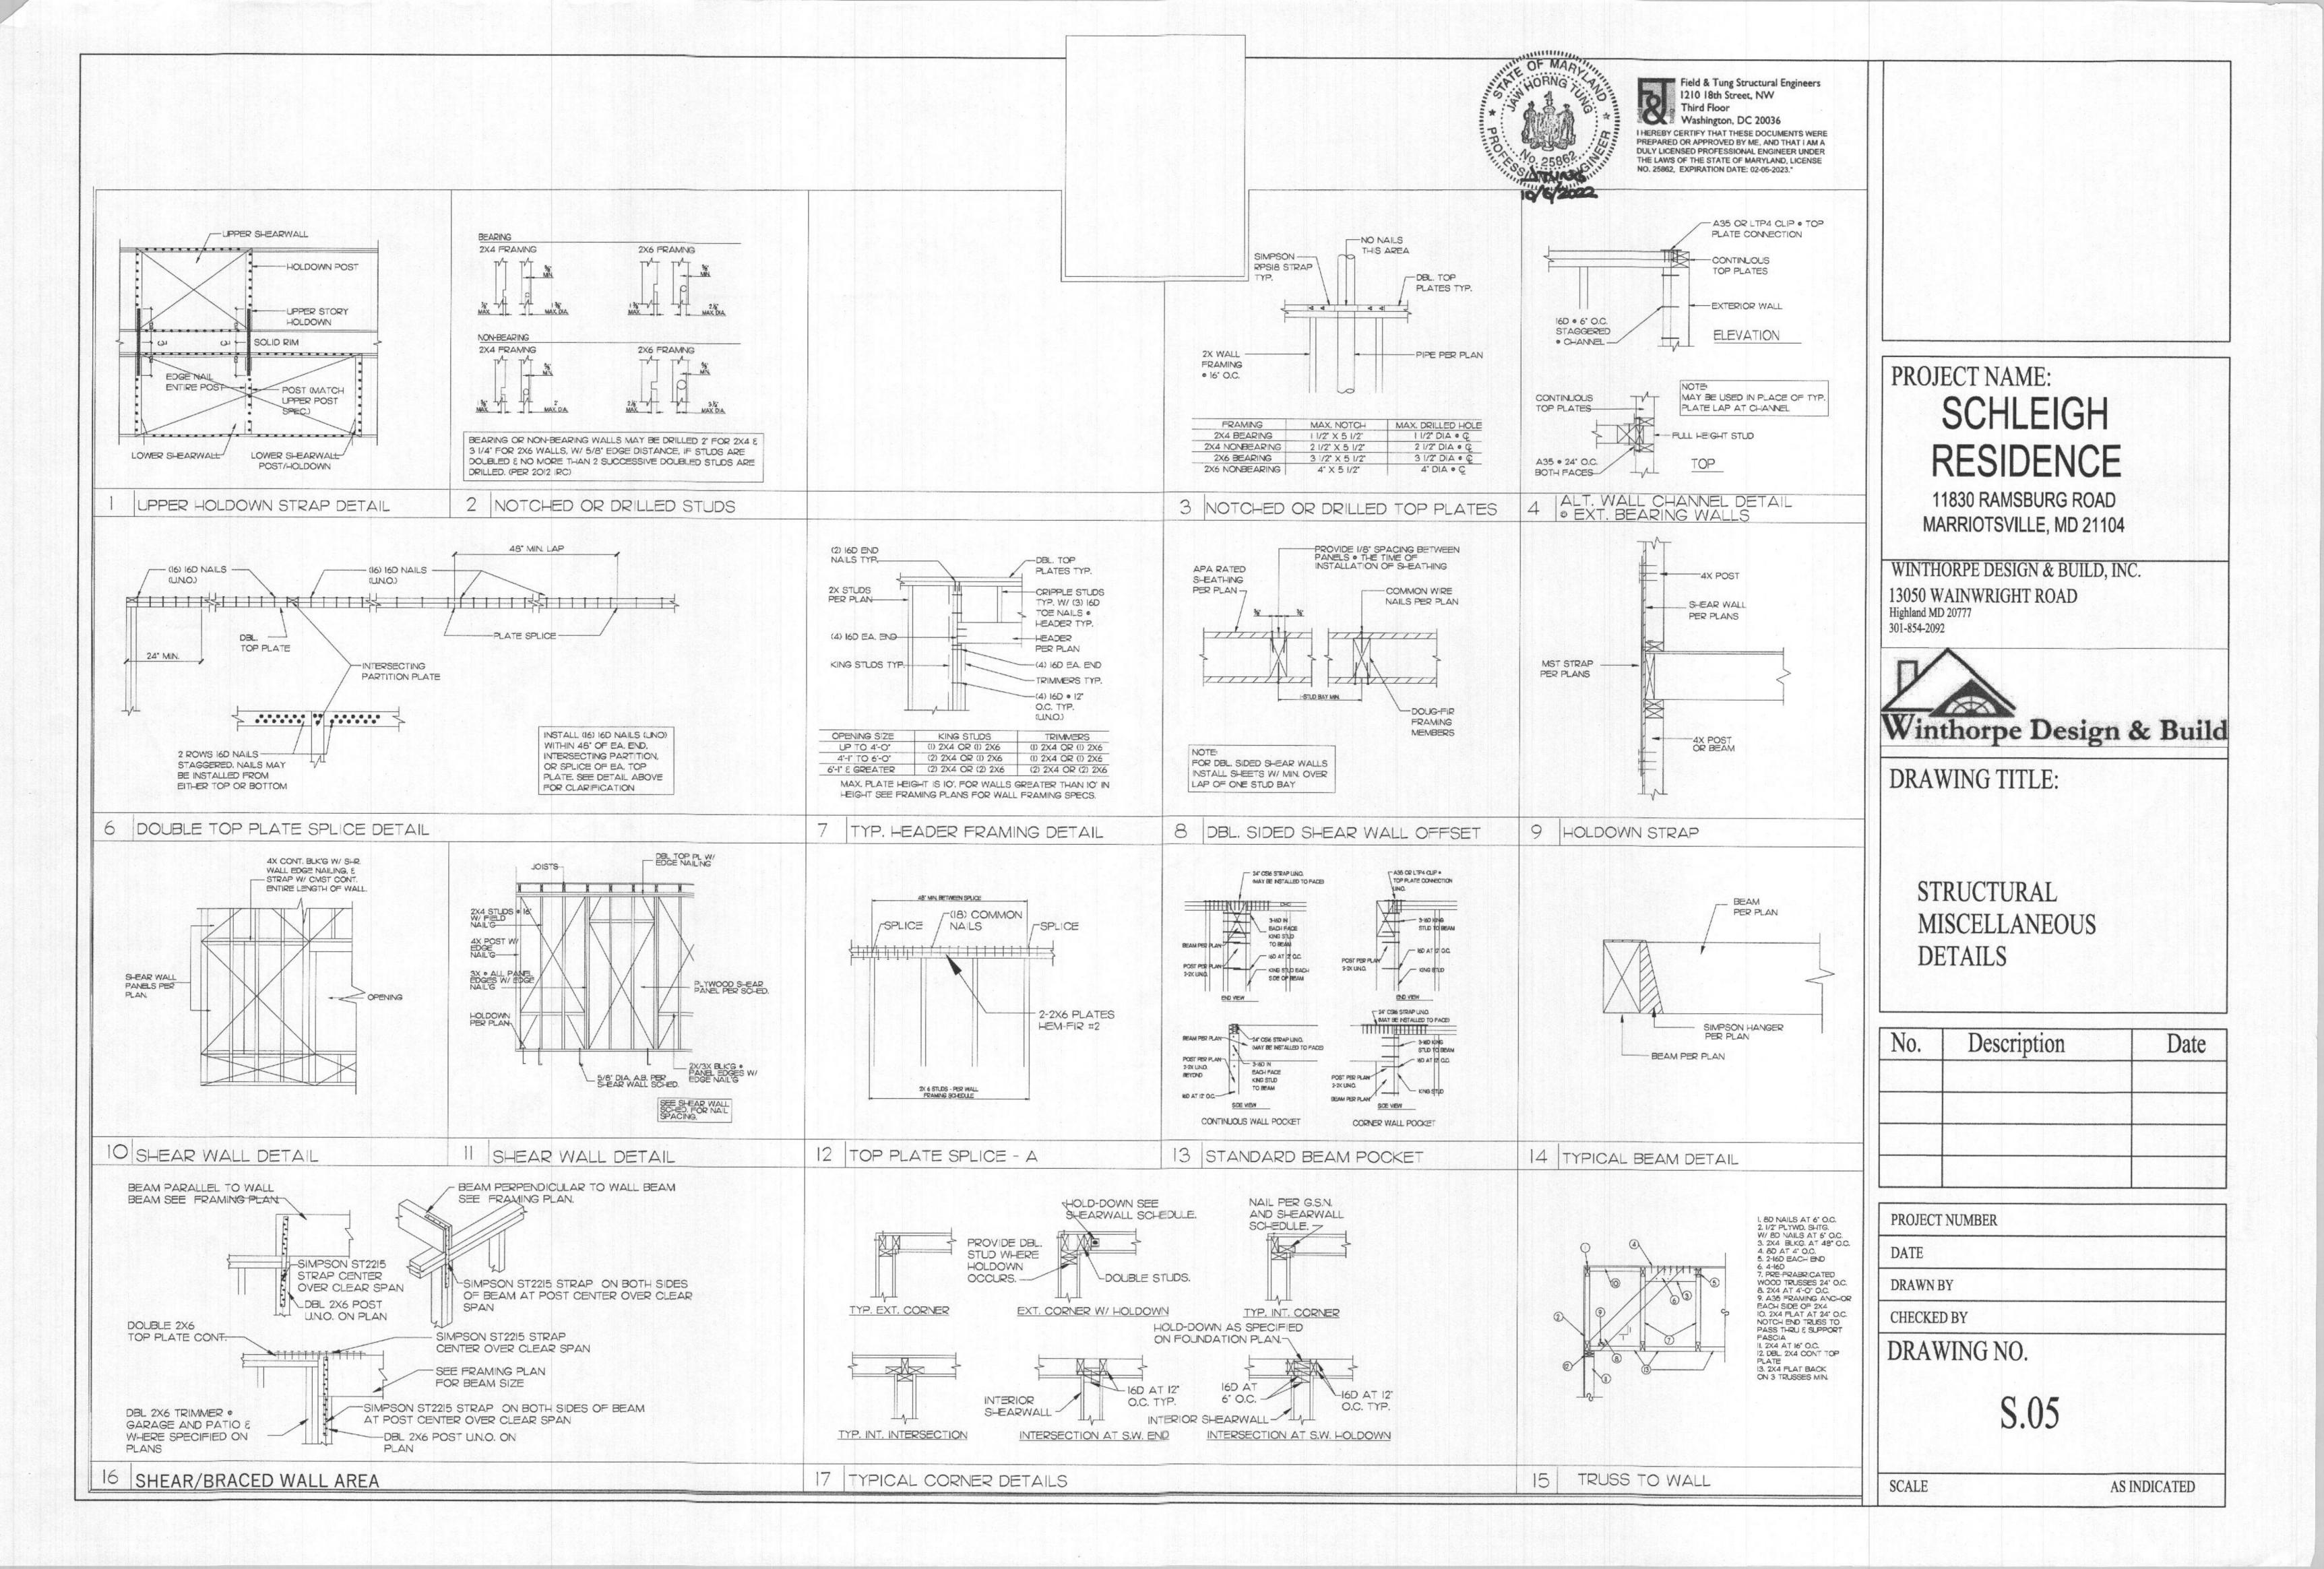
STRUCTURAL MISCELLANEOUS DETAILS


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Highland MD 20777



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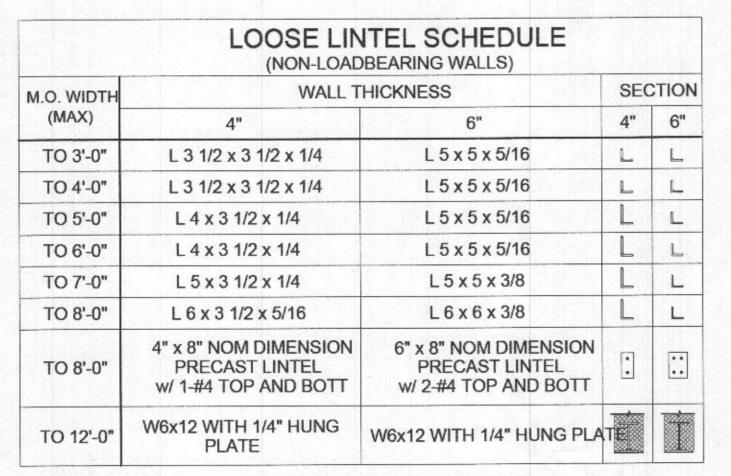
STRUCTURAL MISCELLANEOUS DETAILS

Description	Date

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CALE AS INDICATED

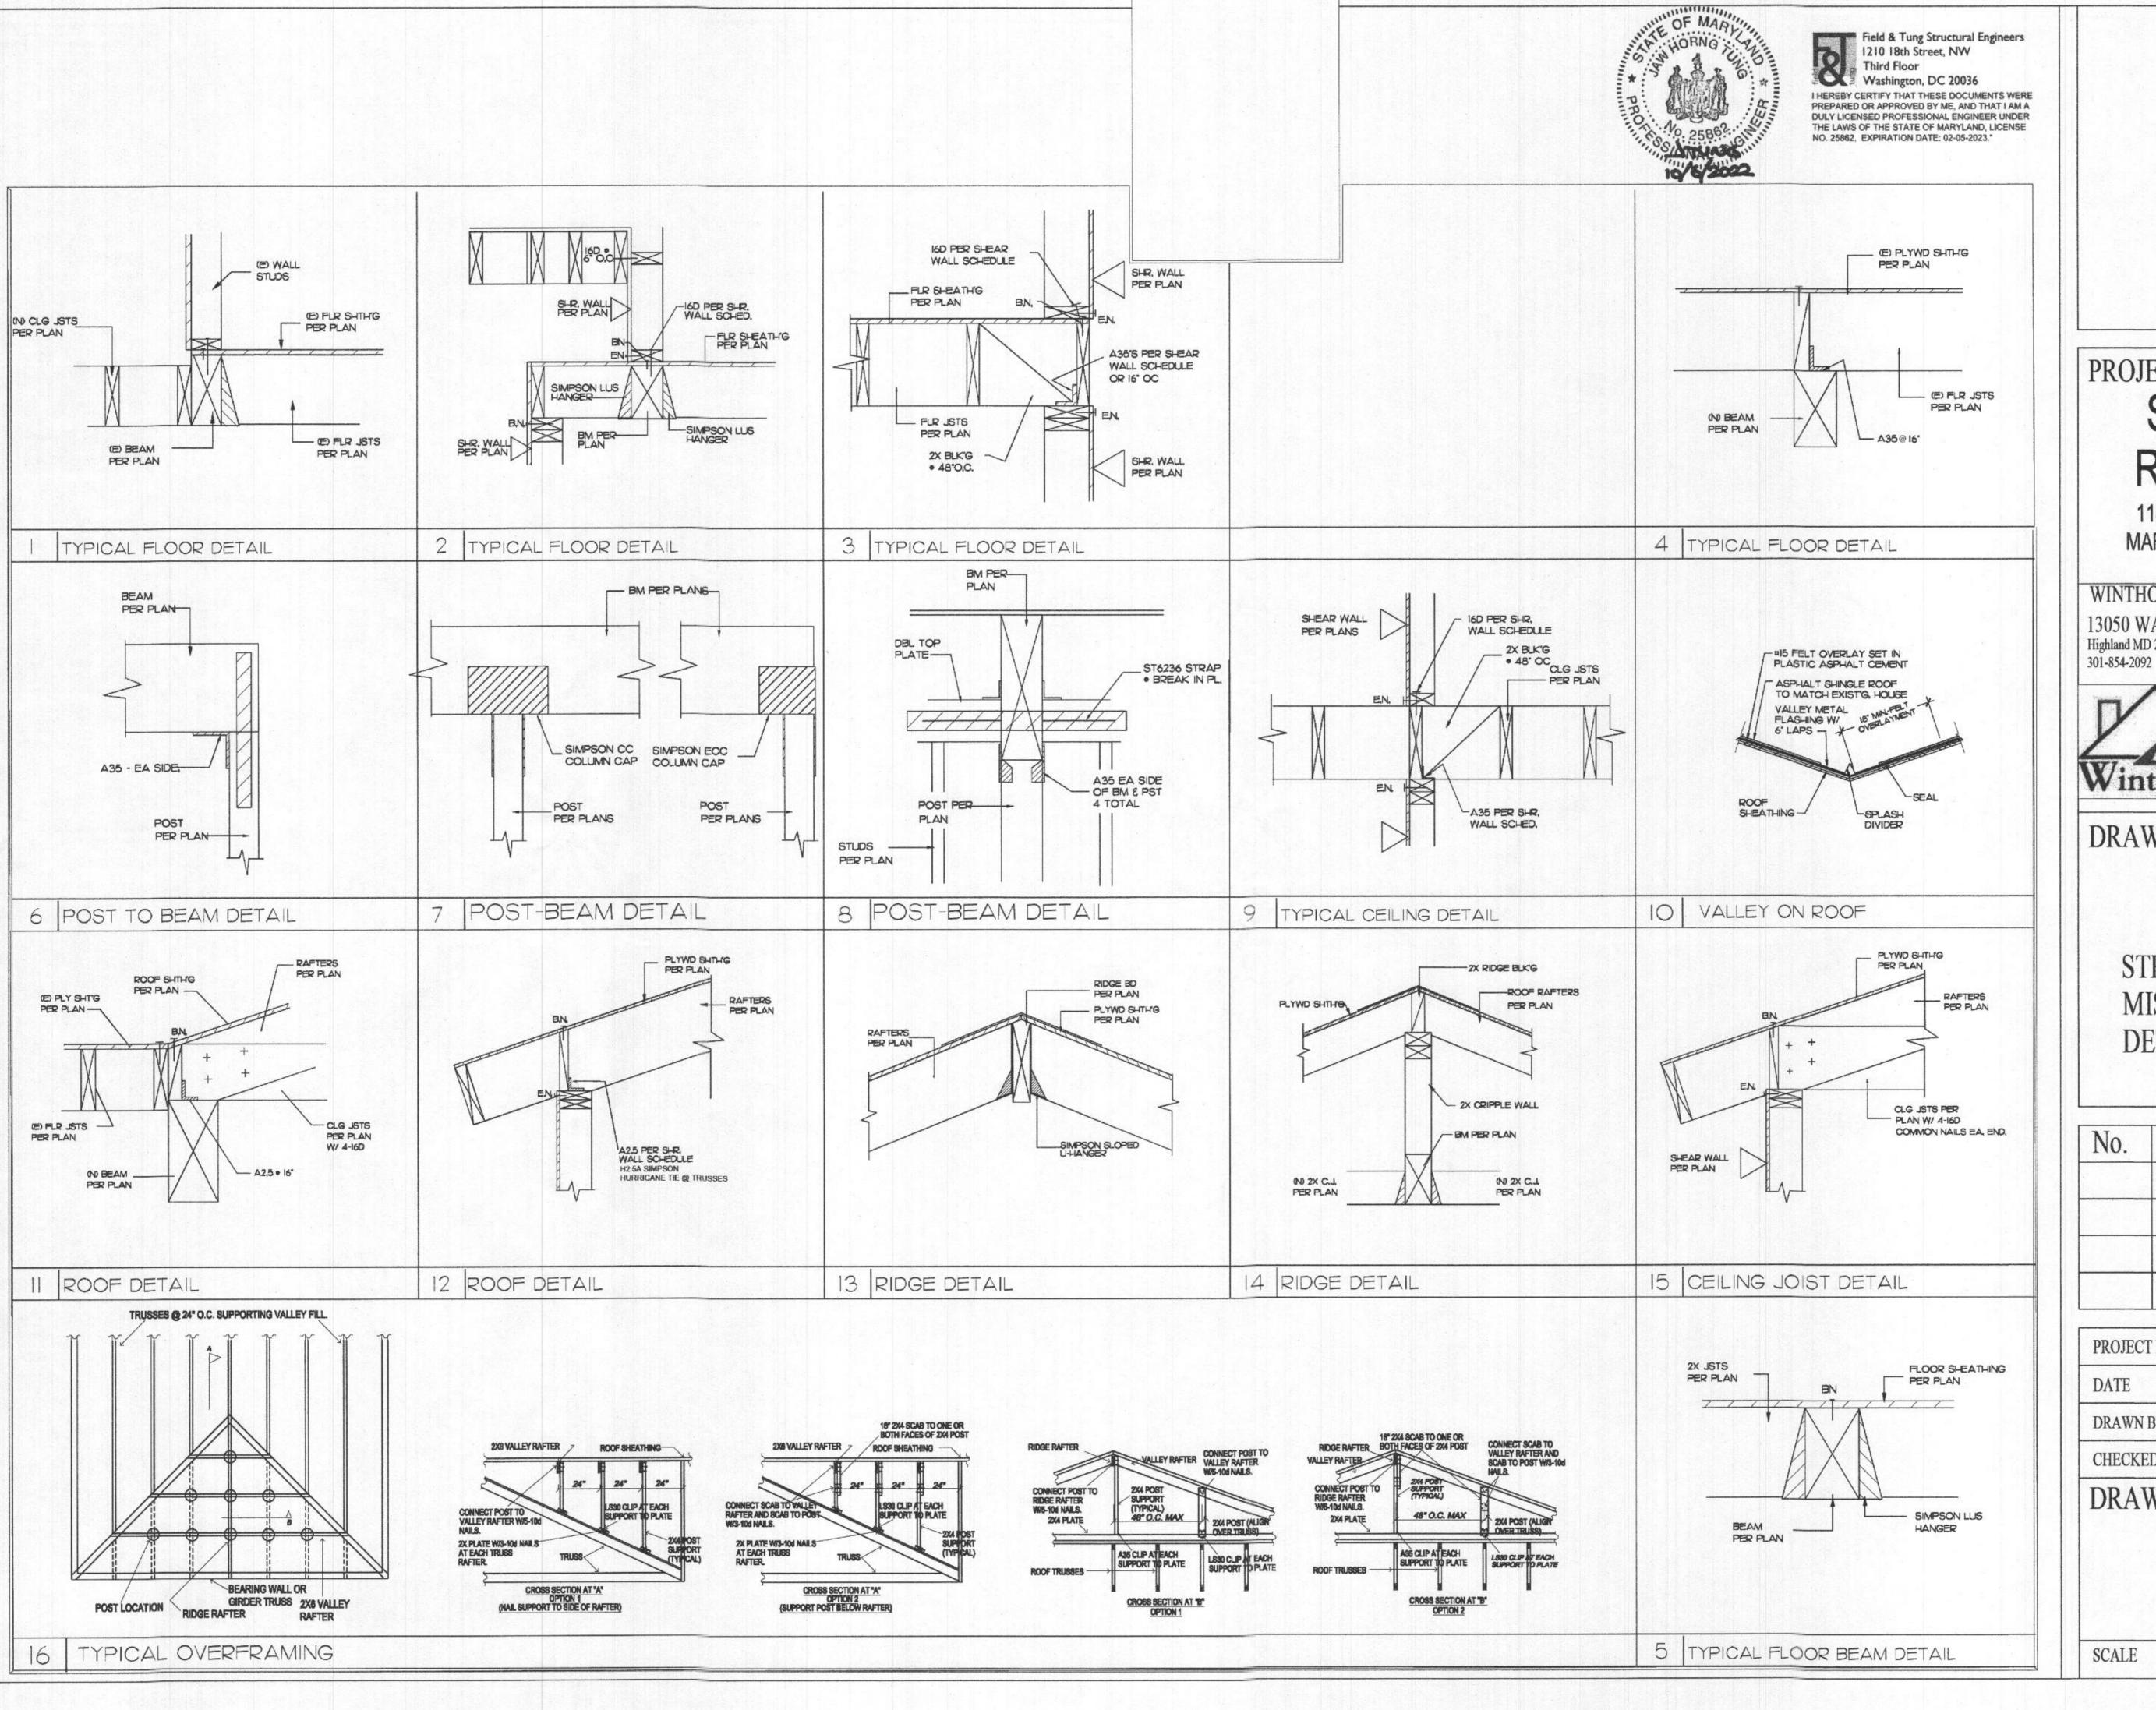

BEARING AND NON-LOADBEARING WALL LINTEL SCHEDULE NOTES:


1. GALV ALL LINTELS IN EXTERIOR WALLS AND EXTERIOR WALL BACKUP.
2. MINIMUM THICKNESS OF LOOSE LINTEL ANGLES IN EXTERIOR WALLS TO BE 5/16".


3. BEARING WIDTH SHALL BE 1" PER FOOT OF CLEAR SPAN ON EACH END.
MINIMUM WIDTH SHALL BE 8" IN BEARING WALLS, AND 6" IN NON- LOADBEARING

- 4. GROUT CMU FOR (16") x (FULL HEIGHT OF OPENING) TO UNDERSIDE OF LINTEL BEARING (TYP, UNO).
- GROUT OPEN CELLS OF UPPER COURSES MONOLITHICALLY W/ U-SHAPED BLOCK LINTEL.
 PRECAST CONCRETE (PC) LINTELS SHALL BE MADE OF 3000 PSI CONCRETE
- (MINIMUM 28 DAY COMPRESSIVE STRENGTH).
 7. USE (2) 4" PC UNITS FOR 8" WALL, 4" + 6" PC UNITS FOR 10" WALL,


(2) 6" OR (3) 4" PC UNITS FOR 12" WALL, ETC.

8. USE ARCHITECTURAL AND MECHANICAL DRAWINGS TO COORDINATE LINTEL ELEVATIONS WITH DOOR SCHEDULE, CEILING HEIGHTS, DUCT ELEVATIONS, ETC. SHOP DRAWINGS SHALL BE SUBMITTED FOR REVIEW WITH THIS INFORMATION.

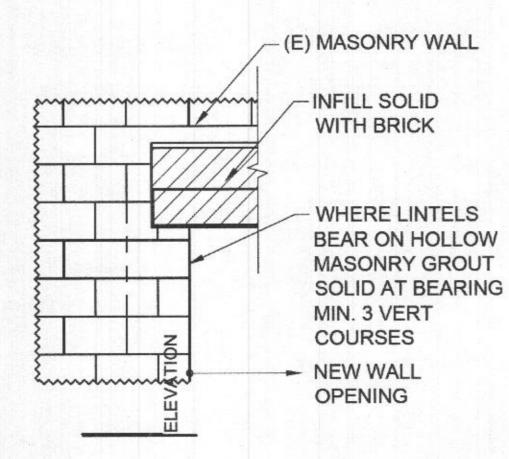


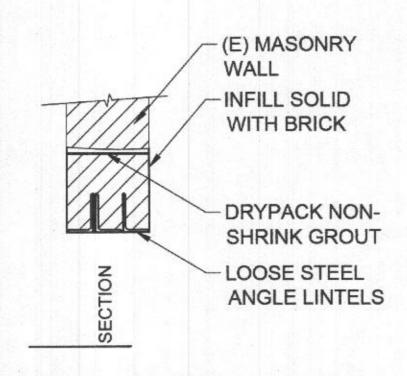


NOTES: LOOSE STEEL ANGLE LINTELS NOT INTENDED TO BE USED UNDER BEAM BEARING, UON.

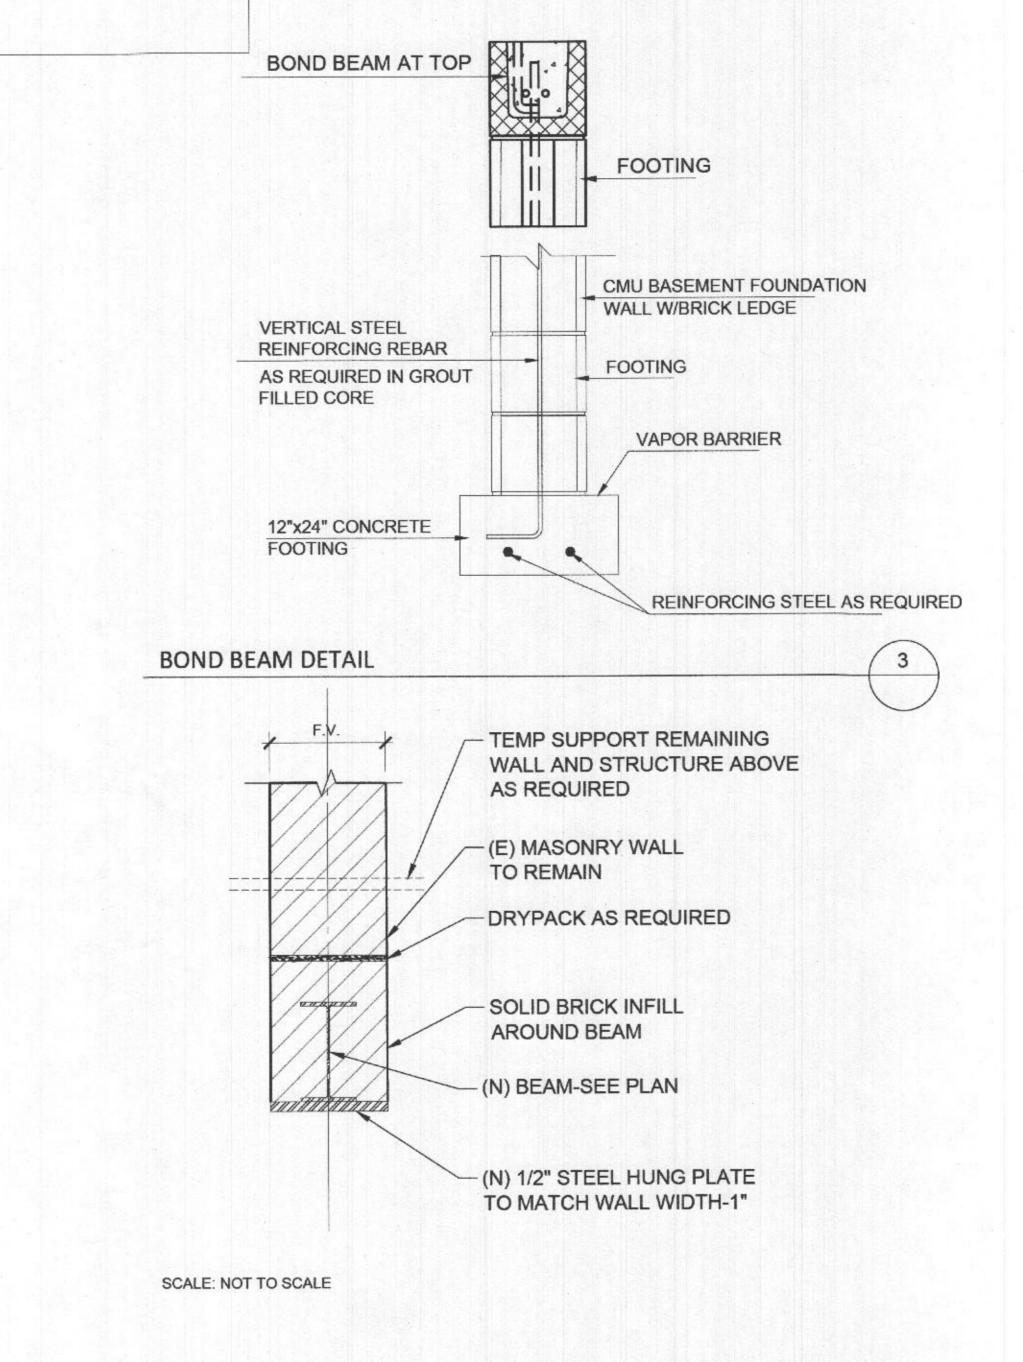

TYPICAL LOOSE STEEL ANGLE LINTEL

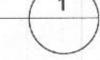

TYPICAL STEEL HEADER

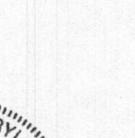

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DRAWING TITLE:

TYPICAL LOOSE STEEL ANGLE LINTEL

No.	Description	Date

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SCALE AS INDICATED

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GENERAL NOTES

1. ALL ELECTRICAL WORK SHALL CONFORM TO APPLICABLE LOCAL CODES, THE INTERNATIONAL RESIDENTIAL CODE 2012 EDITION, AND WITH THE NATIONAL ELECTRICAL CODE 2011 EDITION.

2. CONTRACTOR TO VERIFY THE EXACT LOCATION FOR OUTLETS, LIGHTS, SWITCHES, CABLE, DATA,

PHONE, AUDIO, ETC. WITH OWNER.

3. PROVIDE ONE SMOKE DETECTOR IN EACH ROOM AND ONE IN EACH CORRIDOR ACCESSING BEDROOMS. CONNECT SMOKE DETECTORS TO HOUSE POWER AND INTER-CONNECT SMOKE DETECTORS SO THAT, WHEN ANY ONE IS TRIPPED, THEY ALL WILL SOUND. PROVIDE BATTERY BACKUP FOR ALL UNITS.

4. CARBON MONOXIDE DETECTORS ARE TO BE INSTALLED IN EACH CORRIDOR ACCESSING BEDROOMS. CARBON MONOXIDE DETECTORS TO BE HARDWIRED AND INTER-CONNECTED.

5. CIRCUITS SHALL BE VERIFIED WITH HOME OWNER PRIOR TO WIRE INSTALLATION.

5. FINAL SWITCHES FOR TIMERS AND DIMMERS SHALL BE VERIFIED WITH HOME OWNER.

. FIXTURES TO BE SELECTED BY HOME OWNER.

8. ELECTRICAL RECEPTACLES IN BATHROOMS, KITCHENS AND GARAGES SHALL BE GFCI PER NATIONAL ELECTRICAL CODE REQUIREMENTS.

9. GROUND FAULT CIRCUIT INTERRUPTERS (GFCI) SHALL BE USED ON ALL WIRING IN EXTERIOR OUTLETS.

10. GROUNDING TO COMPLY WITH NEC AND THE UFER GROUNDS SHALL BE INCLUDED IN THE FOUNDATION AND SHALL BE CONNECTED TO THE ELECTRICAL SERVICE DISCONNECT.

11. ALL 125-VOLT, 15-AND 20- AMPERE RECEPTACLE OUTLETS SHALL BE LISTED TAMPER RESISTANT RECEPTACLES.

12. SERVICE ENTRANCE CONDUCTORS ENTERING OR ON THE EXTERIOR OF THE STRUCTURE SHALL

BE INSULATED.

13. PROVIDE (2) 20 AMP (MIN.) SMALL APPLIANCE BRANCH CIRCUITS AND ARE LIMITED TO SUPPLYING WALL AND COUNTER SPACE OUTLETS (NOTE THEY CANNOT SERVE OUTSIDE PLUGS, RANGE HOODS, GARBAGE DISPOSALS, DISHWASHERS OR MICROWAVES - ONLY THE REQUIRED COUNTERTOP/WALL OUTLETS MAY INCLUDE THE REFRIGERATOR) AS PER NEC.

4. LIGHT SWITCHES SHALL BE MOUNTED AT 3'-3" ABOVE FINISH FLOOR,

U.N.O.-LUTRON "SNOW WHITE " FINISH.

15. A RECEPTACLE SHALL BE INSTALLED ON BOTH SIDES OF AN APPLIANCE OR PLUMBING FIXTURE MOUNTING WITHIN A COUNTER TOP. THIS SHALL INCLUDE OPEN ENDED ISLAND CONFIGURATION.

16. ALL FIXTURES TO BE INSTALLED OUTSIDE, OR IN WET OR DAMP LOCATIONS INSIDE, SHALL BE UL

LISTED FOR SUCH LOCATIONS.

17. CONTRACTOR SHALL COORDINATE EXACT LOCATIONS OF ALL FIXTURES WITH OWNER, PRIOR TO FINAL INSTALLATION. SPECIFIC FIXTURE TYPES TO BE COORDINATED DIRECTLY WITH OWNER.

18. ALL EXTERIOR SWITCHES AND WALL PLATES TO BE PROTECTED WITH WEATHERPROOF COVERING.

19. INSTALLATION INSTRUCTIONS FOR ALL LISTED EQUIPMENT SHALL BE PROVIDED TO THE FIELD

INSPECTOR AT TIME OF INSPECTION.
20. ALL PHONE LINES TO BE (2) CATEGORY 5 TWISTED PAIR LINES AND CABLE LINES ARE TO BE HOME

RUN TO BOX IN RESIDENCE.

21. EXTERIOR LIGHT FIXTURES SHALL BE PROTECTED BY A GFCI AND MEET THE FOLLOWING REQUIREMENTS: RECESSED FIXTURES WITH A GLASS OR PLASTIC LENS AND NONMETALLIC OR ELECTRICALLY ISOLATED TRIM, TO BE SUITABLE FOR USE IN DAMP LOCATIONS.

22. ART SPOT LIGHTS SHALL BE RECESSED SQUARE BOXES IN CEILING.

23. A MINIMUM OF 75% OF NEWLY INSTALLED LIGHTING TO BE HIGH EFFICACY.

S. NO	DRG NO.	DESCRIPTION
1	EL.00	LIST OF DRAWINGS & NOTES LEGEND
2	EL.01	BASEMT LEVEL
3	EL.02	MAIN LEVEL
4	EL.03	SECOND LEVEL
5	EL.04	MISCELLANEOUS DETAILS

E	LECTRICAL SYMBOLS	
Þ	110V DUPLEX OUTLET	
₽	220V OUTLET	
Þ	110V DUPLEX OUTLET (ONE OUTLET SWITCH OPERAT	
□ +18	110V DUPLEX OUTLET W GFCI @ 18" AFF (U.N.O.)	
□ wp	110V DUPLEX OUTLET W GFCI & WATERPROOF COVE	
+	GAS OUTLET	
\Q	CEILING MNT. INCANDESCENT FIXTURE	
ф	WALL MNT. INCANDESCENT FIXTURE	
0	RECESSED DOWN LIGHT	
ф	RECESSED WALL WASHER	
\$	SINGLE POLE SWITCH	
\$	DOUBLE POLE SWITCH	
\$	SWITCH DIMMER	
\$	MANUAL ONAUTO-OFF	
FL	FLUORESCENT LIGHT	
H -	UNDER CABINET FLUORESCENT LIGHT	
<u>SD</u>	APPROVED SMOKE DETECTOR	
**	CEILING FAN W LIGHT FIXTURE	
1-#	HOSE BIBB	
RG6 COAX	BROADBAND (CABLE) JACK	
<u>ar</u>	VOICE DATA JACK	
F	EXHAUST FAN	
(EXHAUST FAN W LIGHT FIXTURE- SWITCHED SEPARA	
6 0/S D	APPROVED CARBON MONOXIDE ALARM	
	DOOR OPENER	

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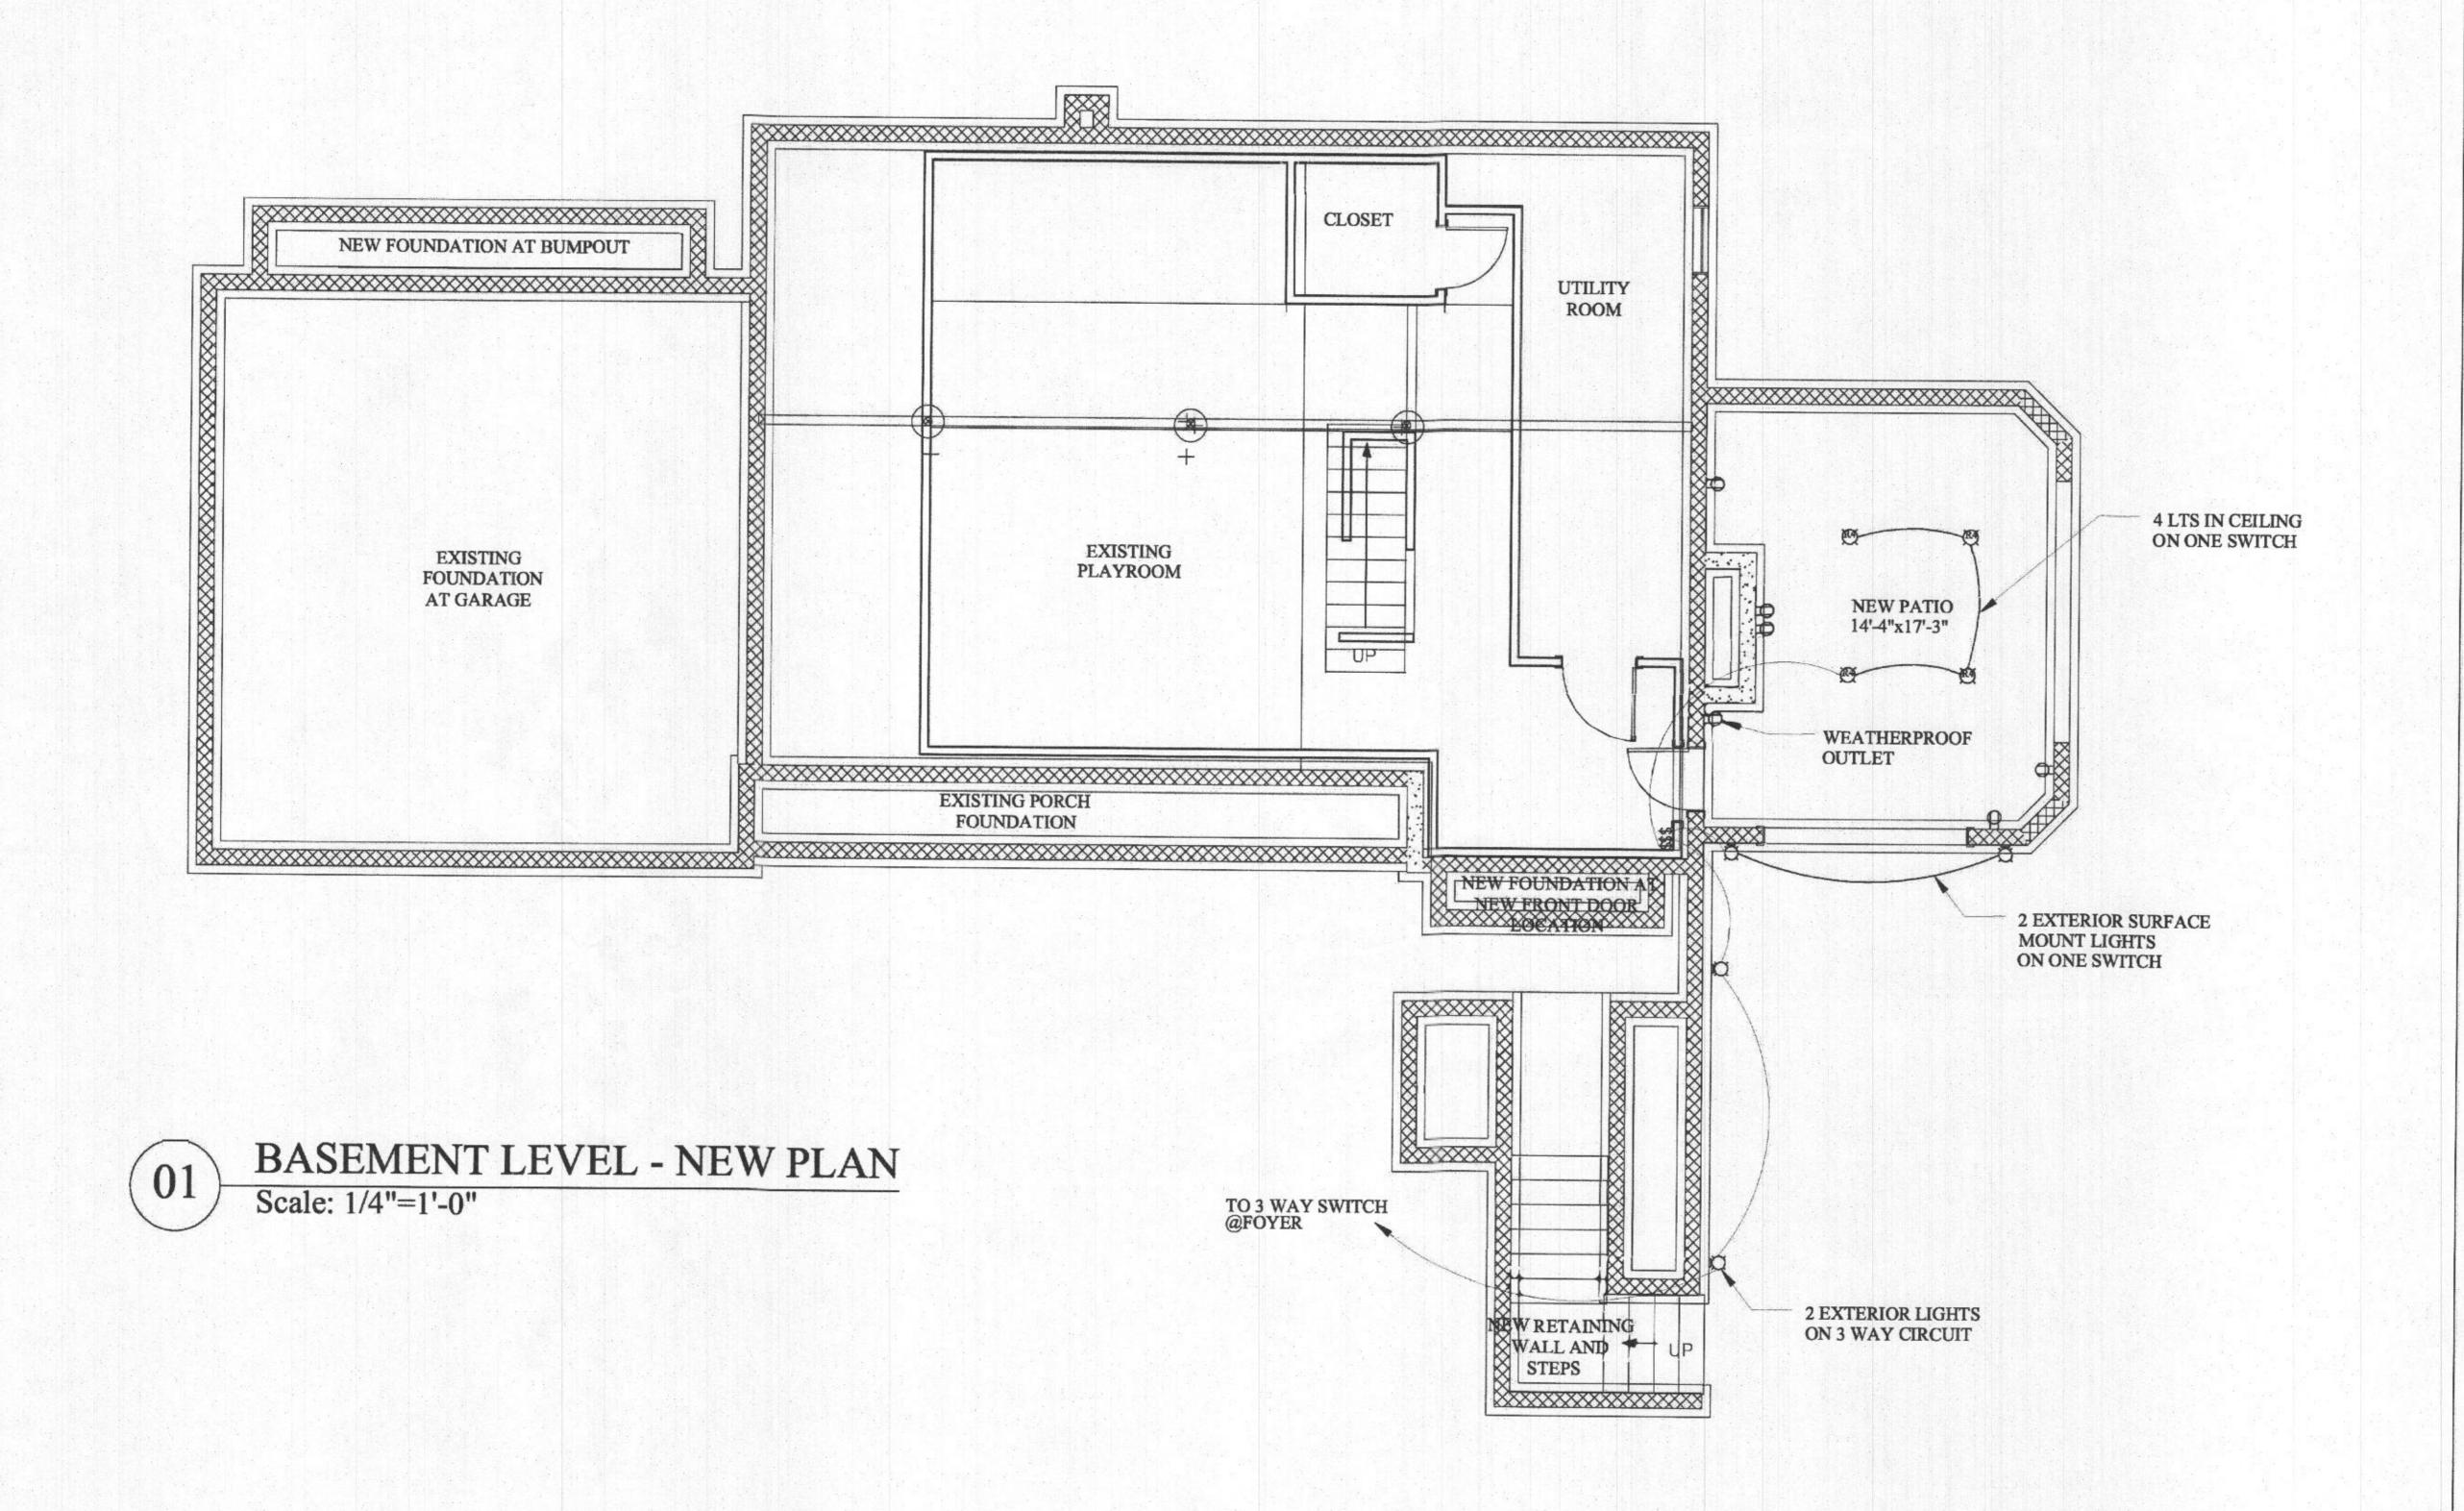
LIST OF
DRAWINGS &
NOTES LEGEND

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SCALE



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RESIDENCE

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Winthorpe Design & Build DRAWING TITLE:

BASEMENT LEVEL

No.	Description	Date

PROJECT NUMBER
DATE


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EL.01

SCALE



O2 MAIN LEVEL - NEW PLAN
Scale: 1/4"=1'-0"

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Winthorpe Design & Build DRAWING TITLE:

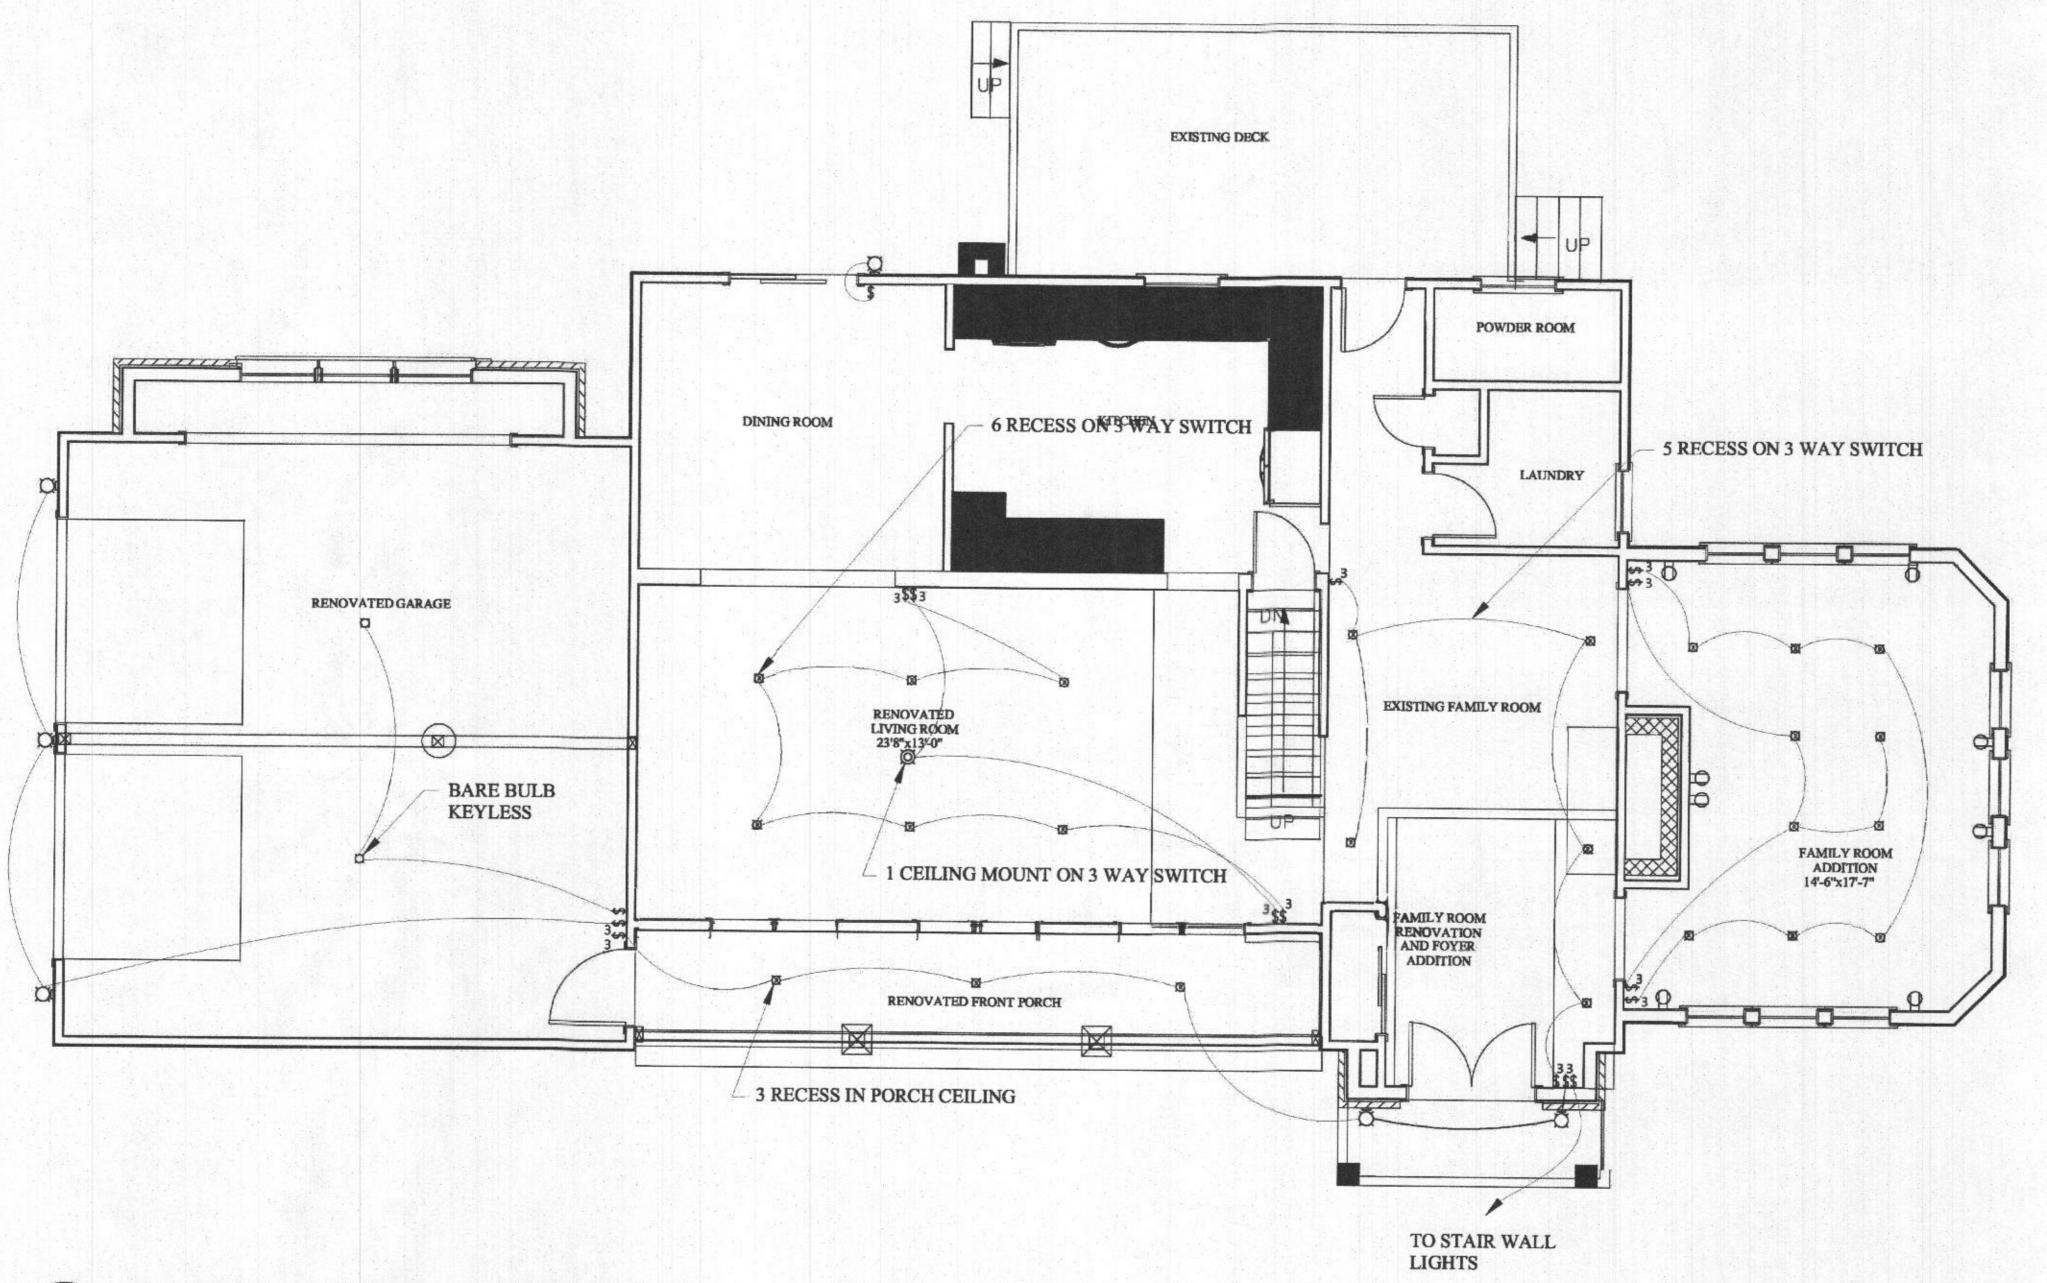MAIN FLOOR LEVEL

No.	Description	Date

PROJECT NUMBER

DATE


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EL.02

SCALE



SECOND LEVEL - NEW PLAN
Scale: 1/4"=1'-0"

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Winthorpe Design & Build DRAWING TITLE:

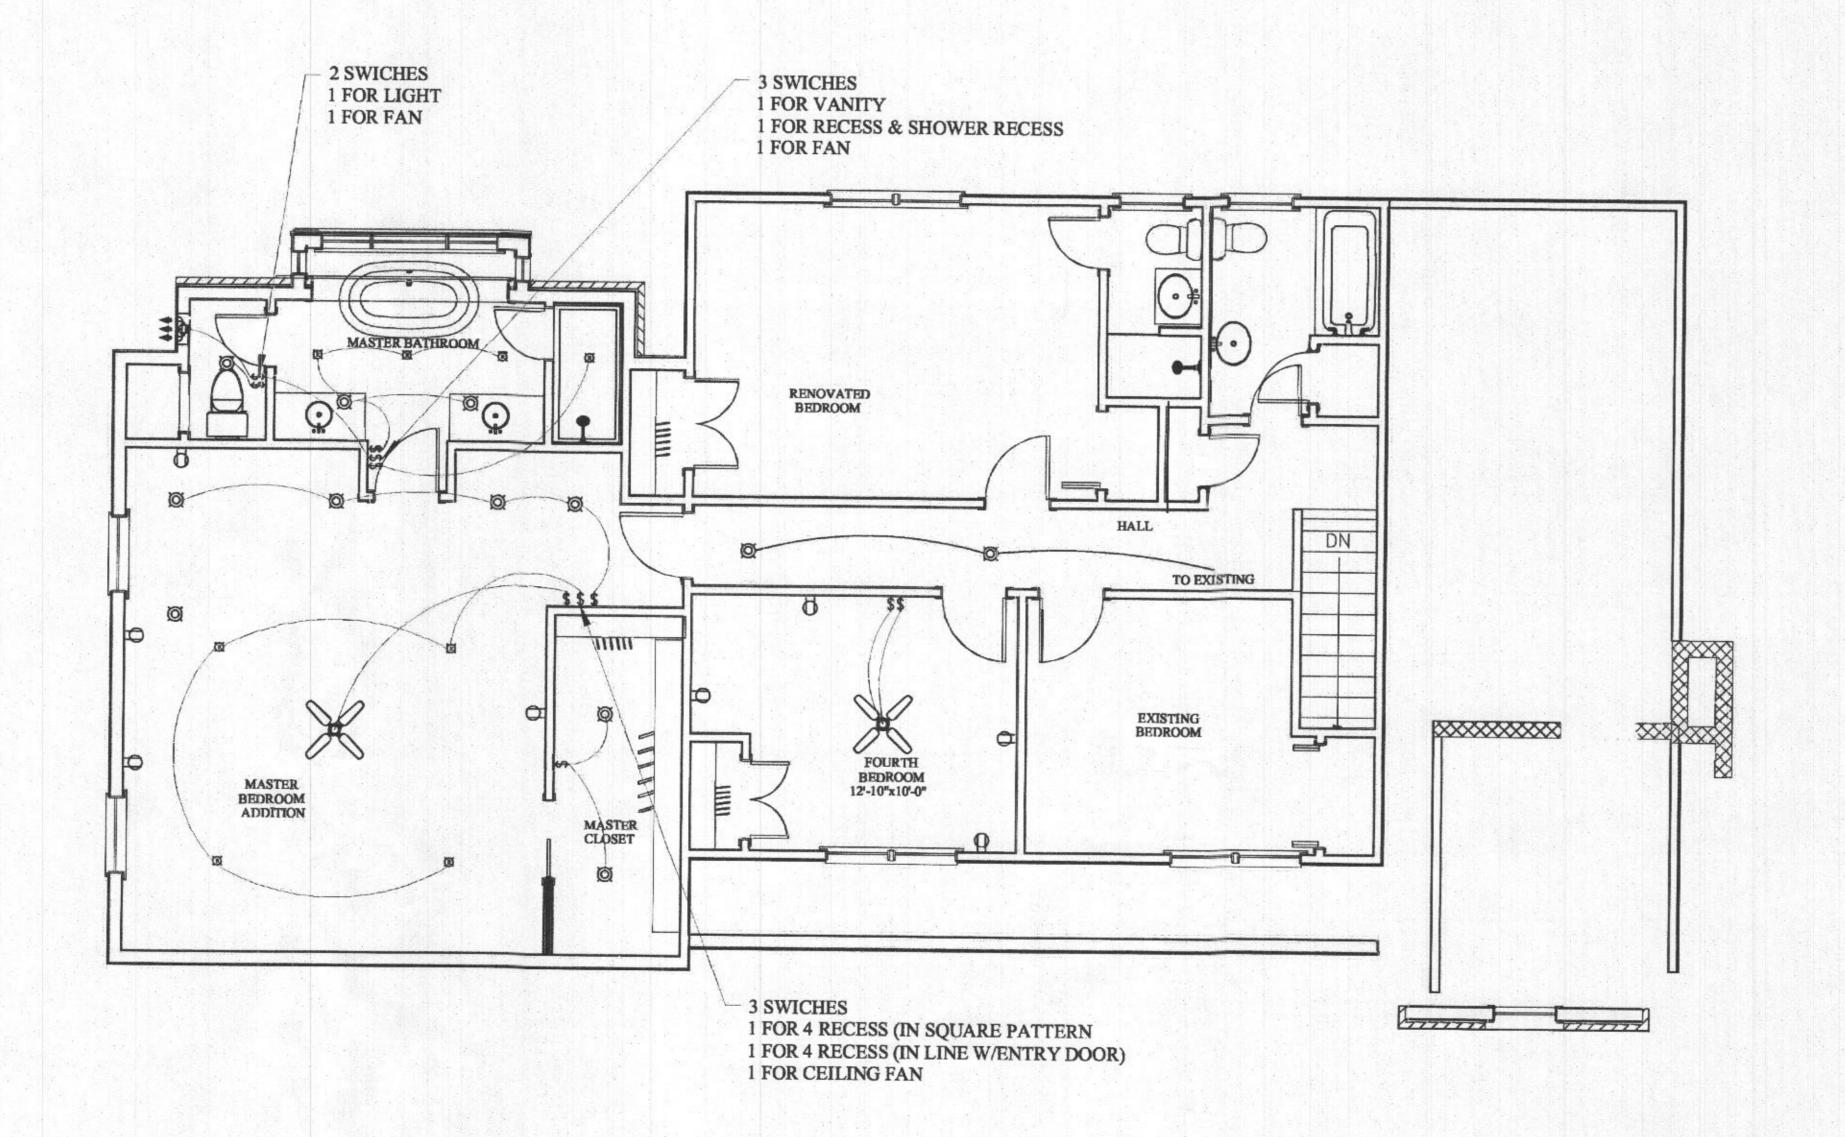SECOND LEVEL

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SCALE