

Building Permit Application

Howard County Maryland

Department of Inspections, Licenses and Permits

3430 Court House Drive

Permits: 410-313-2455

www.howardcountymd.gov

8		30	***			260	
Da	ite	R	eceived:	·	*	 * .	_

Permit No.: B14004103

		<i>j</i> .				
Building Address: 470	6 Ashby Cart	Pro	perty Owner's Name:	165	TT CI	ICP
city: Flight Glys	MD Zin Codo	ZIAUZ Add	dress: U590	Eckano		)CH
1		City	1: Glacia s	tate: (VI)		ode: 1042
Suite/Apt. #	- A A	1 /	one: UTUUCC Z	. 1 5 5 6 4	V V. 4	54.04.40
Census Tract:		/	ail: Morendander	5 6 16	41 XFIN	511X.M
Section:	_ Area: Lot:		olicant's Name & Mailing	Address, (If oth	ner than sta	ated herein)
Tax Map: Pa	rcel: Grid:		olicant's Name: dress:			
Zoning: Map Coo	rdinates: Lot Siz		/:	State!	Zip	Code:
	1		one:	Fax:	· Someonia de la composição de la compos	
Existing Use: VCCAT	10x		ail:		100	
Proposed Use: Reside	and More:	Co	ntractor Company: 1 11	TOIL W		(γ
Estimated Construction Cost: \$		1 1	ntact Person:	Renda	hcs 1	1
Description of Work:		"ah Ad	dress:	11 Ede	LV COZ	> WW
		Cit	y: Chirk 5 State	e: <u>                                     </u>	_Zip Code:	_21/5/
- Sur Buch		Lic	one: 416 484 777	5 Eav.		
<u> </u>	<u>, jr, e</u>			rax	We III	COLOC CM
Occupant or Tenant:			ail: Mandorbe	S C 10	HINON	to Wei Cirl
Was tenant space previously occu	upied? □Yes	No En	gineer/Architect Company:		SE	
Contact Name:	<u> </u>	Re	sponsible Design Prof.:	Mikro	Boy	<u>.</u>
Address:			dress:	1	devo	Dr #730
City:	State: Zip Code		y: Colonbe star		- 1	
		I	one: (10365 U17	-	_	VICTO:
Phone:	Fax:		- 11			
Email:		En	nail: Diboyce	E F2L	F.M.	(01)
Commercial Building Character	istics Residential Building C	haracteristics	Utilities		2.5700	(A) (1) (1) (1) (1) (1) (1) (1) (1) (1) (1
Height:	A SF Dwelling ☐ SF To	wnhouse	Water Supply	,	125 125 125	
No. of stories:	<u>Depth</u>	<u>Width</u>	Public		MARKET !	
Gross area, sq. ft./floor:	1 <sup>st</sup> floor:		Private			
	2 <sup>nd</sup> floor:	H	Sewage Dispose		15 C 15	DEFENDACIONE
Area of construction (sq. ft.):	Basement:		J Public	<u></u>	al crass-risks	
Use group:	Finished Basement	(	1		24 (F. 797)(S	
Use group:	Unfinished Basemen		Private	100	Mr. S. Ores	2. 种类型。对系统数
Construction type:	☐ Slab on Grade		lectric: Yes [	] No	Pink Harris	<b>"别国的"的影响</b>
☐ Reinforced Concrete	No. of Bedrooms:		Gas: 🏟 Yes [	□No	. 本节技术	<b>是我们的基本的</b>
☐ Structural Steel	Multi-family D	Jalling	Heating Systen	2	EN CALE	<b>生产工程和国际政治</b>
☐ Masonry	No. of efficiency units:		☐ Electric ☐ Oil		STAN TH	W. J. Salesia
Wood Frame	No. of 1 BR units:		Natural Gas  Propan	0 G35	TO STATE OF	
State Certified Modular	No. of 2 BR units:		<u> </u>		SACTOR STATE	A THE SHARE SHARE SHARE
23 State Contineativiouslay	No. of 3 BR units:		Other:		10 CH (4050	
***	Other Structure:		Sprinkler System	<u>.                                    </u>		
	Dimensions:	<del></del>    -  <u>-</u>	Yes 🗆 No			
> Roadside Tree Project/Perr			•		1.4	
□Yes ĀNo	Roof:		Grading Per	mit Number:	(TO 1	1000
Roadside Tree Project Permi		ular .			•	
	☐ Manufactured Hom		Building Shell Per	mit Number:		1.
THE UNIDERCICATED HEREBY CERTIFIES AN	ND ACRES AS FOLLOWS, (4) THAT HE IS	IE IS AUTHORIZED TO MAKE	THIS ADDITION (3) THAT THE	SORMATION IS CO	DDD5CT- (2) TI	LAT HE SHE WILL COMPLY
THE UNDERSIGNED HEREBY CERTIFIES AT WITH ALL REGULATIONS OF HOWARD OF	OUNTY WHICH ARE APPLICABLE THERET	O: (4) THAT HE/SHE WILL PER	REFORM NO WORK ON THE ABOVE	REFERENCED PRO	PERTY NOT SE	PECIFICALLY DESCRIBED IN
THIS APPLICATION (S) THAT HE/SHE GRA	NTS COUNTY OFFICIALS THE RIGHT TO E	NTER ONTO THIS PROPERTY F	OR THE PURPOSE OF INSPECTING	THE WORK PERMIT	TED AND POS	TING NOTICES.
T NV		- ·		acci vara	5	100
Applicant's Signature	111	Print No	ame	•	1	
1 prendentar	e CTCHEREMONIA	(CAY)	11/10/14			, , , ,
Email Address	J	Date	1 11	÷	2 20	361
TON ROCK	45 NOCE		* 8	9 " 4	v	
Title/Company		· .				*, **
	Checks Payable	to: DIRECTOR OF FINANCE	E OF HOWARD COUNTY	ii.		
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是是是有主要的是一种的。 第二章		-FOR OFFICE USE	ONLY-			
AGENCY DA	TE SIGNATURE OF APPROVAL	DPZ SETBACK INFO	RMATION	Filing Fee	\$	100
		Front:		Permit Fee		

AGENCY		DATE		SIGNATURE OF APPROVAL					
State Highways					_				
Building Officials		3.75							
PSZA (Zoning)	d .				FU	387			
PSZA ( Engineering )									
Health	17	lia	14	Ц.	250	Lyc			

	All minimum setbacks met?	☐ Yes	. □No
-	Is Entrance Permit Required?	☐ Yes	□No
7	Historic District?	☐ Yes	□No
4	Lot Coverage for New Town Z	one:	
1	SDP/Red-line approval date:	1	7.65
27	" St. 1"		

Rear: Side:

Filing Fee	\$ 100
Permit Fee	\$
Tech Fee	\$
Excise Tax	\$
PSFS	\$
Guaranty Fund	\$ 170
Add'l per Fee	\$
Total Fees	\$
Sub-Total Paid	\$
Balance Due	\$
Check	# MILLE

PROFESSIONAL CERTIFICATION: I HEREBY CERTIFY THAT THESE DOCUMENTS WERE PREPARED BY ME OR UNDER MY RESPONSIBLE CHARGE, AND THAT I AM A DULY LICENSED PROFESSIONAL LAND SURVEYOR UNDER THE LAWS OF THE STATE OF MARYLAND, LICENSE NO. 21328, EXPIRATION DATE 1/8/15. S 82°46'35" 127.42 UTILITY EASEN FAT Z PERC TEST LOCATION 81.90 WELL LOCATION -LOD-LIMITS OF DISTURBANCE SUPER SILT FENCE -SSF-DRAINAGE AREA LIMITS ----- SOIL TYPE LINE DRAIN & UTILITY ACCESS,

STORY FEASEMENT (43,005/ SQ. FT.) GbB GLADSTONE LOAM, 3% TO 8% SLOPES GLADSTONE LOAM, 8% TO 15% SLOPES MANOR LOAM, 15% TO 25% SLOPES MaD DA-1 DRAINAGE AREA 1 TOP OF WALL TW GF GARAGE FLOOR BASEMENT FLOOR BUILDING RESTRICTION LINE STEEP SLOPE AREA 68:14:08" 3/8 LOT ECM PER PLAN 10' PUBLIC TREE AND MAINTENANCE EASMENET PER PLAN F-05-069 WELL TAG NUMBER: HO-94-2468

BUILDING SETBACKS (B.R.L.'s) SHOWN HEREON PER SITE DEVELOPEMENT PLAN SETBACK DISTANCES SHOWN HEREON AS "±" HAVE AN ACCURACY OF ±0.1' FOOT.

HOUSE OPTIONS:

TYPE: HAMPTON (GEORGIAN) WALK-OUT BASEMENT ADD'L 1' TO BASEMENT FOUNDATION WALLS NAPLES SUNROOM ADDITION BRICK SIDES AND REAR

OPTION No. 017

OPTION No. 070

**OPTION No. 529** 

**OPTION No. 673** 

PLOT PLAN LOT 78 HOMEWOOD CROSSING

LIBER 9808, FOLIO 204 PLAT NO. 18241 FIFTH ELECTION DISTRICT HOWARD COUNTY, MARYLAND



Land Planning Engineering Land Surveying

ESE Consultants, Inc. 7164 Columbia Gateway Dr. Columbia, MD 21046 Tel: 410-872-9105 Fax: 410-872-4870

ELLICOTT CITY, MD 21042

ADDRESS: 4706 ASHBY COURT

CHK'D: M.J.B.

SCALE: 1"=40

FILE: PP LOT 78 DRAWN: R.C.K



DATE: 11/03/14

JOB NO: 1214

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316.07 E SWM ACCESS
SEMENT SOIL TYPE LINE (43,005, SQ. FT.) GLADSTONE LOAM, 3% TO 8% SLOPES GLADSTONE LOAM, 8% TO 15% SLOPES MANOR LOAM, 15% TO 25% SLOPES DA-1 DRAINAGE AREA 1 TOP OF WALL TW GARAGE FLOOR GF BASEMENT FLOOR BUILDING RESTRICTION LINE STEEP SLOPE AREA 68:14:08\* .52 ECM PER PLAN 10, PUBLIC TREE AND MAINTENANCE EASMENET PLAN F-05-069

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TYPE: HAMPTON (GEORGIAN)
WALK-OUT BASEMENT
ADD'L 1' TO BASEMENT FOUNDATION WALLS
NAPLES SUNROOM ADDITION
BRICK SIDES AND REAR

OPTION No. 017 OPTION No. 070 OPTION No. 529 OPTION No. 673

#### PLOT PLAN LOT 78 HOMEWOOD CROSSING

LIBER 9808, FOLIO 204
PLAT NO. 18241
FIFTH ELECTION DISTRICT
HOWARD COUNTY, MARYLAND



Land Planning
Engineering
Land Surveying


ESE Consultants, Inc. 7164 Columbia Gateway Dr. Columbia, MD 21046 Tel: 410-872-9105 Fax: 410-872-4870

ELLICOTT CITY, MD 21042

WELL TAG NUMBER: HO-94-2468

ADDRESS: 4706 ASHBY COURT

DATE: 11/03/14 CHK'D: M.J.B. SCALE: 1"=40" JOB NO: 1214 FILE: PP LOT 78
DRAWN: R.C.K

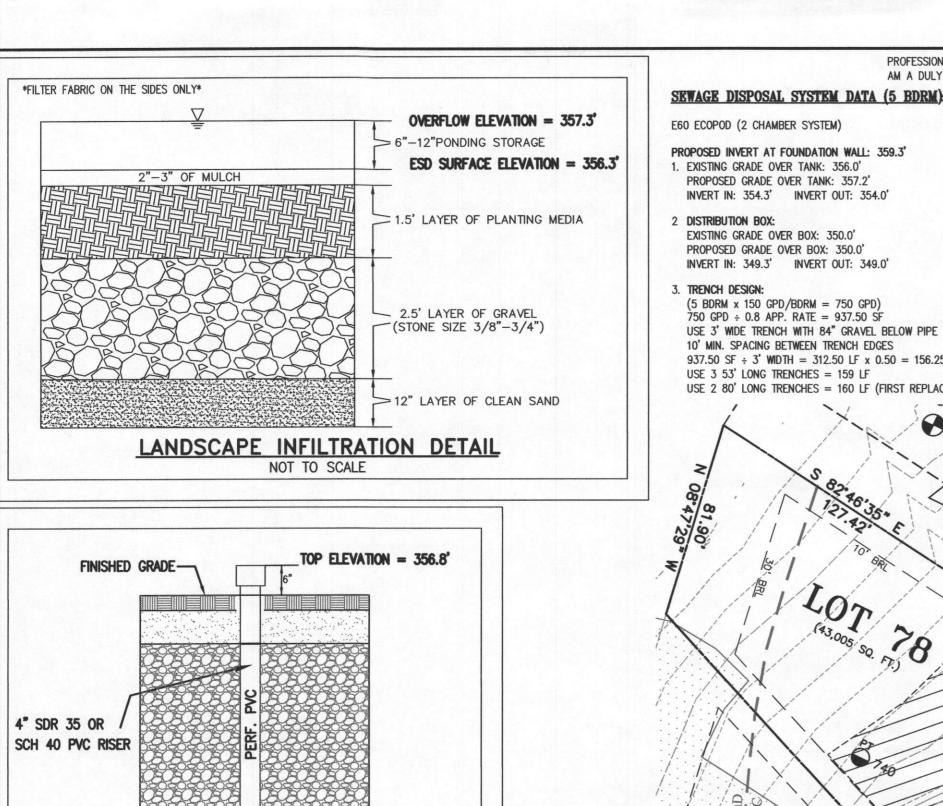

AM A DULY LICENSED PROFESSIONAL LAND SURVEYOR UNDER THE LAWS OF THE STATE OF MARYLAND, LICENSE NO. 21328, EXPIRATION DATE 1/8/17. TRENCH DATA

APP. RATE = 0.8

TRENCH 1 (T1):

TRENCH 2 (T2):

BOTTOM MAX. DEPTH = 8'

INV. IN = 348.8

INV. IN = 346.5

GROUND ABOVE = 349.8'

BOTTOM TRENCH = 341.8'

GROUND ABOVE = 347.5'

BOTTOM TRENCH = 339.5'

E60 ECOPOD (2 CHAMBER SYSTEM)

PROPOSED INVERT AT FOUNDATION WALL: 359.3'

1. EXISTING GRADE OVER TANK: 356.0' PROPOSED GRADE OVER TANK: 357.2' INVERT IN: 354.3' INVERT OUT: 354.0'

2 DISTRIBUTION BOX: EXISTING GRADE OVER BOX: 350.0' PROPOSED GRADE OVER BOX: 350.0'

INVERT IN: 349.3' INVERT OUT: 349.0' 3. TRENCH DESIGN:

 $(5 BDRM \times 150 GPD/BDRM = 750 GPD)$ 750 GPD ÷ 0.8 APP. RATE = 937.50 SF TRENCH 3 (T3): USE 3' WIDE TRENCH WITH 84" GRAVEL BELOW PIPE GROUND ABOVE = 345.8' 10' MIN. SPACING BETWEEN TRENCH EDGES INV. IN = 344.8'937.50 SF  $\div$  3' WIDTH = 312.50 LF x 0.50 = 156.25 LF MIN. TRENCH BOTTOM TRENCH = 337.8' USE 3 53' LONG TRENCHES = 159 LF USE 2 80' LONG TRENCHES = 160 LF (FIRST REPLACEMENT)

EFFECTIVE SIDEWALL = 5'

PROFESSIONAL CERTIFICATION: I HEREBY CERTIFY THAT THESE DOCUMENTS WERE PREPARED BY ME OR UNDER MY RESPONSIBLE CHARGE, AND THAT I

PERC TEST LOCATION WELL LOCATION LIMITS OF DISTURBANCE -SSF- SUPER SILT FENCE DRAINAGE AREA LIMITS

----- SOIL TYPE LINE GbB GLADSTONE LOAM, 3% TO 8% SLOPES GbC GLADSTONE LOAM, 8% TO 15% SLOPES MaD MANOR LOAM, 15% TO 25% SLOPES

R=55.00°

STORMWATER MANAGEMENT

FIFTH ELECTION DISTRICT HOWARD COUNTY, MARYLAND

ADDRESS: 4706 ASHBY COURT

ELLICOTT CITY, MARYLAND


DA-1 DRAINAGE AREA 1 TW TOP OF WALL GARAGE FLOOR BASEMENT FLOOR BUILDING RESTRICTION LINE

STEEP SLOPE AREA

BRICK SIDES AND REAR

TYPE: HAMPTON (GEORGIAN) WALK-OUT BASEMENT ADD'L 1' TO HEIGHT OF BASEMENT WALLS OPTION No. 070 NAPLES SUNROOM ADDITION

OPTION No. 017 **OPTION No. 529** OPTION No. 673

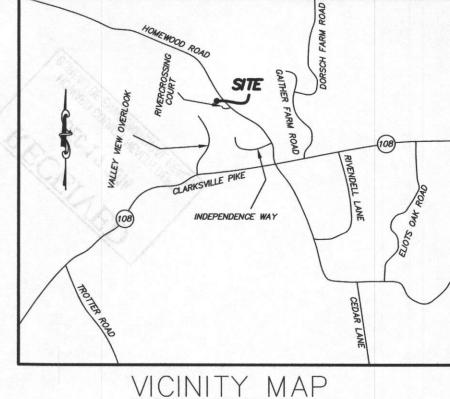

**GENERAL NOTES:** 

1. THE LOT SHOWN HEREON WAS RECORDED ON MAY 2, 2006 AS PLAT NUMBER 18241. REFER TO THIS PLAT FOR DIMENSIONS, LOT AREAS, ALL EASEMENTS AND BUILDING RESTRICTIONS.

2. ZZZZ THIS AREA DESIGNATES A PRIVATE SEWER EASEMENT OF AT LEAST 10,000 SQUARE FEET, AS REQUIRED BY THE STATE DEPARTMENT OF THE ENVIRONMENT FOR INDIVIDUAL SEWAGE DISPOSAL. IMPROVEMENTS OF ANY NATURE IN THIS AREA IS RESTRICTED UNTIL PUBLIC SEWER IS AVAILABLE. THIS EASEMENT SHALL BECOME NULL AND VOID UPON CONNECTION TO A PUBLIC SEWAGE SYSTEM. THE COUNTY HEALTH OFFICER SHALL HAVE THE AUTHORITY TO GRANT ADJUSTMENTS TO THE PRIVATE SEWAGE EASEMENT. ANY CHANGES TO A PRIVATE SEWAGE EASEMENT SHALL REQUIRE A REVISED PERCOLATION CERTIFICATION PLAN. RECORDATION OF A MODIFIED EASEMENT SHALL NOT BE NECESSARY.

3. EXACT LENGTH OF SEPTIC TRENCHES ARE TO BE DETERMINED BY THE HEALTH DEPARTMENT AT THE TIME OF PRE-CONSTRUCTION INSPECTION.

4. SPOIL FROM THE TRENCHING OF THE SEPTIC AREA IS TO BE PLACED ON THE UPHILL SIDE OF THE EXCAVATION FOR EACH INDIVIDUAL LOT.

5. SEDIMENT AND EROSION CONTROLS WERE APPROVED BY HOWARD SOIL CONSERVATION DISTRICT UNDER F-05-069 AND GP-14-034 AND SHALL COMPLY WITH THE 1994 MARYLAND STANDARDS AND SPECIFICATIONS FOR SOIL EROSION AND SEDIMENT CONTROL.

6. STORMWATER MANAGEMENT FOR THIS LOT AS SHOWN.

7. THE EXISTING WELL SHOWN ON THIS PLAN (IDENTIFIED WITH THE ATTACHED WELL TAG NUMBER HO-94-2468 HAS BEEN FIELD LOCATED BY ESE CONSULTANTS - PROFESSIONAL LAND SURVEYOR(S), AND IS ACCURATELY SHOWN.

8. THE EXISTING TOPOGRAPHY WITHIN THE AREA OF PROPOSED WORK IS TAKEN FROM FIELD RUN SURVEY WITH MAXIMUM ONE FOOT CONTOUR INTERVALS PREPARED BY ESE. DATED 5/11/11.

WELL AND SEPTIC NOTES:

TO THE BEST OF MY KNOWLEDGE, INFORMATION AND BELIEF, THE FOLLOWING STATEMENTS ARE TRUE:

ALL EXISTING WELLS, SEPTIC SYSTEMS AND SEWAGE DISPOSAL EASEMENTS WITHIN 100 FEET OF THE PROPERTY BOUNDARIES HAVE BEEN SHOWN. ALL EXISTING AND PROPOSED WELLS THAT ARE LOCATED WITHIN 200 FEET DOWNGRADIENT OF ANY EXISTING OR PROPOSED SEPTIC SYSTEM AND SEWAGE DISPOSAL EASEMENTS HAVE BEEN SHOWN. THE ENGINEER HAS USED ALL EFFORTS TO FIND THE LOCATIONS OF ALL SURROUNDING WELLS AND SEPTIC

2. THE LOT SHOWN HEREON COMPLIES WITH THE MINIMUM OWNERSHIP WIDTHS AND LOT AREA AS REQUIRED BY THE MARYLAND DEPARTMENT OF THE ENVIRONMENT AS SHOWN ON THE RECORD PLAT 18240 GENERAL NOTES ITEM 2.

ANY CHANGES TO A PRIVATE SEWAGE EASEMENT SHALL REQUIRE A REVISED PERCOLATION CERTIFICATION PLAN.

4. THE SOIL TYPE FOR THIS LOT IS GbB, GbC AND MaD, HYDROLIC SOIL GROUP B.

STORMWATER MANAGEMENT CONSTRUCTION AND MAINTENANCE NOTES:

1. FINAL GRADING FOR LANDSCAPE INFILTRATION SHOULD NOT TAKE PLACE UNTIL SURROUNDING SITE IS STABILIZED.

2. SUB SOIL SHALL NOT BE COMPACTED. EXCAVATION SHOULD BE CONDUCTED IN DRY CONDITIONS WITH EQUIPMENT LOCATED OUTSIDE OF THE PRACTICE TO MINIMIZE BOTTOM AND SIDEWALL COMPACTION.

3. SEE APPENDIX B.4 OF THE MARYLAND STORMWATER MANAGEMENT DESIGN MANUAL FOR SAND, GRAVEL AND PLANTING

4. INSPECTION SHALL BE MADE AT THE FOLLOWING STAGES:

(a) DURING EXCAVATION TO SUB-GRADE

(b) DURING PLACEMENT OF BACKFILL AND OBSERVATION WELL

(c) DURING CONSTRUCTION OF APPURTENANT CONVEYANCE STRUCTURES (d) UPON COMPLETION OF FINAL GRADING AND ESTABLISHMENT OF PERMANENT STABILIZATION

PRIVATELY OWNED PRACTICES SHALL HAVE A MAINTENANCE PLAN AND SHALL BE PROTECTED BY EASEMENT, DEED RESTRICTION, ORDINANCE OR OTHER LEGAL MEASURES PREVENTING ITS NEGLECT, ADVERSE ALTERATIONS AND

6. DURING FIRST YEAR OF OPERATION, INSPECTION FREQUENCY SHOULD BE AFTER EVERY MAJOR STORM AND POORLY ESTABLISHED AREAS RE-VEGETATED.

THE TOP FEW INCHES OF THE PLANTING SOIL SHOULD BE REMOVED AND REPLACED WHEN WATER PONDS FOR MORE THAN 48 HOURS OR THERE IS ALGAE GROWTH ON THE SURFACE OF THE FACILITY.

IF STANDING WATER PERSISTS AFTER FILTER MEDIA HAS BEEN MAINTAINED, THE GRAVEL, SOIL AND SAND MAY NEED TO BE CLEANED AND/OR REPLACED.

9. OCCASIONAL PRUNING AND REPLACEMENT OF DEAD VEGETATION IS NECESSARY. IF SPECIFIC PLANTS ARE NOT SURVIVING, MORE APPROPRIATE SPECIES SHOULD BE USED. WATERING MAY BE REQUIRED DURING PROLONGED DRY

## **ESD SPECIFICATIONS:**

LANDSCAPE INFILTRATION DESIGN (LESS THAN 10,000 SQ. FT) DRAINAGE AREA = 7,679 SQ. FT. PROPOSED IMPERVIOUS AREA = 4,700 SQ. FT. SURFACE AREA = 384 SQ. FT. TOTAL STORAGE AREA = 384 CF

(Pe) x (Rv) x (A) ÷ 12 (1)  $\times$  (0.599)  $\times$  (7679)  $\div$  12 = 4,599.72  $\div$  12 = 383.31 CF. PLANTING SCHEDULE:

4" CAP W/ 1" HOLE DRILLED IN IT

HOUSE/ROOFTOP (IMPERVIOUS) = 3,651 SQ. FT (0.0838 ACRES)

DRIVEWAY (IMPERVIOUS) = 513 SQ. FT (0.0118 ACRES) GRASS (PERVIOUS) = 2,979 SQ. FT. (0.0684 ACRES)

DRAINAGE AREA NO. 3 (NON-ROOFTOP DISCONNECT):

DRIVEWAY (IMPERVIOUS) = 536 SQ. FT (0.0123 ACRES)

TOTAL CALCULATIONS OF DRAINAGE AREAS COMBINED:

ESD CALCULATIONS:

**ESDv** 

**PLANTS** 

TREES

1.0" (RAINFALL TARGET)

TOTAL OF DA-1 TO BE TREATED = 3,651 SQ. FT. (0.0838 ACRES)

TOTAL OF DA-2 TO BE TREATED = 3,492 SQ. FT. (0.0802 ACRES)

TOTAL OF DA-3 TO BE TREATED = 536 SQ. FT. (0.0123 ACRES)

TOTAL AREA TO BE TREATED = 7,679 SQ. FT. (0.1763 ACRES)

 $(0.1079 \div 0.1763) = 0.6120 = 61\%$ 

RUNOFF VOLUME (IN ACRES-FEET)

MINIMUM NUMBER

 $(Pe \times Rv) = (1 \times 0.599) = 0.599 \text{ INCHES}$ 

TOTAL IMPERVIOUS AREA TO BE TREATED = 4,700 SQ. FT. (0.1079 ACRES)

(TOTAL DRAINAGE AREA) = 7,679 SQ. FT. (0.1763 ACRES)

(THE DIMENSIONLESS VOLUMETRIC RUNOFF COEFFICIENT)

(RUNOFF DEPTH IN INCHES THAT MUST BE TREATED)

 $0.05 + (0.009 \times (1)) = 0.05 + (0.009 \times (61\%)) = 0.599$ 

(IMPERVIOUS AREA) = (IMPERVIOUS AREA : DRAINAGE AREA)

TOTAL PERVIOUS AREA TO BE TREATED = 2,979 SQ. FT. (0.0684 ACRES)

DRAINAGE AREA NO. 1:

DRAINAGE AREA NO. 2:

(DRIVEWAY AND GRASS)

OBSERVATION WELL DETAIL

TYPE SPECIES TO BE DETERMINED BY LANDSCAPE CONTRACTOR CHOSEN FROM THE APPROVED SPECIES LIST AS DESCRIBED IN MDE MANUAL APPENDIX A.

SHRUBS / BUSHES

CHIEF. DEVELOPMENT ENGINEERING DIVISION DATE DIRECTOR DATE DATE PROFESSIONAL ENGINEER

APPROVED: FOR HOWARD COUNTY DEPARTMENT OF PLANNING & ZONING

LANDSCAPE INFILTRATION DESIGN LOT 78 Land Planning HOMEWOOD CROSSING LIBER 9808, FOLIO 204 PLAT No. 18241 TAX No. 05-443431

Engineering Land Surveying


Columbia, MD 21046 TEL: 410-872-9105 FAX: 410-872-4870

**ESE Consultants Inc.** 

7164 Columbia Gateway Dr.

Suite 203

DATE: 12/17/14 SCALE: 1"=40' FILE: SWM LOT 78\_rev1 CHK'D: M.J.B. JOB NO: 1214 DRAWN: R.C.K.

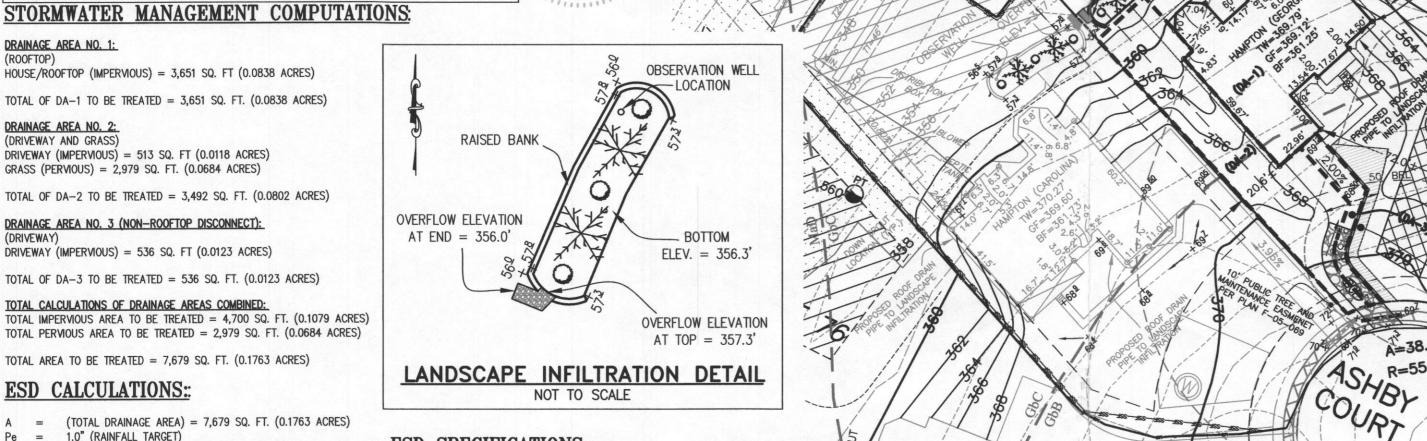

STORAGE AREA = (SURFACE AREA x DEPTH) (384 x 1) = 384 CF

\*ESD TO THE MEP IS MET

SPECIES TO BE DETERMINED BY LANDSCAPE CONTRACTOR, CHOSEN FROM APPROVED SPECIES LIST

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INV. IN = 346.5

GROUND ABOVE = 349.8'

BOTTOM TRENCH = 341.8'

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#### SEWAGE DISPOSAL SYSTEM DATA (5 BDRM)

E60 ECOPOD (2 CHAMBER SYSTEM)

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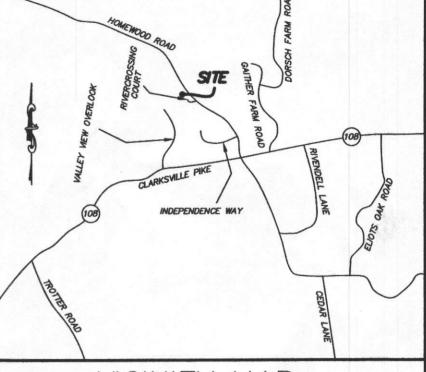
BROSSESSES DRAINAGE AREA LIMITS ----- SOIL TYPE LINE Gbb Gladstone Loam, 3% to 8% slopes GbC GLADSTONE LOAM, 8% TO 15% SLOPES

MaD MANOR LOAM, 15% TO 25% SLOPES DA-1 DRAINAGE AREA 1 TW TOP OF WALL GF GARAGE FLOOR

BASEMENT FLOOR BRL BUILDING RESTRICTION LINE STEEP SLOPE AREA

#### HOUSE OPTIONS:

TYPE: HAMPTON (GEORGIAN) WALK-OUT BASEMENT OPTION No. 017 ADD'L 1' TO HEIGHT OF BASEMENT WALLS OPTION No. 070 OPTION No. 529 NAPLES SUNROOM ADDITION BRICK SIDES AND REAR OPTION No. 673



## VICINITY MAP

#### 1. THE LOT SHOWN HEREON WAS RECORDED ON MAY 2, 2006 AS PLAT NUMBER 18241. REFER TO THIS PLAT FOR DIMENSIONS, LOT AREAS, ALL EASEMENTS AND BUILDING RESTRICTIONS.

2. ZZZZ THIS AREA DESIGNATES A PRIVATE SEWER EASEMENT OF AT LEAST 10,000 SQUARE FEET. AS REQUIRED BY THE STATE DEPARTMENT OF THE ENVIRONMENT FOR INDIVIDUAL SEWAGE DISPOSAL. IMPROVEMENTS OF ANY NATURE IN THIS AREA IS RESTRICTED UNTIL PUBLIC SEWER IS AVAILABLE. THIS EASEMENT SHALL BECOME NULL AND VOID UPON CONNECTION TO A PUBLIC SEWAGE SYSTEM. THE COUNTY HEALTH OFFICER SHALL HAVE THE AUTHORITY TO GRANT ADJUSTMENTS TO THE PRIVATE SEWAGE EASEMENT. ANY CHANGES TO A PRIVATE SEWAGE EASEMENT SHALL REQUIRE A REVISED PERCOLATION CERTIFICATION PLAN. RECORDATION OF A MODIFIED EASEMENT SHALL NOT BE NECESSARY.

3. EXACT LENGTH OF SEPTIC TRENCHES ARE TO BE DETERMINED BY THE HEALTH DEPARTMENT AT THE TIME OF PRE-CONSTRUCTION INSPECTION.

4. SPOIL FROM THE TRENCHING OF THE SEPTIC AREA IS TO BE PLACED ON THE UPHILL SIDE OF THE EXCAVATION FOR EACH INDIVIDUAL LOT.

5. SEDIMENT AND EROSION CONTROLS WERE APPROVED BY HOWARD SOIL CONSERVATION DISTRICT UNDER F-05-069 AND GP-14-034 AND SHALL COMPLY WITH THE 1994 MARYLAND STANDARDS AND SPECIFICATIONS FOR SOIL EROSION AND

6. STORMWATER MANAGEMENT FOR THIS LOT AS SHOWN.

7. THE EXISTING WELL SHOWN ON THIS PLAN (IDENTIFIED WITH THE ATTACHED WELL TAG NUMBER HO-94-2468 HAS BEEN FIELD LOCATED BY ESE CONSULTANTS - PROFESSIONAL LAND SURVEYOR(S), AND IS ACCURATELY SHOWN.

8. THE EXISTING TOPOGRAPHY WITHIN THE AREA OF PROPOSED WORK IS TAKEN FROM FIELD RUN SURVEY WITH MAXIMUM ONE FOOT CONTOUR INTERVALS PREPARED BY ESE. DATED 5/11/11.

#### WELL AND SEPTIC NOTES:

**GENERAL NOTES:** 

TO THE BEST OF MY KNOWLEDGE, INFORMATION AND BELIEF, THE FOLLOWING STATEMENTS ARE TRUE:

1. ALL EXISTING WELLS, SEPTIC SYSTEMS AND SEWAGE DISPOSAL EASEMENTS WITHIN 100 FEET OF THE PROPERTY BOUNDARIES HAVE BEEN SHOWN. ALL EXISTING AND PROPOSED WELLS THAT ARE LOCATED WITHIN 200 FEET DOWNGRADIENT OF ANY EXISTING OR PROPOSED SEPTIC SYSTEM AND SEWAGE DISPOSAL EASEMENTS HAVE BEEN SHOWN. THE ENGINEER HAS USED ALL EFFORTS TO FIND THE LOCATIONS OF ALL SURROUNDING WELLS AND SEPTIC

2. THE LOT SHOWN HEREON COMPLIES WITH THE MINIMUM OWNERSHIP WIDTHS AND LOT AREA AS REQUIRED BY THE MARYLAND DEPARTMENT OF THE ENVIRONMENT AS SHOWN ON THE RECORD PLAT 18240 GENERAL NOTES ITEM 2.

3. ANY CHANGES TO A PRIVATE SEWAGE EASEMENT SHALL REQUIRE A REVISED PERCOLATION CERTIFICATION PLAN.

4. THE SOIL TYPE FOR THIS LOT IS GOB, GOC AND Mad, HYDROLIC SOIL GROUP B

#### STORMWATER MANAGEMENT CONSTRUCTION AND MAINTENANCE NOTES:

1. FINAL GRADING FOR LANDSCAPE INFILTRATION SHOULD NOT TAKE PLACE UNTIL SURROUNDING SITE IS STABILIZED.

2. SUB SOIL SHALL NOT BE COMPACTED. EXCAVATION SHOULD BE CONDUCTED IN DRY CONDITIONS WITH EQUIPMENT LOCATED OUTSIDE OF THE PRACTICE TO MINIMIZE BOTTOM AND SIDEWALL COMPACTION.

3. SEE APPENDIX B.4 OF THE MARYLAND STORMWATER MANAGEMENT DESIGN MANUAL FOR SAND, GRAVEL AND PLANTING

4. INSPECTION SHALL BE MADE AT THE FOLLOWING STAGES:

(a) DURING EXCAVATION TO SUB-GRADE

(b) DURING PLACEMENT OF BACKFILL AND OBSERVATION WELL

(c) DURING CONSTRUCTION OF APPURTENANT CONVEYANCE STRUCTURES (d) UPON COMPLETION OF FINAL GRADING AND ESTABLISHMENT OF PERMANENT STABILIZATION

PRIVATELY OWNED PRACTICES SHALL HAVE A MAINTENANCE PLAN AND SHALL BE PROTECTED BY EASEMENT, DEED RESTRICTION, ORDINANCE OR OTHER LEGAL MEASURES PREVENTING ITS NEGLECT, ADVERSE ALTERATIONS AND

6. DURING FIRST YEAR OF OPERATION, INSPECTION FREQUENCY SHOULD BE AFTER EVERY MAJOR STORM AND POORLY ESTABLISHED AREAS RE-VEGETATED.

THE TOP FEW INCHES OF THE PLANTING SOIL SHOULD BE REMOVED AND REPLACED WHEN WATER PONDS FOR MORE THAN 48 HOURS OR THERE IS ALGAE GROWTH ON THE SURFACE OF THE FACILITY.

8. IF STANDING WATER PERSISTS AFTER FILTER MEDIA HAS BEEN MAINTAINED, THE GRAVEL, SOIL AND SAND MAY NEED TO BE CLEANED AND/OR REPLACED.

9. OCCASIONAL PRUNING AND REPLACEMENT OF DEAD VEGETATION IS NECESSARY. IF SPECIFIC PLANTS ARE NOT SURVIVING, MORE APPROPRIATE SPECIES SHOULD BE USED. WATERING MAY BE REQUIRED DURING PROLONGED DRY

PERIODS


and Planning Engineering and Surveying 7164 Columbia Gateway Dr. Suite 203 Columbia, MD 21046 TEL: 410-872-9105 FAX: 410-872-4870

**ESE** Consultants Inc.

DATE: 12/17/14 CHK'D: M.J.B.

JOB NO: 1214

FILE: SWM LOT 78\_revi SCALE: 1"=40" DRAWN: R.C.K.

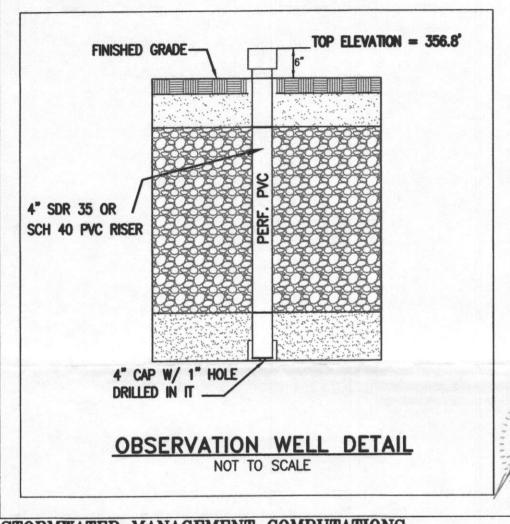

## STORMWATER MANAGEMENT COMPUTATIONS:

#### DRAINAGE AREA NO. 1:

HOUSE/ROOFTOP (IMPERVIOUS) = 3,651 SQ. FT (0.0838 ACRES)

TOTAL OF DA-1 TO BE TREATED = 3,651 SQ. FT. (0.0838 ACRES)

#### DRAINAGE AREA NO. 2: (DRIVEWAY AND GRASS)

= 513 SQ. FT (0.0118 ACRES) DRIVEWAY (IMPERVIOUS)

GRASS (PERVIOUS) = 2,979 SQ. FT. (0.0684 ACRES) TOTAL OF DA-2 TO BE TREATED = 3,492 SQ. FT. (0.0802 ACRES)

#### DRAINAGE AREA NO. 3 (NON-ROOFTOP DISCONNECT):

(DRIVEWAY) DRIVEWAY (IMPERVIOUS) = 536 SQ. FT (0.0123 ACRES)

TOTAL OF DA-3 TO BE TREATED = 536 SQ. FT. (0.0123 ACRES)

#### TOTAL CALCULATIONS OF DRAINAGE AREAS COMBINED:

TOTAL IMPERVIOUS AREA TO BE TREATED = 4,700 SQ. FT. (0.1079 ACRES) TOTAL PERVIOUS AREA TO BE TREATED = 2,979 SQ. FT. (0.0684 ACRES)

TOTAL AREA TO BE TREATED = 7,679 SQ. FT. (0.1763 ACRES)

#### ESD CALCULATIONS:

(TOTAL DRAINAGE AREA) = 7,679 SQ. FT. (0.1763 ACRES) 1.0" (RAINFALL TARGET)

(IMPERVIOUS AREA) = (IMPERVIOUS AREA : DRAINAGE AREA)  $(0.1079 \div 0.1763) = 0.6120 = 61\%$ (THE DIMENSIONLESS VOLUMETRIC RUNOFF COEFFICIENT)

 $0.05 + (0.009 \times (1)) = 0.05 + (0.009 \times (61\%)) = 0.599$ (RUNOFF DEPTH IN INCHES THAT MUST BE TREATED)

 $(Pe \times Rv) = (1 \times 0.599) = 0.599 \text{ INCHES}$ RUNOFF VOLUME (IN ACRES-FEET)

(Pe) x (Rv) x (A) ÷ 12 (1)  $\times$  (0.599)  $\times$  (7679)  $\div$  12 = 4,599.72  $\div$  12 = 383.31 CF.

# PLANTING SCHEDULE:

MINIMUM NUMBER **PLANTS** 

TREES

TYPE

SPECIES TO BE DETERMINED BY LANDSCAPE CONTRACTOR CHOSEN FROM THE APPROVED

SPECIES TO BE DETERMINED BY LANDSCAPE CONTRACTOR, CHOSEN FROM APPROVED SPECIES LIST SHRUBS / BUSHES

OBSERVATION WELL -LOCATION RAISED BANK OVERFLOW ELEVATION - BOTTOM AT END = 356.0'ELEV. = 356.3OVERFLOW ELEVATION AT TOP = 357.3'

LANDSCAPE INFILTRATION DETAIL NOT TO SCALE

## **ESD SPECIFICATIONS:**

LANDSCAPE INFILTRATION DESIGN (LESS THAN 10,000 SQ. FT) DRAINAGE AREA = 7,679 SQ. FT. PROPOSED IMPERVIOUS AREA = 4,700 SQ. FT. SURFACE AREA = 384 SQ. FT. STORAGE AREA = (SURFACE AREA x DEPTH) (384 x 1) = 384 CF TOTAL STORAGE AREA = 384 CF

#### \*ESD TO THE MEP IS MET

SPECIES LIST AS DESCRIBED IN MDE MANUAL APPENDIX A.

DATE CHIEF, DEVELOPMENT ENGINEERING DIVISION DATE DIRECTOR

PROFESSIONAL ENGINEER

APPROVED: FOR HOWARD COUNTY DEPARTMENT OF PLANNING & ZONING

HOWARD COUNTY, MARYLAND ADDRESS: 4706 ASHBY COURT

R=55.00°

ASHBY

LANDSCAPE INFILTRATION DESIGN HOMEWOOD CROSSING

DATE

LIBER 9808, FOLIO 204 PLAT No. 18241 TAX No. 05-443431 FIFTH ELECTION DISTRICT

ELLICOTT CITY, MARYLAND

STORMWATER MANAGEMENT

LOT 78

TOP ELEVATION = 356.8

# SEWAGE DISPOSAL SYSTEM DATA (5 BDRM):

E60 ECOPOD (2 CHAMBER SYSTEM)

PROPOSED INVERT AT FOUNDATION WALL: XXX.X' 1. EXISTING GRADE OVER TANK: XXX.X' PROPOSED GRADE OVER TANK: XXX.X' INVERT IN: XXX.X' INVERT OUT: XXX.X'

2 DISTRIBUTION BOX: EXISTING GRADE OVER BOX: XXX.X' PROPOSED GRADE OVER BOX: XXX.X' INVERT IN: XXX.X' INVERT OUT: XXX.X'

USE 3 53' LONG TRENCHES = 159 LF

3. TRENCH DESIGN:  $(5 BDRM \times 150 GPD/BDRM = 750 GPD)$ 750 GPD ÷ 0.8 APP. RATE = 937.50 SF USE 3' WIDE TRENCH WITH 84" GRAVEL BELOW PIPE 10' MIN. SPACING BETWEEN TRENCH EDGES 937.50 SF ÷ 3' WIDTH = 312.50 LF x 0.50 = 156.25 LF MIN. TRENCH

TRENCH DATA:

APP. RATE = 0.8

TRENCH 1 (T1):

TRENCH 2 (T2):

TRENCH 3 (T3):

EFFECTIVE SIDEWALL = 5'

INV. IN = 348.8'

INV. IN = 346.5'

INV. IN = 344.8'

BOTTOM MAX. DEPTH = 8'

GROUND ABOVE = 349.8'

BOTTOM TRENCH = 341.8'

GROUND ABOVE = 347.5'

BOTTOM TRENCH = 339.5'

GROUND ABOVE = 345.8'

BOTTOM TRENCH = 337.8'

PROFESSIONAL CERTIFICATION: I HEREBY CERTIFY THAT THESE DOCUMENTS WERE PREPARED BY ME OR UNDER MY RESPONSIBLE CHARGE, AND THAT AM A DULY LICENSED PROFESSIONAL LAND SURVEYOR UNDER THE LAWS OF THE STATE OF MARYLAND, LICENSE NO. 21328, EXPIRATION DATE 1/8/15.

> PERC TEST LOCATION WELL LOCATION LIMITS OF DISTURBANCE

-LOD--SSF- SUPER SILT FENCE DRAINAGE AREA LIMITS

----- SOIL TYPE LINE GbB GLADSTONE LOAM, 3% TO 8% SLOPES GbC GLADSTONE LOAM, 8% TO 15% SLOPES MaD MANOR LOAM, 15% TO 25% SLOPES

DA-1 DRAINAGE AREA 1 TW TOP OF WALL GARAGE FLOOR BASEMENT FLOOR


BRL BUILDING RESTRICTION LINE STEEP SLOPE AREA

**HOUSE OPTIONS:** 

BRICK SIDES AND REAR

TYPE: HAMPTON (GEORGIAN)
WALK-OUT BASEMENT ADD'L 1' TO HEIGHT OF BASEMENT WALLS OPTION No. 070 NAPLES SUNROOM ADDITION

OPTION No. 017 OPTION No. 529 OPTION No. 673

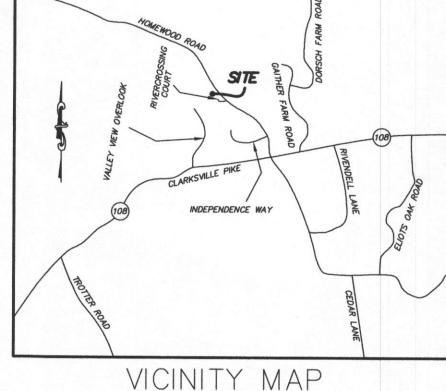

#### GENERAL NOTES:

1. THE LOT SHOWN HEREON WAS RECORDED ON MAY 2, 2006 AS PLAT NUMBER 18241. REFER TO THIS PLAT FOR DIMENSIONS, LOT AREAS, ALL EASEMENTS AND BUILDING RESTRICTIONS.

2. ZZZZ THIS AREA DESIGNATES A PRIVATE SEWER EASEMENT OF AT LEAST 10,000 SQUARE FEET. AS REQUIRED BY THE STATE DEPARTMENT OF THE ENVIRONMENT FOR INDIVIDUAL SEWAGE DISPOSAL. IMPROVEMENTS OF ANY NATURE IN THIS AREA IS RESTRICTED UNTIL PUBLIC SEWER IS AVAILABLE. THIS EASEMENT SHALL BECOME NULL AND VOID UPON CONNECTION TO A PUBLIC SEWAGE SYSTEM. THE COUNTY HEALTH OFFICER SHALL HAVE THE AUTHORITY TO GRANT ADJUSTMENTS TO THE PRIVATE SEWAGE EASEMENT. ANY CHANGES TO A PRIVATE SEWAGE EASEMENT SHALL REQUIRE A REVISED PERCOLATION CERTIFICATION PLAN. RECORDATION OF A MODIFIED EASEMENT SHALL NOT BE NECESSARY.

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4. SPOIL FROM THE TRENCHING OF THE SEPTIC AREA IS TO BE PLACED ON THE UPHILL SIDE OF THE EXCAVATION FOR

5. SEDIMENT AND EROSION CONTROLS WERE APPROVED BY HOWARD SOIL CONSERVATION DISTRICT UNDER F-05-069 AND GP-14-034 AND SHALL COMPLY WITH THE 1994 MARYLAND STANDARDS AND SPECIFICATIONS FOR SOIL EROSION AND

6. STORMWATER MANAGEMENT FOR THIS LOT AS SHOWN.

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2. THE LOT SHOWN HEREON COMPLIES WITH THE MINIMUM OWNERSHIP WIDTHS AND LOT AREA AS REQUIRED BY THE MARYLAND DEPARTMENT OF THE ENVIRONMENT AS SHOWN ON THE RECORD PLAT 18240 GENERAL NOTES ITEM 2.

3. ANY CHANGES TO A PRIVATE SEWAGE EASEMENT SHALL REQUIRE A REVISED PERCOLATION CERTIFICATION PLAN.

4. THE SOIL TYPE FOR THIS LOT IS GBB, GBC AND MaD, HYDROLIC SOIL GROUP B.

#### STORMWATER MANAGEMENT CONSTRUCTION AND MAINTENANCE NOTES:

FINAL GRADING FOR LANDSCAPE INFILTRATION SHOULD NOT TAKE PLACE UNTIL SURROUNDING SITE IS STABILIZED.

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3. SEE APPENDIX B.4 OF THE MARYLAND STORMWATER MANAGEMENT DESIGN MANUAL FOR SAND, GRAVEL AND PLANTING

4. INSPECTION SHALL BE MADE AT THE FOLLOWING STAGES:

(a) DURING EXCAVATION TO SUB-GRADE

(b) DURING PLACEMENT OF BACKFILL AND OBSERVATION WELL

(c) DURING CONSTRUCTION OF APPURTENANT CONVEYANCE STRUCTURES (d) UPON COMPLETION OF FINAL GRADING AND ESTABLISHMENT OF PERMANENT STABILIZATION

PRIVATELY OWNED PRACTICES SHALL HAVE A MAINTENANCE PLAN AND SHALL BE PROTECTED BY EASEMENT, DEED RESTRICTION. ORDINANCE OR OTHER LEGAL MEASURES PREVENTING ITS NEGLECT, ADVERSE ALTERATIONS AND


6. DURING FIRST YEAR OF OPERATION, INSPECTION FREQUENCY SHOULD BE AFTER EVERY MAJOR STORM AND POORLY ESTABLISHED AREAS RE-VEGETATED.

THE TOP FEW INCHES OF THE PLANTING SOIL SHOULD BE REMOVED AND REPLACED WHEN WATER PONDS FOR MORE THAN 48 HOURS OR THERE IS ALGAE GROWTH ON THE SURFACE OF THE FACILITY.

8. IF STANDING WATER PERSISTS AFTER FILTER MEDIA HAS BEEN MAINTAINED, THE GRAVEL, SOIL AND SAND MAY NEED

TO BE CLEANED AND/OR REPLACED.

9. OCCASIONAL PRUNING AND REPLACEMENT OF DEAD VEGETATION IS NECESSARY. IF SPECIFIC PLANTS ARE NOT SURVIVING, MORE APPROPRIATE SPECIES SHOULD BE USED. WATERING MAY BE REQUIRED DURING PROLONGED DRY

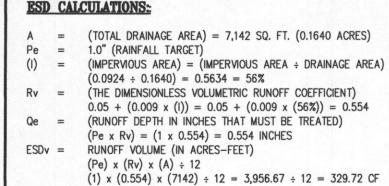

DRAINAGE AREA NO. 1

(DRIVEWAY AND ROOFTOP)

LANDSCAPE INFILTRATION DESIGN (LESS THAN 10,000 SQ. FT) DRAINAGE AREA = 7,142 SQ. FT.

FINISHED GRADE-

4" CAP W/ 1" HOLE

STORMWATER MANAGEMENT COMPUTATIONS

DRIVEWAY (IMPERVIOUS) = 372 SQ. FT (0.0085 ACRES) GRASS (NON-IMPERVIOUS) = 3,119 SQ. FT. (0.0716 ACRES)

TOTAL PERVIOUS AREA TO BE TREATED = 3,119 SQ. FT. (0.0716 ACRES)

TOTAL AREA TO BE TREATED = 7,142 SQ. FT. (0.1640 ACRES)

HOUSE/ROOFTOP = 3,651 SQ. FT (0.0838 ACRES)

**OBSERVATION WELL DETAIL** 

4" SDR 35 OR

SCH 40 PVC RISER

PROPOSED IMPERVIOUS AREA = 4.023 SQ. FT. SURFACE AREA = 330 SQ. FT. STORAGE AREA = (SURFACE AREA x DEPTH) (340 x 1) = 330 CF TOTAL STORAGE AREA = 330 CF

#### \*ESD TO THE MEP IS MET

**ESD SPECIFICATIONS:** 

#### PLANTING SCHEDULE:

<u>PLANTS</u> <u>MINIMUM NUMBER</u> TREES

SPECIES TO BE DETERMINED BY LANDSCAPE CONTRACTOR CHOSEN FROM THE APPROVED SPECIES LIST AS DESCRIBED IN MDE MANUAL APPENDIX A.

SHRUBS / BUSHES SPECIES TO BE DETERMINED BY LANDSCAPE CONTRACTOR, CHOSEN FROM APPROVED SPECIES LIST 2

OBSERVATION WELL LOCATION RAISED BANK TOTAL IMPERVIOUS AREA TO BE TREATED = 4,023 SQ. FT. (0.0924 ACRES) OVERFLOW ELEVATION AT END = 356.0'BOTTOM ELEV. = 356.3'OVERFLOW ELEVATION AT TOP = 357.3'LANDSCAPE INFILTRATION DETAIL NOT TO SCALE



#### APPROVED: FOR HOWARD COUNTY DEPARTMENT OF PLANNING & ZONING

DATE CHIEF, DEVELOPMENT ENGINEERING DIVISION DIRECTOR DATE PROFESSIONAL ENGINEER DATE

STORMWATER MANAGEMENT LANDSCAPE INFILTRATION DESIGN LOT 78

## HOMEWOOD CROSSING

A=38.62

R=55.00°

COUR-

LIBER 9808, FOLIO 204 PLAT No. 18241 TAX No. 05-443431 FIFTH ELECTION DISTRICT HOWARD COUNTY, MARYLAND ADDRESS: 4706 ASHBY COURT ELLICOTT CITY, MARYLAND

ESE Consultants Inc. 7164 Columbia Gateway Dr. Suite 203 Columbia, MD 21046 TEL: 410-872-9105 FAX: 410-872-4870

DATE: 10/29/14 SCALE: 1"=40' FILE: SWM LOT 78 CHK'D: M.J.B. DRAWN: R.C.K. JOB NO: 1214



and Planning Engineering Land Surveying TOP ELEVATION = 356.8'

#### PROFESSIONAL CERTIFICATION: I HEREBY CERTIFY THAT THESE DOCUMENTS WERE PREPARED BY ME OR UNDER MY RESPONSIBLE CHARGE, AND THAT I AM A DULY LICENSED PROFESSIONAL LAND SURVEYOR UNDER THE LAWS OF THE STATE OF MARYLAND, LICENSE NO. 21328, EXPIRATION DATE 1/8/15.

#### SEWAGE DISPOSAL SYSTEM DATA (5 BDRM)

E60 ECOPOD (2 CHAMBER SYSTEM)

PROPOSED INVERT AT FOUNDATION WALL: XXX.X' 1. EXISTING GRADE OVER TANK: XXX.X' PROPOSED GRADE OVER TANK: XXX.X' INVERT IN: XXX.X' INVERT OUT: XXX.X'

2 DISTRIBUTION BOX: EXISTING GRADE OVER BOX: XXX.X' PROPOSED GRADE OVER BOX: XXX.X' INVERT IN: XXX.X' INVERT OUT: XXX.X'

3. TRENCH DESIGN:  $(5 BDRM \times 150 GPD/BDRM = 750 GPD)$ 750 GPD ÷ 0.8 APP. RATE = 937.50 SF USE 3' WIDE TRENCH WITH 84" GRAVEL BELOW PIPE 10' MIN. SPACING BETWEEN TRENCH EDGES 937.50 SF  $\div$  3' WIDTH = 312.50 LF x 0.50 = 156.25 LF MIN. TRENCH USE 3 53' LONG TRENCHES = 159 LF

APP. RATE = 0.8EFFECTIVE SIDEWALL = 5' BOTTOM MAX. DEPTH = 8'

TRENCH DATA

TRENCH 1 (T1): GROUND ABOVE = 349.8' INV. IN = 348.8'BOTTOM TRENCH = 341.8'

TRENCH 2 (T2): GROUND ABOVE = 347.5' INV. IN = 346.5'BOTTOM TRENCH = 339.5'

TRENCH 3 (T3): GROUND ABOVE = 345.8' INV. N = 344.8'BOTTOM TRENCH = 337.8'

WELL LOCATION LIMITS OF DISTURBANCE -SSF-SUPER SILT FENCE DRAINAGE AREA LIMITS

PERC TEST LOCATION

----- SOIL TYPE LINE GbB GLADSTONE LOAM, 3% TO 8% SLOPES GbC GLADSTONE LOAM, 8% TO 15% SLOPES MaD MANOR LOAM, 15% TO 25% SLOPES

DA-1 DRAINAGE AREA 1 TW TOP OF WALL GF GARAGE FLOOR BASEMENT FLOOR


BRL BUILDING RESTRICTION LINE STEEP SLOPE AREA

#### HOUSE OPTIONS:

BRICK SIDES AND REAR

TYPE: HAMPTON (GEORGIAN)
WALK-OUT BASEMENT ADD'L 1' TO HEIGHT OF BASEMENT WALLS OPTION No. 070 NAPLES SUNROOM ADDITION

OPTION No. 017 OPTION No. 529 OPTION No. 673

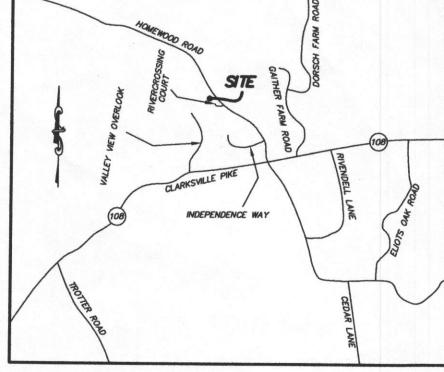

## VICINITY MAP 1" = 1000'

#### GENERAL NOTES:

1. THE LOT SHOWN HEREON WAS RECORDED ON MAY 2, 2006 AS PLAT NUMBER 18241. REFER TO THIS PLAT FOR DIMENSIONS, LOT AREAS, ALL EASEMENTS AND BUILDING RESTRICTIONS.

- 2. THIS AREA DESIGNATES A PRIVATE SEWER EASEMENT OF AT LEAST 10,000 SQUARE FEET, AS REQUIRED BY THE STATE DEPARTMENT OF THE ENVIRONMENT FOR INDIVIDUAL SEWAGE DISPOSAL. IMPROVEMENTS OF ANY NATURE IN THIS AREA IS RESTRICTED UNTIL PUBLIC SEWER IS AVAILABLE. THIS EASEMENT SHALL BECOME NULL AND VOID UPON CONNECTION TO A PUBLIC SEWAGE SYSTEM. THE COUNTY HEALTH OFFICER SHALL HAVE THE AUTHORITY TO GRANT ADJUSTMENTS TO THE PRIVATE SEWAGE EASEMENT. ANY CHANGES TO A PRIVATE SEWAGE EASEMENT SHALL REQUIRE A REVISED PERCOLATION CERTIFICATION PLAN. RECORDATION OF A MODIFIED EASEMENT SHALL NOT BE NECESSARY.
- 3. EXACT LENGTH OF SEPTIC TRENCHES ARE TO BE DETERMINED BY THE HEALTH DEPARTMENT AT THE TIME OF PRE-CONSTRUCTION INSPECTION.
- 4. SPOIL FROM THE TRENCHING OF THE SEPTIC AREA IS TO BE PLACED ON THE UPHILL SIDE OF THE EXCAVATION FOR EACH INDIVIDUAL LOT.
- 5. SEDIMENT AND EROSION CONTROLS WERE APPROVED BY HOWARD SOIL CONSERVATION DISTRICT UNDER F-05-069 AND GP-14-034 AND SHALL COMPLY WITH THE 1994 MARYLAND STANDARDS AND SPECIFICATIONS FOR SOIL EROSION AND SEDIMENT CONTROL
- 6. STORMWATER MANAGEMENT FOR THIS LOT AS SHOWN.
- 7. THE EXISTING WELL SHOWN ON THIS PLAN (IDENTIFIED WITH THE ATTACHED WELL TAG NUMBER HO-94-2468 HAS BEEN FIELD LOCATED BY ESE CONSULTANTS - PROFESSIONAL LAND SURVEYOR(S), AND IS ACCURATELY SHOWN.
- 8. THE EXISTING TOPOGRAPHY WITHIN THE AREA OF PROPOSED WORK IS TAKEN FROM FIELD RUN SURVEY WITH MAXIMUM ONE FOOT CONTOUR INTERVALS PREPARED BY ESE. DATED 5/11/11.

#### WELL AND SEPTIC NOTES:

TO THE BEST OF MY KNOWLEDGE, INFORMATION AND BELIEF, THE FOLLOWING STATEMENTS ARE TRUE:

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- 2. THE LOT SHOWN HEREON COMPLIES WITH THE MINIMUM OWNERSHIP WIDTHS AND LOT AREA AS REQUIRED BY THE MARYLAND DEPARTMENT OF THE ENVIRONMENT AS SHOWN ON THE RECORD PLAT 18240 GENERAL NOTES ITEM 2.
- 3. ANY CHANGES TO A PRIVATE SEWAGE EASEMENT SHALL REQUIRE A REVISED PERCOLATION CERTIFICATION PLAN.
- 4. THE SOIL TYPE FOR THIS LOT IS GBB, GBC AND MaD, HYDROLIC SOIL GROUP B.

## STORMWATER MANAGEMENT CONSTRUCTION AND MAINTENANCE NOTES:

- 1. FINAL GRADING FOR LANDSCAPE INFILTRATION SHOULD NOT TAKE PLACE UNTIL SURROUNDING SITE IS STABILIZED.
- 2. SUB SOIL SHALL NOT BE COMPACTED. EXCAVATION SHOULD BE CONDUCTED IN DRY CONDITIONS WITH EQUIPMENT LOCATED OUTSIDE OF THE PRACTICE TO MINIMIZE BOTTOM AND SIDEWALL COMPACTION.
- 3. SEE APPENDIX B.4 OF THE MARYLAND STORMWATER MANAGEMENT DESIGN MANUAL FOR SAND, GRAVEL AND PLANTING
- INSPECTION SHALL BE MADE AT THE FOLLOWING STAGES
- (a) DURING EXCAVATION TO SUB-GRADE
- (b) DURING PLACEMENT OF BACKFILL AND OBSERVATION WELL
- (c) DURING CONSTRUCTION OF APPURTENANT CONVEYANCE STRUCTURES
- (d) UPON COMPLETION OF FINAL GRADING AND ESTABLISHMENT OF PERMANENT STABILIZATION
- PRIVATELY OWNED PRACTICES SHALL HAVE A MAINTENANCE PLAN AND SHALL BE PROTECTED BY EASEMENT, DEED RESTRICTION, ORDINANCE OR OTHER LEGAL MEASURES PREVENTING ITS NEGLECT, ADVERSE ALTERATIONS AND
- 6. DURING FIRST YEAR OF OPERATION, INSPECTION FREQUENCY SHOULD BE AFTER EVERY MAJOR STORM AND POORLY ESTABLISHED AREAS RE-VEGETATED.
- 7. THE TOP FEW INCHES OF THE PLANTING SOIL SHOULD BE REMOVED AND REPLACED WHEN WATER PONDS FOR MORE THAN 48 HOURS OR THERE IS ALGAE GROWTH ON THE SURFACE OF THE FACILITY.
- 8. IF STANDING WATER PERSISTS AFTER FILTER MEDIA HAS BEEN MAINTAINED, THE GRAVEL, SOIL AND SAND MAY NEED TO BE CLEANED AND/OR REPLACED.
- 9. OCCASIONAL PRUNING AND REPLACEMENT OF DEAD VEGETATION IS NECESSARY. IF SPECIFIC PLANTS ARE NOT SURVIVING, MORE APPROPRIATE SPECIES SHOULD BE USED. WATERING MAY BE REQUIRED DURING PROLONGED DRY

#### LANDSCAPE INFILTRATION DESIGN (LESS THAN 10,000 SQ. FT) DRAINAGE AREA = 7,142 SQ. FT. PROPOSED IMPERVIOUS AREA = 4,023 SQ. FT. SURFACE AREA = 330 SQ. FT. STORAGE AREA = (SURFACE AREA x DEPTH) (340 x 1) = 330 CF TOTAL STORAGE AREA = 330 CF

#### \*ESD TO THE MEP IS MET

#### PLANTING SCHEDULE:

**ESD SPECIFICATIONS:** 

**PLANTS** MINIMUM NUMBER TREES

FINISHED GRADE-

4" CAP W/ 1" HOLE,

OBSERVATION WELL DETAIL

DRILLED IN IT .

STORMWATER MANAGEMENT COMPUTATIONS

HOUSE/ROOFTOP = 3,651 SQ. FT (0.0838 ACRES)

1.0" (RAINFALL TARGET)

(Pe) x (Rv) x (A) ÷ 12

DRIVEWAY (IMPERVIOUS) = 372 SQ. FT (0.0085 ACRES)

GRASS (NON-IMPERVIOUS) = 3,119 SQ. FT. (0.0716 ACRES)

TOTAL AREA TO BE TREATED = 7,142 SQ. FT. (0.1640 ACRES)

 $(0.0924 \div 0.1640) = 0.5634 = 56\%$ 

RUNOFF VOLUME (IN ACRES-FEET)

 $(Pe \times Rv) = (1 \times 0.554) = 0.554$  INCHES

(TOTAL DRAINAGE AREA) = 7,142 SQ. FT. (0.1640 ACRES)

(THE DIMENSIONLESS VOLUMETRIC RUNOFF COEFFICIENT)

(RUNOFF DEPTH IN INCHES THAT MUST BE TREATED)

 $0.05 + (0.009 \times (1)) = 0.05 + (0.009 \times (56\%)) = 0.554$ 

(1)  $\times$  (0.554)  $\times$  (7142)  $\div$  12 = 3,956.67  $\div$  12 = 329.72 CF

DRAINAGE AREA NO. 1

(DRIVEWAY AND ROOFTOP)

ESD CALCULATIONS:

Rv


4" SDR 35 OR

SCH 40 PVC RISER

SPECIES TO BE DETERMINED BY LANDSCAPE CONTRACTOR CHOSEN FROM THE APPROVED SPECIES LIST AS DESCRIBED IN MDE MANUAL APPENDIX A.

SHRUBS / BUSHES 2 SPECIES TO BE DETERMINED BY LANDSCAPE CONTRACTOR, CHOSEN FROM APPROVED SPECIES LIST

LOCATION RAISED BANK TOTAL IMPERVIOUS AREA TO BE TREATED = 4.023 SQ. FT. (0.0924 ACRES) TOTAL PERVIOUS AREA TO BE TREATED = 3,119 SQ. FT. (0.0716 ACRES) OVERFLOW ELEVATION AT END = 356.0'BOTTOM ELEV. = 356.3'(IMPERVIOUS AREA) = (IMPERVIOUS AREA + DRAINAGE AREA) OVERFLOW ELEVATION AT TOP = 357.3'LANDSCAPE INFILTRATION DETAIL

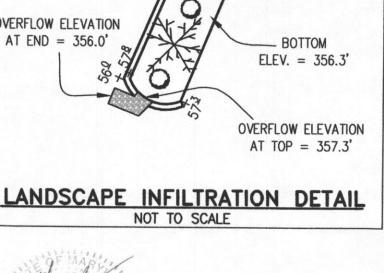

OBSERVATION WELL

# APPROVED: FOR HOWARD COUNTY DEPARTMENT OF PLANNING & ZONING

DIRECTOR DATE

CHIEF, DEVELOPMENT ENGINEERING DIVISION

PROFESSIONAL ENGINEER

LIBER 9808, FOLIO 204 PLAT No. 18241 TAX No. 05-443431 FIFTH ELECTION DISTRICT HOWARD COUNTY, MARYLAND ADDRESS: 4706 ASHBY COURT ELLICOTT CITY, MARYLAND

STORMWATER MANAGEMENT

LANDSCAPE INFILTRATION DESIGN

LOT 78

HOMEWOOD CROSSING



Land Planning Engineering Land Surveying

ESE Consultants Inc. 7164 Columbia Gateway Dr. Suite 203 Columbia, MD 21046 TEL: 410-872-9105 FAX: 410-872-4870

DATE: 10/29/14 FILE: SWM LOT 78 SCALE: 1"=40" CHK'D: M.J.B. JOB NO: 1214 DRAWN: R.C.K.



DATE

DATE

