LAYOUT	INSP 4		
INSP 2 8/19/2014	INSP 5		
INSP 3	INSP 6		
ISSUE DATE:	PEF	RMIT	P
APPROVAL DATE: 9/26/2019			Α
75.7000		EALTH DEPARTMEN ONMENTAL HEALTH	174
I DODDEGO			
ADDRESS:		PHONE NUMBE	R:
SUBDIVISION:		LOT NUMBER:	5
ADDRESS: //348 Will	ow Ridge	PROPERTY OWNER:	
SEPTIC TANK CAPACITY (GAL	011	Sale Carlot Control	E FILTER REQUIRED
PUMP CHAMBER CAPACITY (G	ALLONS):	COMPARTMENT	TED TANK REQUIRED
NUMBER OF BEDROOMS:	-		
SQUARE FEET PER BEDROOM:	N. Walley	E FE SE	
LINEAR FEET OF TRENCH REQ	UIRED:		
TRENCHES: Trench to b	e feet wide. Inlet	feet below original grade.	Bottom maximum deoth

feet below original grade. Effective area begins at feet below original grade. feet of

DATE:

PLANS APPROVED:

LOCATION:

NOTES:

NOTE: PERMIT VOID AFTER 2 YEARS
NOTE: CONTRACTOR RESPONSIBLE FOR SCHEDULING A PRE-CONSTRUCTION INSPECTION FOR ALL INSTALLATIONS

NOTE: WATERTIGHT SEPTIC TANKS REQUIRED

NOTE: ALL PARTS OF SEPTIC SYSTEM SHALL BE 100 FEET FROM ANY WATER WELL

stone below distribution pipe.

NOTE: MANHOLE RISERS REQUIRED ON ALL SEPTIC TANKS AND PUMP CHAMBERS UNLESS SPECIFICALLY AUTHORIZED

NEITHER THE HOWARD COUNTY COUNCIL NOR THE HEALTH DEPARTMENT IS RESPONSIBLE FOR THE SUCCESSFUL OPERATION OF ANY SYSTEM PERMITTEE RESPONSIBLE FOR OBTAINING FINAL APPROVAL ON THIS PERMIT CALL 410-313-2640 FOR INSPECTION OF SEPTIC SYSTEM

ABSORPTION AREA  DISTRIBUTION BOX LEVEL  DISTRIBUTION BOX PORT  SEPTIC TANK DATA SEPTIC TANK I LEVEL  MANUFACTURER  CAPACITY  GAL SEAM LOC  TANK LID DEPTH  BAFFLES  BAFFLE FILTER  MANHOLE LOC	NOT TO SCALE	TRENCH/DRAINFIELD DATA WIDTH INLET BOTTOM
MANUFACTURER  CAPACITY  SEAM LOC  TANK LID DEPTH  BAFFLES  BAFFLE FILTER  MANHOLE LOC  6° PORT LOC  WATERTIGHT TEST  SLOTTED  DATE ON LID  PUMP/SEPTIC TANK LEVEL  MANUFACTURER  CAPACITY  GAL  SEAM LOC  TANK LID DEPTH  BAFFLES  BAFFLE FILTER  MANUFACTURER  CAPACITY  GAL  SEAM LOC  TANK LID DEPTH  BAFFLES  BAFFLE FILTER  MANHOLE LOC  6° PORT LOC  WATERTIGHT TEST  SLOTTED  DATE ON LID  ROAD NAME		TOTAL LENGTHABSORPTION AREA
BAFFLES BAFFLE FILTER MANHOLE LOC 6° PORT LOC WATERTIGHT TEST SLOTTED DATE ON LID DATE ON LID	63	MANUFACTURER  CAPACITYGAL  SEAM LOC  TANK LID DEPTH  BAFFLES BAFFLE FILTER MANHOLE LOC 6° PORT LOC WATERTIGHT TEST SLOTTED DATE ON LID  PUMP/SEPTIC TANK LEVEL  MANUFACTURER CAPACITYGAL  SEAM LOC
	ROAD NAME	BAFFLES BAFFLE FILTER MANHOLE LOC 6° PORT LOC WATERTIGHT TEST SLOTTED

### SEPTIC SPECIFICATIONS WORKSHEET

Subdivision Willow Redge
Street Name 11348 Willow Ridge Love Lot Number 5
Average Percolation Rate (min./in.)min./inch Application Rate (GPD/sq. ft.)
Number of Bedrooms Design Flow (#BRx150) = 750
Square Footage (of House) 6777 Septic Tank Capacity (gal.)
Sidewall Credit / % Reduction feet / % Total Length of Trench (ft.)
*All Septic/Pump tanks must be top seamed unless otherwise approved by this agency.
*All Septic tanks must be compartmented unless otherwise approved by this agency.
Baffle Filter Required? Yes No
TRENCH DIMENSIONS: Trench to feet wide. Inlet is at feet below original grade with feet of stone below the distribution pipe. Bottom maximum depth is feet below original grade. Effective sidewall begins at feet below original grade. Maintain at least feet spacing between trenches.
PUMP SYSTEM PROPOSED? YES NO
Pump system details: gallon pump chamber
Note 1: Septic pump detail to be provided by installer prior to issuance of septic permit.
Note 2: Pump performance test required prior to Health Department approval of pumped septic system.
LOCATION: * Shared - septem connection  1. Set septic tank  2. Set distribution box  2. Set distribution box  3. Install trenches on contour enough to withstand  up to 8 feet of soil cover.
ADDITIONAL NOTES Do not order the septic tank until after layout inspection and Sanitarian approval. Stake
septic easement corners. Call for layout inspection. Mark utilities. Gravel tickets must be available for
Environmental Sanitarians. Stone must be approved by the Howard County Health Department. A written variance
request is required for tanks deeper than 3 feet. A traffic bearing lid is required for tanks deeper than 4 feet.
Reviewed by: Bucker Date: 1/13/14

### Baker, Brian

From:

Baucom, Scott

Sent:

Friday, September 26, 2014 2:17 PM

To:

Day, Lori; Wolf, Kevin

Cc:

Hart, Amy, Rocco, Anthony, Tuder, Matt, Baker, Brian; Martin, Sharhonda; Williams, Jeffrey;

Bozzell, Duane

Subject:


U&O Release 11348 Willow Ridge Ln.

On the morning of September 26th, Scott Baucom observed the start-up of a Sewage Grinder Pump at the Willow Ridge Shared Septic System:


Willow Ridge Shared Septic, Contract 54-4301-D Classic Homes, Lot 5 11348 Willow Ridge Ln. Ellicott City, MD 21042

The Sewage Grinder Pump test was successful; the Bureau of Utilities releases its hold on this property for U&O.

Scott Baucom
Operations Supervisor I
Howard County DPW, Bureau of Utilities
8270 Old Montgomery Rd.
Columbia, MD 21045
Office (410) 313-4975
FAX (410) 313-4989

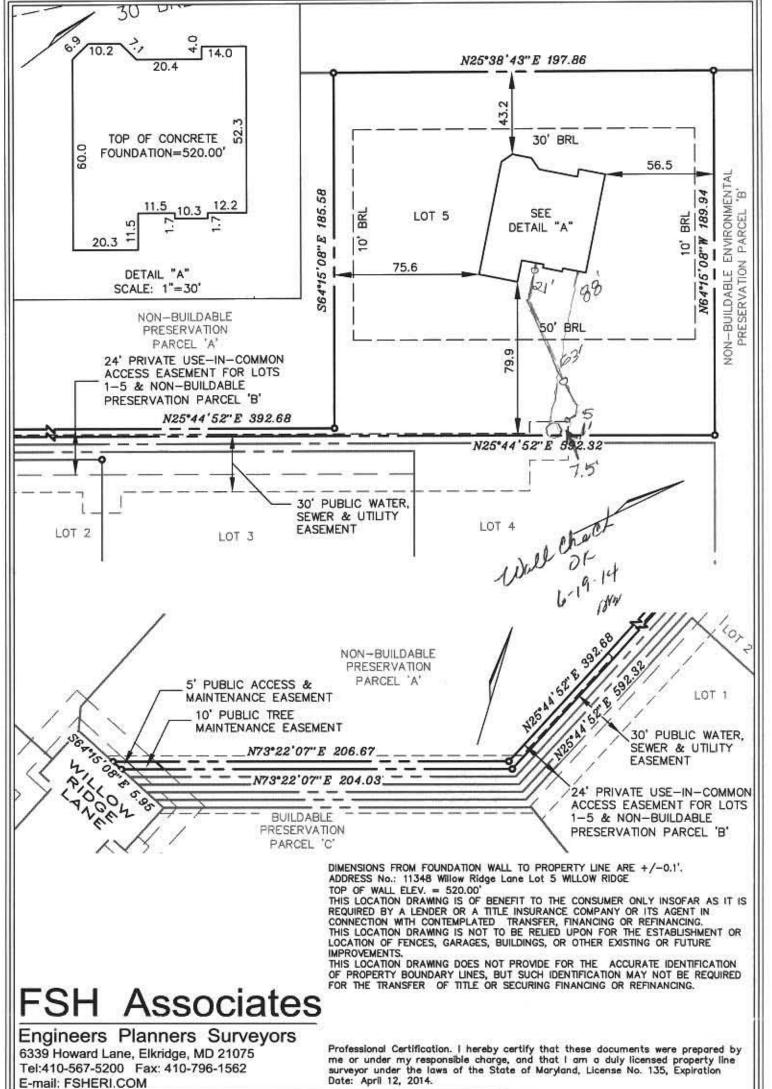


#### WALL CHECK FOUNDATION Date: 03/27/14 FINAL Date: DRAWN BY: **KJB** SCALE: 1"=50" 3033 W.O. No.:

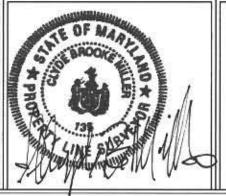


#### LOT 5

WILLOW RIDGE #11348 WILLOW RIDGE LANE


MDR PLAT No. 22032 & 22033 TAX MAP 16 GRID 15 PARCEL NOS. 89, 91, P/O 183 & 201 3rd ELECTION DISTRICT HOWARD COUNTY, MARYLAND

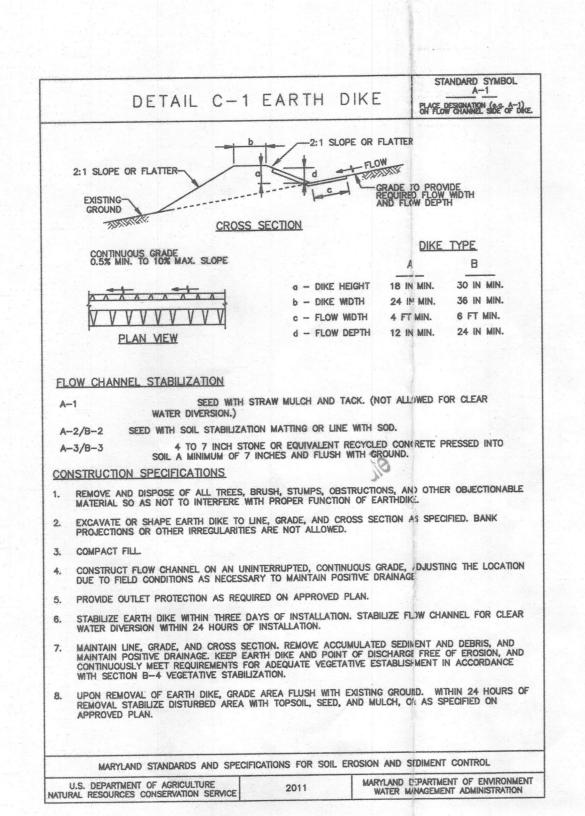

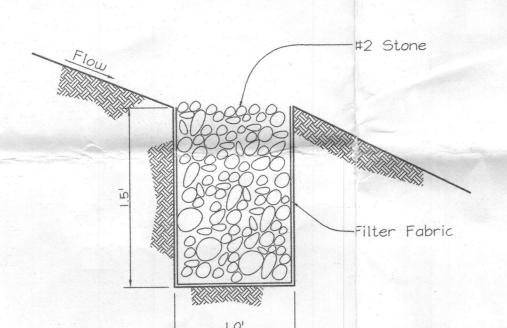

# TYPICAL LEVEL SPREADER

NOT TO SCALE See plan for level spreader lengths

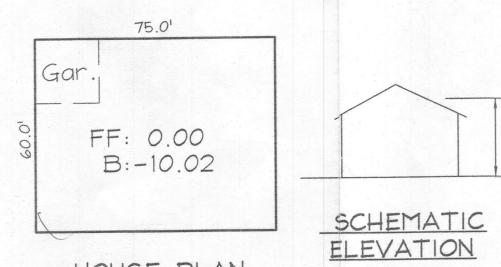

HOUSE PLAN NOT TO SCALE SCALE: 1" = 30'

ENGINEERS CERTIFICATE

"I CERTIFY THAT THIS PLAN FOR SEDIMENT AND EROSION CONTROL REPRESENTS A PRACTICAL AND WORKABLE PLAN BASED ON MY PERSONAL KNOWLEDGE OF THE SITE CONDITIONS AND THAT IT WAS PREPARED IN ACCORDANCE WITH THE REQUIREMENTS OF THE HOWARD SOIL CONSERVATION DISTRICT.

SIGNATURE OF ENGINEER

ZACHARIA Y. FISCH, P.E.

4/23/13 DATE

DEVELOPERS CERTIFICATE

"I/WE CERTIFY THAT ALL DEVELOPMENT AND CONSTRUCTION WILL BE DONE ACCORDING TO THIS PLAN FOR SEDIMENT AND EROSION CONTROL, AND THAT ALL RESPONSIBLE PERSONNEL INVOLVED IN THE CONSTRUCTION PROJECT WILL HAVE A CERTIFICATE OF ATTENDANCE AT A DEPARTMENT OF THE ENVIRONMENT APPROVED TRAINING PROGRAM FOR THE CONTROL OF SEDIMENT AND EROSION BEFORE BEGINNING THE PROJECT. I ALSO AUTHORIZE PERIODIC ON-SITE INSPECTION BY THE HOWARD SOIL CONSERVATION DISTRICT.

SIGNATURE OF DEVELOPER

DATE

THIS DEVELOPMENT PLAN IS APPROVED FOR SOIL EROSION AND SEDIMENT CONTROL BY THE HOWARD SOIL CONSERVATION DISTRICT


Permanent Seeding Summary

(10-20-20)

Hardiness Zone (from Figure B.3): 6b Seed Mixture (from Table B.3): 6

HOWARD SOIL CONSERVATION DISTRICT

SOILS LEGEND NAME / DESCRIPTION SOIL GROUP Manor gravely loam, 8 to 15 percent slopes, moderately eroded MID3 | Manor loam, 15 to 25 percent slopes, severely eroded

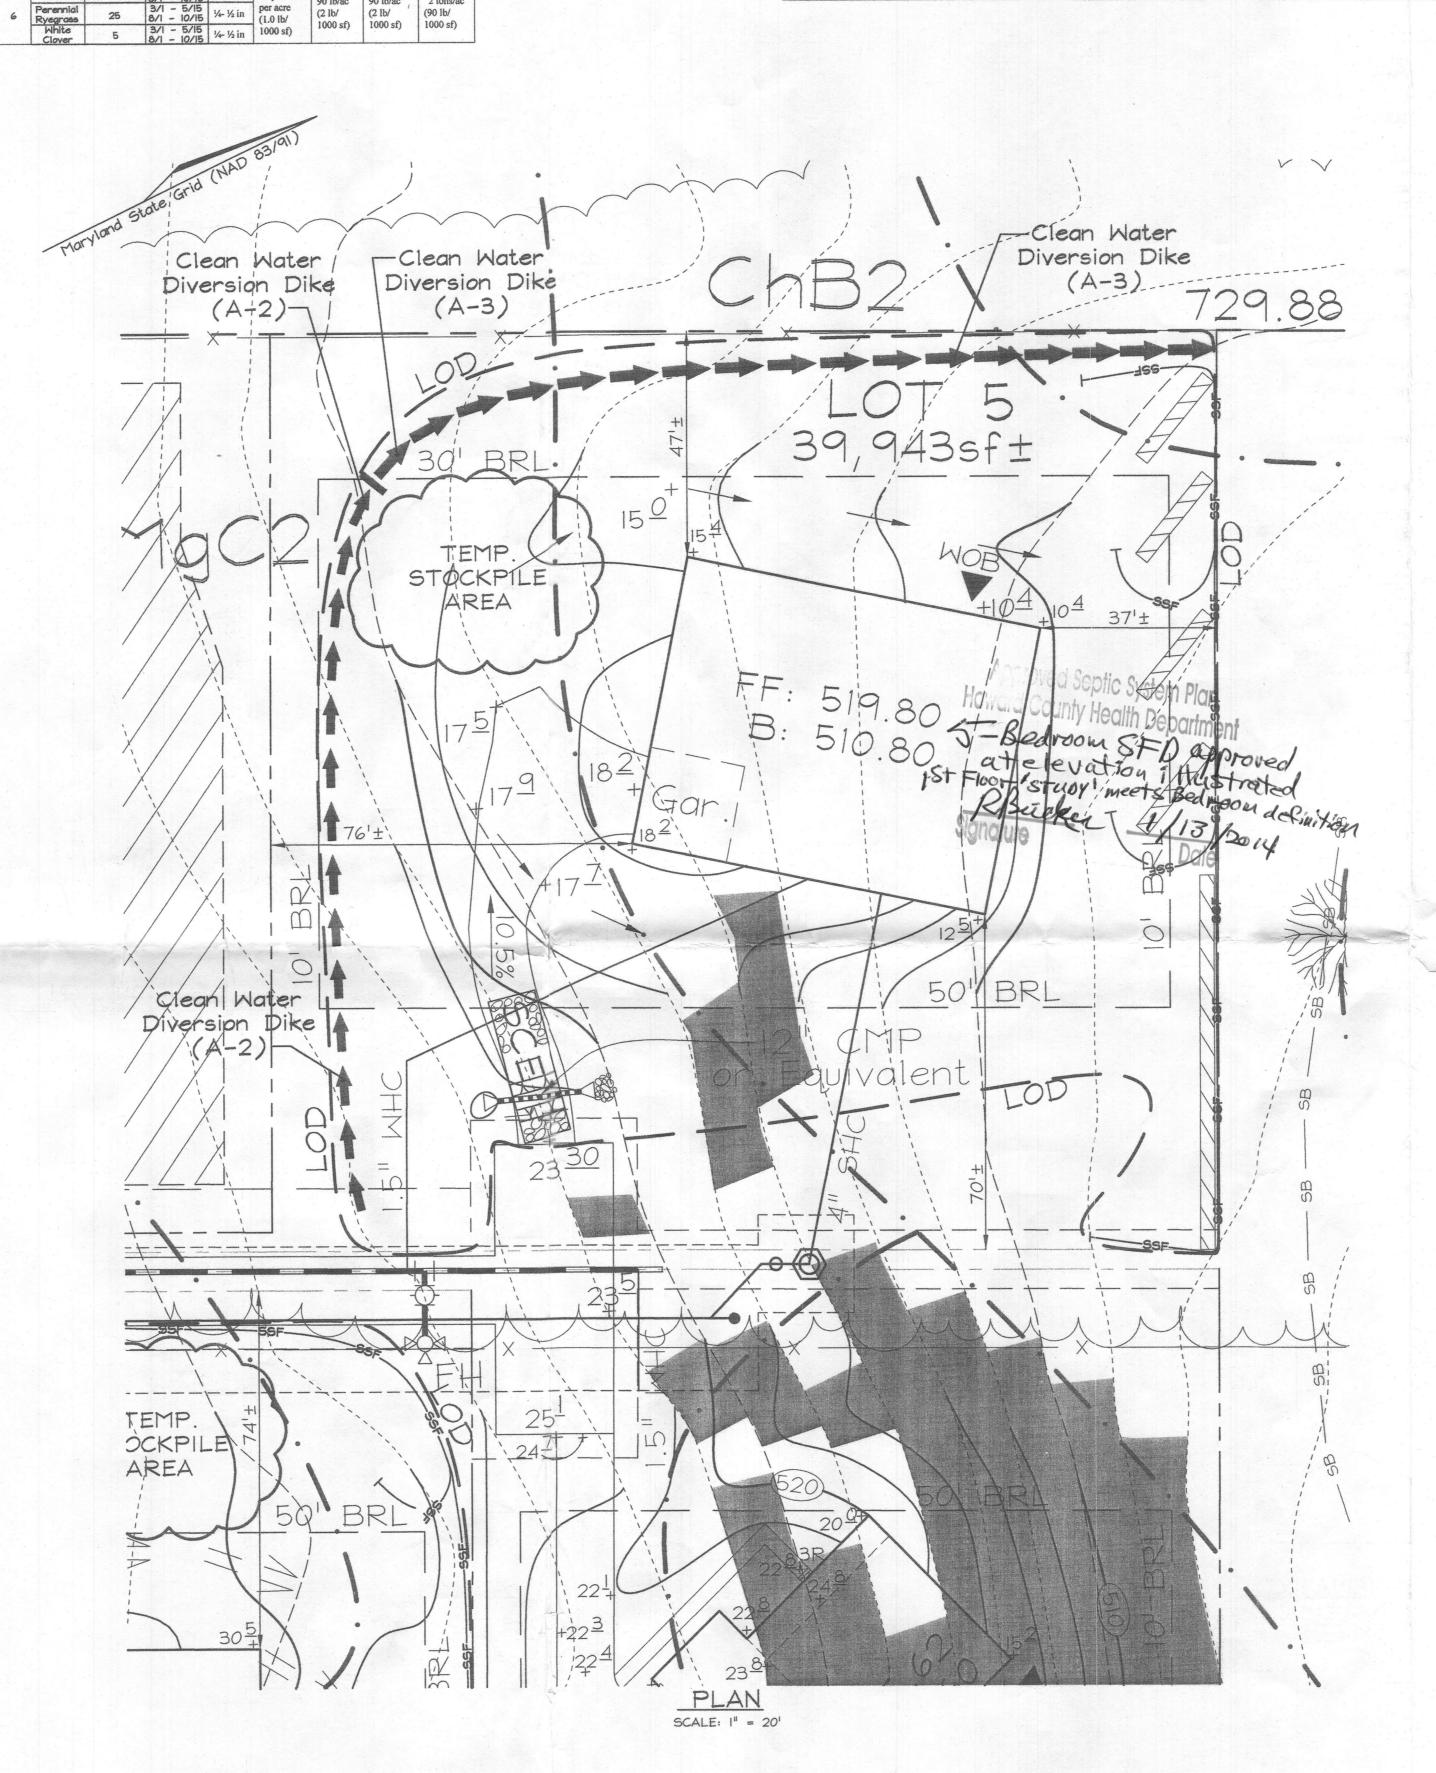

VICINITY MAP SCALE: 1"=2000" ADC MAP 10 K5

GEODETIC CONTROL STATIONS

Coordinates based on NAD'83, Maryland coordinate system as projected by Howard County geodetic control stations no. 16E1 and no. 16H3 denotes 🗣 approximate location (see vicinity map).

Sta. 16E1 N 593,250.9638 E 1,340,192.7010 E1.: 463.893 Sta. 16H3 N 592,408.0425 E 1,341,523.9677 E1.: 469.712

LEGEND Super Silt Fence Silt Fence Limit of Disturbance Soil Boundary Walk Out Basement Utility Poles -----382 Existing Contour 82 Proposed Contour Direction of Flow Existing Spot Elevation +8253 Proposed Spot Elevation momen Existing Trees Level Spreader Clean Water Diversion Dike 

## GENERAL NOTES

- 1. This property is zoned "RR-DEO" per the 02/02/04 Comprehensive Zoning Plan and the Comp Lite Zoning Regulations Amendments effective 07/28/06. 2. Total area of property = 0.917 Act 3. Public water and public shared septic system will serve this lot.
- 4. On-site topography and existing utilities based on a Field Run Topographic Survey prepared by FSH Associates in July, 2003 with two foot contours.
- 5. A stockpile will not be permitted on site. 6. Per F-08-050 approved Final plans, Stormwater Management is provided
- by sheet flow to buffer via level spreaders. 7. No section of super silt fence is to exceed 50' in length before curling into the LOD.

# SEQUENCE OF CONSTRUCTION

1. Obtain grading permit. (3 weeks)

2. Notify Howard County Department of Inspections, License and Permits at (410) 313-1880 at least 48 hours before starting

3. Install Stabilized Construction Entrance, Clean Water Diversion Dike,

Silt Fence and/or Super Silt Fence. (2 days) 4. After receiving permission from the sediment control inspector,

rough grade site and begin building construction. (I week) 5. Construct driveway and finish building construction. (4 months) 6. Fine grade and permanently stabilize site. (3 days)

7. Upon stabilization of all disturbed areas and with the permission of the Sediment Control Inspector, remove all sediment control measures and stabilize any remaining disturbed area.

> CLASSIC HOMES 50 W. Edmondston Drive, Suite 405 Rockville, Maryland 20852 301.256.4110

PLOT PLAN

WILLOW RIDGE LOT 5 Plat #22030-22033

TAX MAP 16 GRID 15 3RD ELECTION DISTRICT

PROFESSIONAL CERTIFICATION

I hereby certify that these documents were prepared a approved by me, and

that I am a duly licensed professional engineer under the laws of the State of

Maryland, License No. #22418, Expiration Date: 07/29/2013.

PARCELS 89, 91 \$ 201 HOWARD COUNTY, MARYLAND



Engineers Planners Surveyors 6339 Howard Lane, Elkridge, MD 21075 Tel:410-567-5200 Fax: 410-796-1562

DESIGN BY: \_ CRH2 DRAWN BY: CRH2 CHECKED BY: ZYF SCALE: 1" = 20' DATE: April 23, 2013 W.O. No.: 3033 SHEET No .: 1 OF 2

Rev 0

GP-13-065