Building Permit Application

Howard County Maryland

Department of Inspections, Licenses and Permits

3430 Court House Drive

Permits: 410-313-2455

www.howardcountymd.gov

DILP 2016 WAY 5 PM2:19

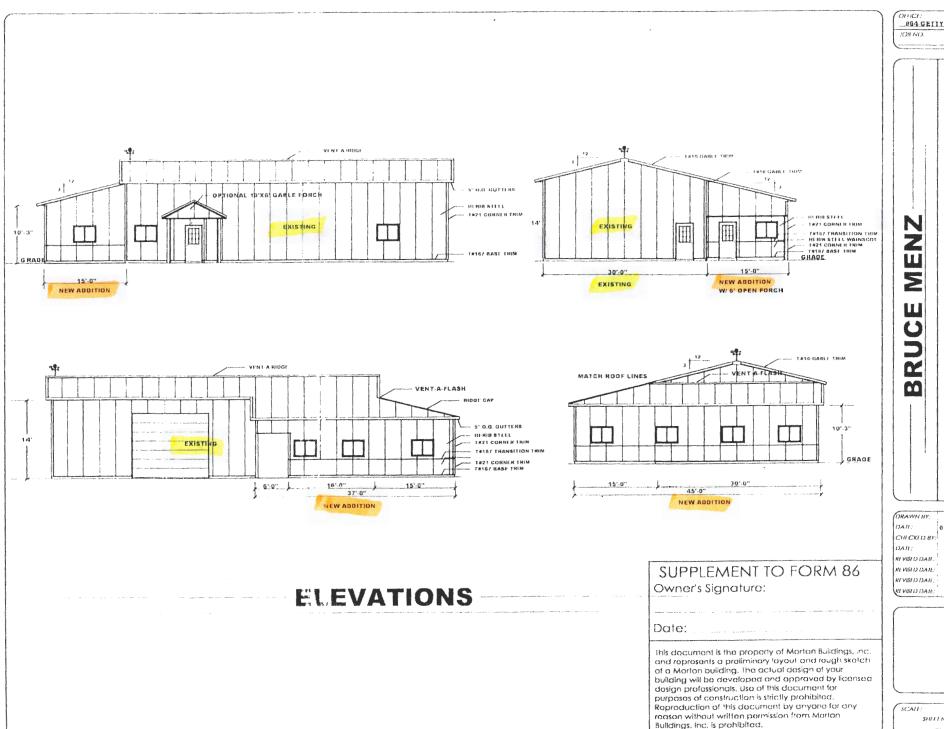
Permit No.: 816001911

| | A. Allen A | TO THE REAL PROPERTY OF THE PARTY OF THE PAR | | | 1 11 | 12 - 1- | 7 |
|--|--|--|------------------------|--|--|--|-------------|
| Building Address: 12 | 71 Unk | depument 1 | 1. | Property Owner's Name: | RUCE + RANGE | OFIENZ | |
| Culo ac an'll | B States | Md. Zip Code: 2 | 1994 | Address: 1771 Just | CRECANTER R | Zip Code: 21/49 | |
| | | | | Phone: 410-442-21 | State: Fav. Call | 0-443-1838 | |
| Suite/Apt. # | SDP | /WP/BA#: | - 2 | Email: 455 614 5K2 | A CAMERS | T. B. of | |
| Census Tract: 6030 |) | Subdivision: STRENK | C12 180 | | - | | |
| Section: | Area | Lot: | / | Applicant's Name & Mailing | Address, (If other tha | in stated herein) | |
| Tax Map:9 | | 328 Grid: | | Applicant's Name: | | | |
| | | | | Address: | Factor | 7in Codes | |
| Zoning: N | 1ap Coordina | tes: Lot Size | : GARC | City:Phone: | _State: | _ ZIp Code: | |
| | | | | Phone: | rdx: | | 1 |
| Existing Use: Hom | 2 500 | P | | | 1 112 | | - |
| Proposed Use: Ho. | me Sh | 00 | | Contractor Company: | 2/4 | 1 | |
| Estimated Construction Co | | | | Contact Person: BRUC | e mene | DEVALLE | |
| | | | | Address: | / | 4 | |
| | | ellition to E | 1581119 | City: Sta | ate:Zip C | ode: | |
| 60×30 MOR | TON B | ulding | | License No. : | | A CON | |
| | | | -11 | Phone: | Fax: | 4 4 | - |
| _ | 11/ | 0. | | Email: | | V.5 | V |
| Occupant or Tenant: | | a | 11 | | n/1 2= | DAII 3 | |
| Was tenant space previou | isty occupied | P □Yes | Xile | Engineer/Architect Company | : /lorTon 1 | DENAINAS IN | |
| Contact Name: | | | | Responsible Design Prof.: | | | |
| | | | | | - | | The same of |
| Address: | | | | Address: | | THE PARTY OF THE P | AS |
| City: | | State: Zip Code: | | City:Sta | ate: Zip Co | de: | |
| | | Fax: | | Phone: | | - | |
| | | 20 | | | | | 7 |
| Email: | | | | Email: | A THE STATE OF THE | | |
| Commercial Building Cha | aractoristics | Residential Building Ch | gracteristics | · Utilities | The state of the s | | 7 |
| Height: | aracteristics | SF Dwelling SF Tov | | Water Suppl | 1000 | A CONTRACTOR OF THE CONTRACTOR | |
| No. of stories: | | Depth | Width | ☐ Public ' | | | |
| Gross area, sq. ft./floor: | 915 80 FT | 1 st floor: | | Private | | CERTIFICAL TOTAL | |
| | The same of the sa | 2 nd floor: | | | | Statistical Control of the Control o | (25) |
| Area of construction (sq. | ft.): /005 | Basement: | | Sewage Dispos | d | 7 | |
| | | ☐ Finished Basement | | □ Public | | The state of the s | |
| Use group: | | ☐ Unfinished Basement | | Private | VASA | Vi i | |
| | | ☐ Crawl Space | | electric Yes | □ No | | |
| Construction ty | pe: | ☐ Slab on Grade | | Gas: Xes . | □ No | | 1 |
| Reinforced Concrete | | No. of Bedrooms: | | Heating System | 400 | | |
| Structural Steel | | Multi-family Dw | elling | □ Electric □ Oil | | | |
| ☐ Masonry | | No. of efficiency units: No. of 1 BR units: | | | | | |
| State Certified Modula | r | No. of 2 BR units: | | Natural Gas Propar | | 0 | |
| LI State Certified Modula | 1 | No. of 3 BR units: | 4 | ATT, ATT | | | |
| | - | Other Structure: | | THE STATE OF THE PARTY OF THE P | 1 | | |
| | | Dimensions: | | ☐ Ye | | | |
| Roadside Tree Proje | Rermit | Footings: | . | To the same of the | | | 1 |
| The state of the s | No | Roof: | | Grading Per | rmit Number: | | |
| Roadside Tree Project | Permit # | ☐ State Certified Modul | ar | | | | |
| | | ☐ Manufactured Home | | Building Shell Res | mit Number: | | |
| | | | | | | | _ |
| WITH ALL DECLILATIONS OF UCA | MARIO COUNTY 18 | BUCH ARE ARRIVEABLE THERETO. | (4) THAT HE STHE WHILE | KE THIS APPLICATION; (2) THAT THE II | MATERICED DOODERTY NO | AT COPCIFICALLY OFFCOURED IN | |
| THIS APPLICATION; (5) THAT HE/S | SHE GRANTS COL | INTY OFFICIALS THE RIGHT TO ENT | ER ONTO THIS PROPER | PERFORM NO WORK ON THE ABOVE TY FOR THE PURPOSE OF INSPECTING | THE WORK PERMITTED AND | POSTING NOTICES | |
| 179. | Men | / | | DRUCES POECH | 12 | KECEN | /ED |
| Applicant's Signature | 1 | 2 , . | Print | Name | 011 | | 1 4 |
| 655 biask | na d | omenst, No | 7 | 5-5-21 | 116 | 1 | |
| Email Address | AND SO | | Date | | , | MAY 052 | die |
| OUSWER | 2 | | | | | | 410 |
| Title/Company | , | | , | | | LICENSES O PO | |
| | | | | ANCE OF HOWARD COUNTY | to the state of th | LICENSES & PER | MITS |
| | | **; | PLEASE WRITE NEATL | | | DIVISION | |
| | | | -FOR OFFICE U | SE UNLY- | Ψ | 2= 0) | |
| AGENCY | DATE | IGNATURE OF APPROVAL | DPZ SETBACK IN | FORMATION | Filing Fee | \$05.00 | |
| State Highways | | | Front: | , , | Permit Fee | \$ | |
| | | | Rear: Side: | | Tech Fee | \$ | |
| Building Officials | | | Side St.: | - And | Excise Tax PSFS | \$ | |
| BSZA (Zoning) | | | All minimum set | backs met? | Guaranty Fund | | 15.1 |
| PSZA (Engineering) | | | | nit Required? Yes Dito | Add'i per fee | \$ 100-00 | 100 |
| Health | 5/12/16 | OIL DELLA | Historic Districti | ☐ Yes ☐Ño | Total Fur- | 7 | |
| Is Sediment Control appro | oval sequired 5 | or issuance? [] Yes [] Mo | | New Town Zone: | Sub- Total Paid | \$ | |
| CONTINGENCY CONST | | | SDP/Red-line ap | proval date: | Balance Due | \$ | |

Yellow PSFA Fagincaring

Control Health (*)

Green: PSZA, Zoning



HG4 GETTYSBURG

MORTON BUILDINGS, INC

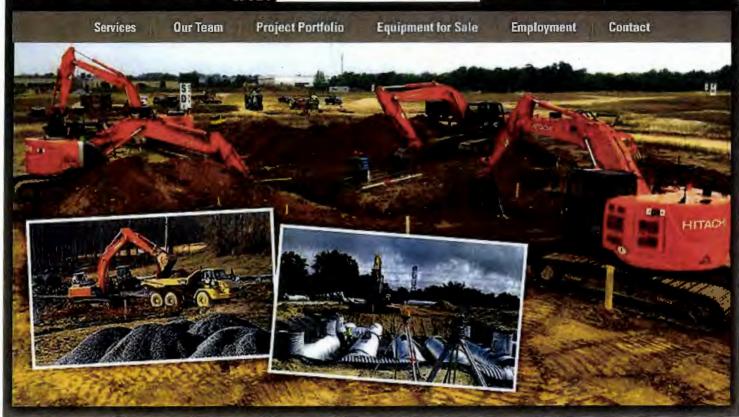


02/17/15

SHEEL NO.







Utilities Unlimited, Inc.
1771 Underwood Road
Sykesville, Maryland 21784
410-442-1755 • [f] 410-442-1838
info@utilitlesunlimitedinc.com
Services | Our Team | Gallery | Equipment for Sale
Employment | Contact | Home | Site Map | Intranet

Utilities Unlimited Incorporated is a privately owned full service utility contractor located in Sykesville, MD. Since 1987 Utilities Unlimited Incorporated has provided the Maryland area with full site development services. With our main focus in <u>underground utilities</u>, we also offer services in <u>excavating</u>, <u>clearing</u>, <u>pumping stations</u>, and <u>tank installments</u>.

Oswald, Hank

From:

b55bigsky@comcast.net

Sent:

Wednesday, May 11, 2016 4:06 PM

To:

Oswald, Hank

Subject:

Re: B16001911_1771 Underwood Road_Addition

Hank, Morton building is a pole barn with a concrete floor inside .there is no plumbing that will affect the septic system. Thanks Bruce

Sent from my iPad

On May 11, 2016, at 3:58 PM, Oswald, Hank < hoswald@howardcountymd.gov > wrote:

Bruce Menz:

This office received a building permit entailing an addition to an existing 60 X 30 Morton Building. What kind of structure is the Morton building? I'm trying to determine if the addition will have any effect on the onsite well, septic system or sewage disposal area. Does the Morton building currently have plumbing? Will the addition have plumbing?

Thanks in advance.

Hank

Hank Oswald, L.E.H.S.
Howard County Health Department
Bureau of Environmental Health
Well & Septic Program
8930 Stanford Boulevard
Columbia, MD 21045
410.313.1786 (Office)
410.313.2648 (Fax)

Oswald, Hank

From:

Oswald, Hank

Sent:

Wednesday, May 11, 2016 3:58 PM

To:

'B55BIGSKY@COMCAST.NET'

Subject:

B16001911_1771 Underwood Road_Addition


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Thanks in advance.

Hank

Hank Oswald, L.E.H.S. Howard County Health Department Bureau of Environmental Health Well & Septic Program 8930 Stanford Boulevard Columbia, MD 21045 410.313.1786 (Office) 410.313.2648 (Fax)



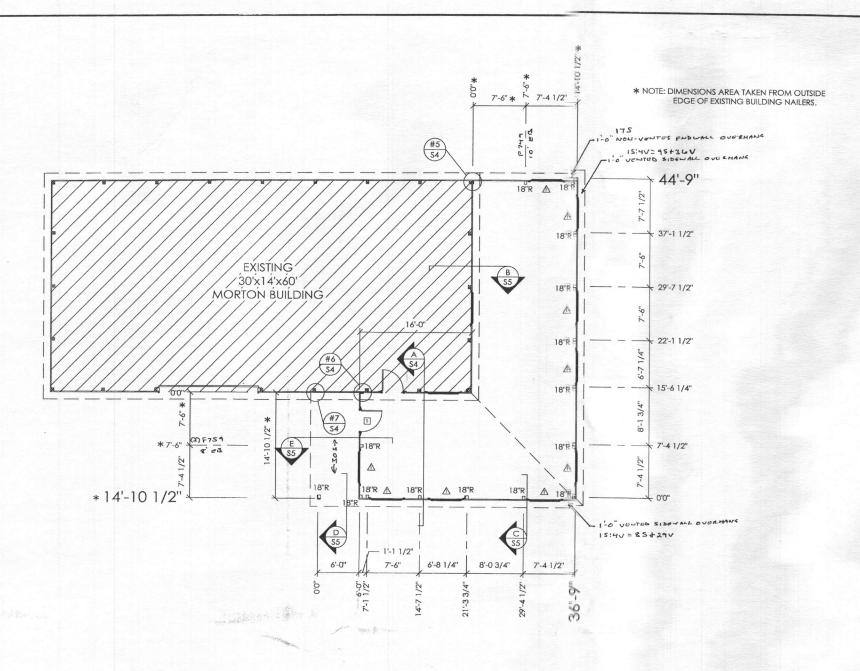RECEIVED

CONSTRUCTION PLANS

ESTIMATOR'S SIGNATURE 26.21 CONTACT: JIM ERICKSON SECOND CONTACT

DATE PLANS SENT

MAY 0 5 2016

LICENSES & PERMITS DIVISION

THIS IS A FINAL SET OF CONSTRUCTION DRAWINGS.
ALL ALTERATIONS TO THESE PLANS MUST BE
ACKNOWLEDGED BY A CHANGE ORDER.

6356 PHONE EXTENSION PHONE ESTIMATOR EXTENSION

5/12/15

OFFICE:
GETTYSBURG, PA JOB NO. 064-048366



BRUCE MENZ



| DRAWN BY: | LB |
|---------------|-----------|
| DATE: | 4/29/2015 |
| CHECKED BY: | _ |
| DATE: | |
| REVISED DATE: | |
| REVISED DATE: | |
| REVISED DATE: | |
| REVISED DATE: | |

SCALE: AS NOTED SHEET NO. S10F S5

COLUMN PLAN LEGEND

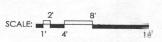
- 3-2x6 LAMINATED COLUMN LOCATION
- 3-2x6 LAMINATED COLUMN LOCATION W/ ADDT'L 2x6 LAMINATE
- - HEADERED TRUSS LOCATION
- 3048 MB910 9-LITE GLASS IN PLAIN FLAT LEAF WALKDOOR(S), IN SWING, RIGHT HINGE WITH DOUBLE CYLINDER DEADBOLT, KEYED LEVER LOCKSET
 (9) 4429 MB SLIDING WINDOW(S)
- SIDE AND END STEEL FASTENED WITH STAINLESS STEEL SCREWS
- SIDE AND STEEL FASTENED WITH STAINLESS STEEL SCREWS
 18" DIAMETER FOOTING WITH 8" THICK MINIMUM READY-MIX
 CONCRETE BELOW BOTTOM OF LOWER COLUMN WITH ADDITIONAL
 READY-MIX TO TOP OF 218M STILT (9"±). PLACE CONCRETE
 BELOW AND ABOVE BOTTOM OF LOWER COLUMN IN ONE OPERATION.

UNIT SYMBOL FROM LEGEND 37 3/4" 33 5/8" 52 1/4"

HEIGHT

ROUGH OPENING SCHEDULE

WIDTH



DESIGN AND EXPLANATORY NOTES

 EXTERIOR DOOR AND WINDOW LOCATIONS ARE TAKEN FROM THE EXTERIOR FACE
OF THE NAILERS AND ARE TO THE CENTER OF THE DOOR AND WINDOW UNITS.

VERIFY ALL DOOR, WINDOW, SKYLIGHT AND SIDELIGHT LOCATIONS WITH THE OWNER.

OFFICE: GETTYSBURG, PA

064-048366




BRUCE MENZ





| DRAWN BY: | LB |
|---------------|-----------|
| DATE: | 4/29/2015 |
| CHECKED BY: | |
| DATE: | |
| REVISED DATE: | |
| REVISED DATE: | |
| REVISED DATE: | |
| REVISED DATE: | |



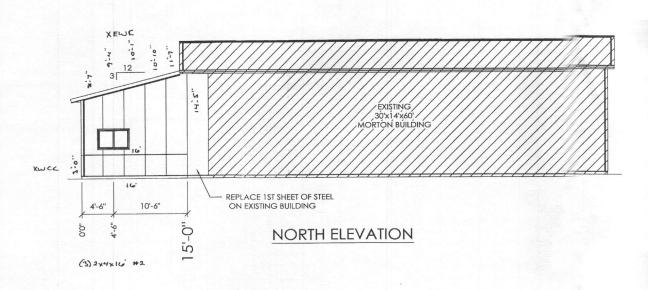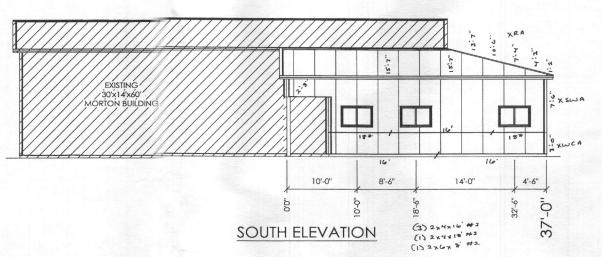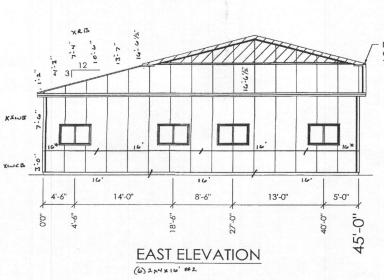SCALE: AS NOTED SHEET NO. S2 OF S5








NEW GABLE TRIM MUST LAP OVER THE TOP OF THE T#6 AND TUCK UNDER EXISTING GABLE TRIM

RECEIVED


LICENSES & PERMITS DIVISION

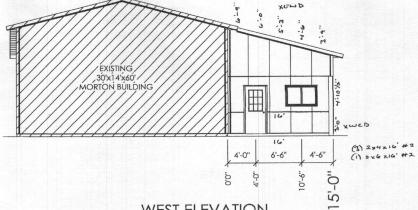MAY 0 5 2016



WEST ELEVATION

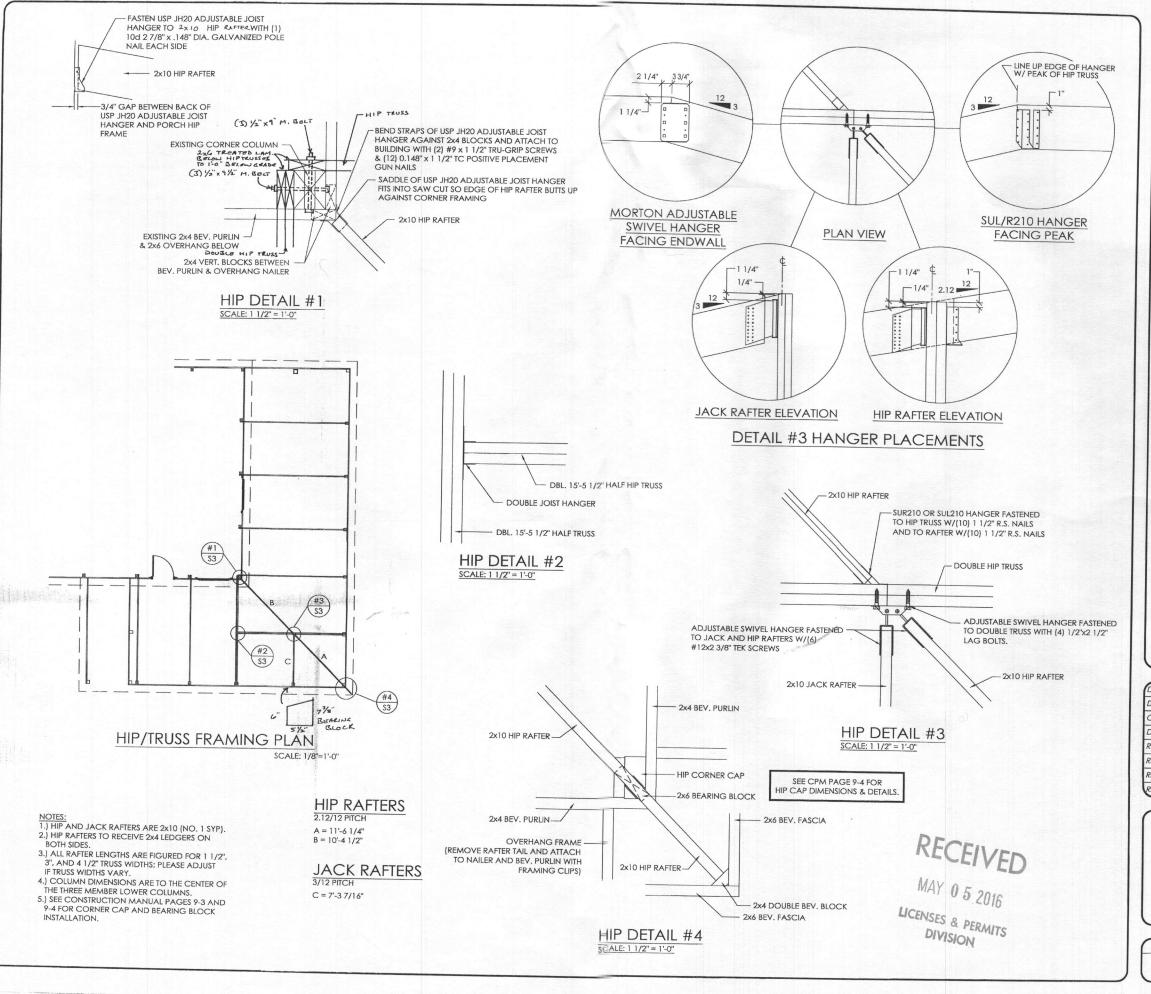SCALE:



OFFICE:
GETTYSBURG, PA

JOB NO.
064-048366



309-263-7474

S, IN

BRUCE MENZ

SYKESVILLE, MD



DRAWN BY: LB

DATE: 4/29/2015

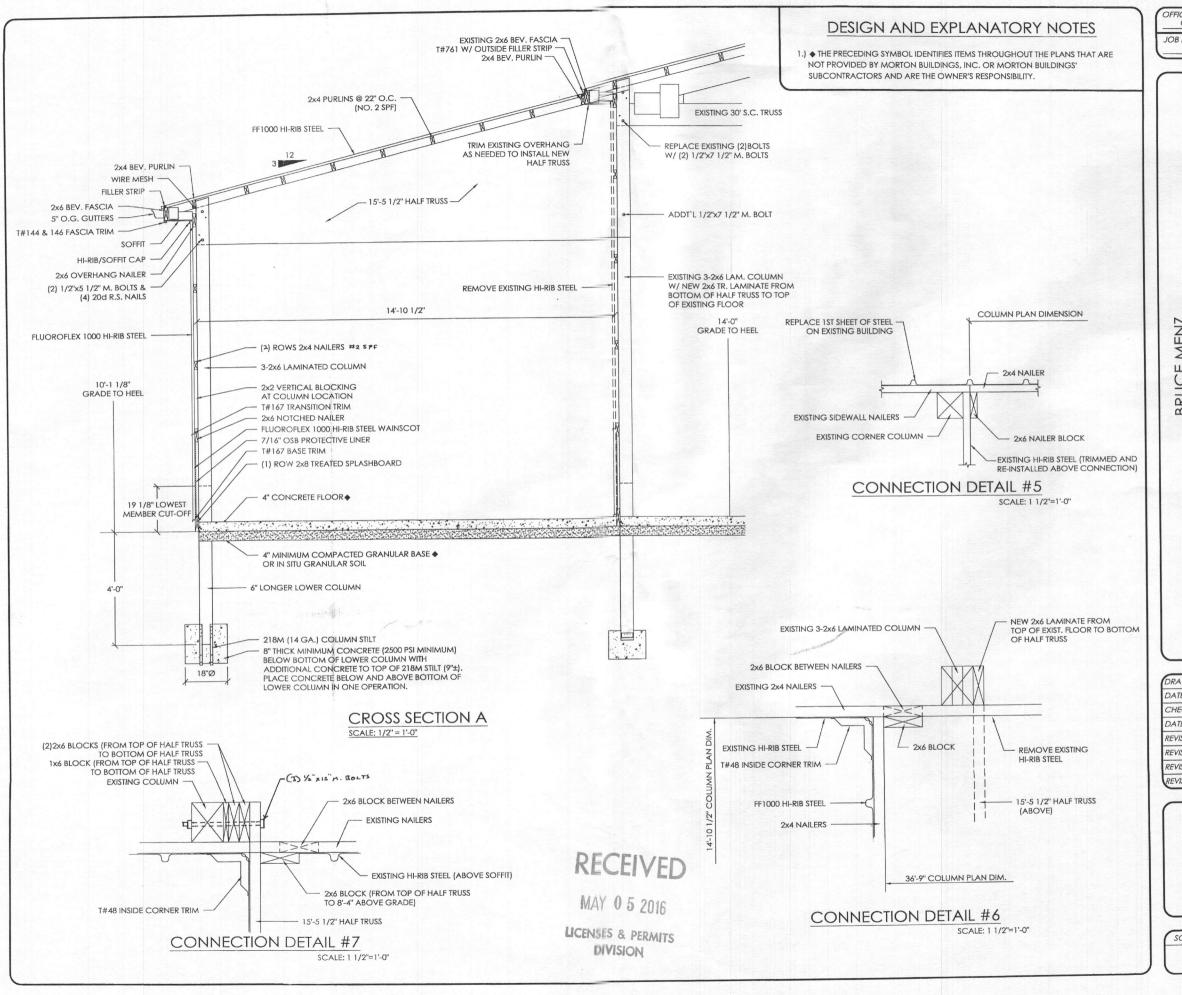
CHECKED BY: --
DATE: --
REVISED DATE: ---



SCALE: AS NOTED

SHEET NO.

S3 OF S5



OFFICE:
GETTYSBURG, PA

JOB NO.
064-048366



263-7474

5, INC 309-263-7

BRUCE MENZ

DRTON BUILDINGS,




| DRAWN BY: | LB |
|---------------|-----------|
| DATE: | 4/29/2015 |
| CHECKED BY: | _ |
| DATE: | |
| REVISED DATE: | _ |
| REVISED DATE: | _ |
| REVISED DATE: | _ |
| REVISED DATE: | |

SCALE: AS NOTED

SHEET NO.

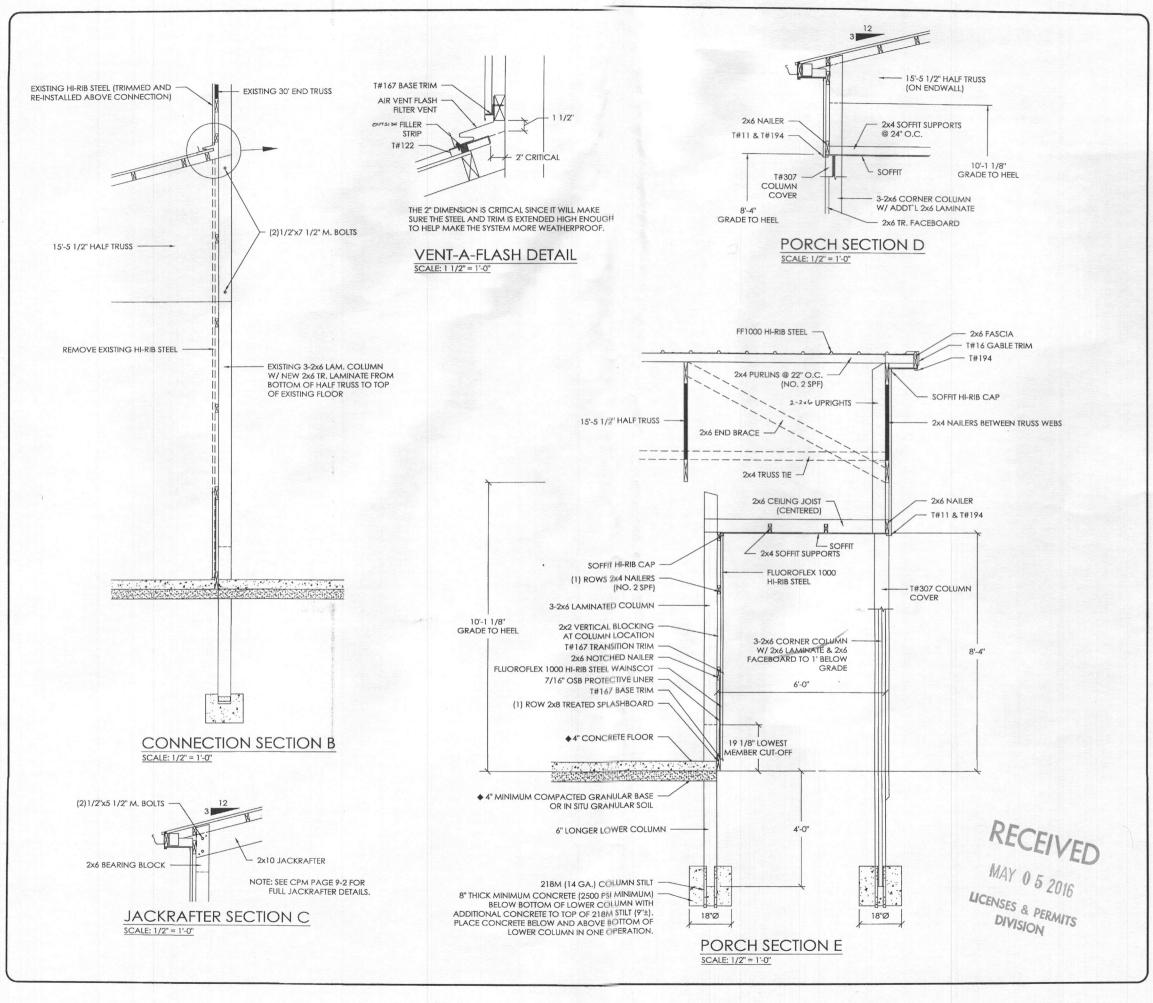\$4 OF \$5



OFFICE:
GEITYSBURG, PA

JOB NO.
064-048366




5

GS, INC

BRUCE MENZ

MORTON RII


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DATE: 4/29/2015
CHECKED BY: --DATE: --REVISED DATE: --REVISED DATE: --REVISED DATE: --REVISED DATE: ---

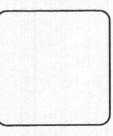

SCALE: AS NOTED

SHEET NO.

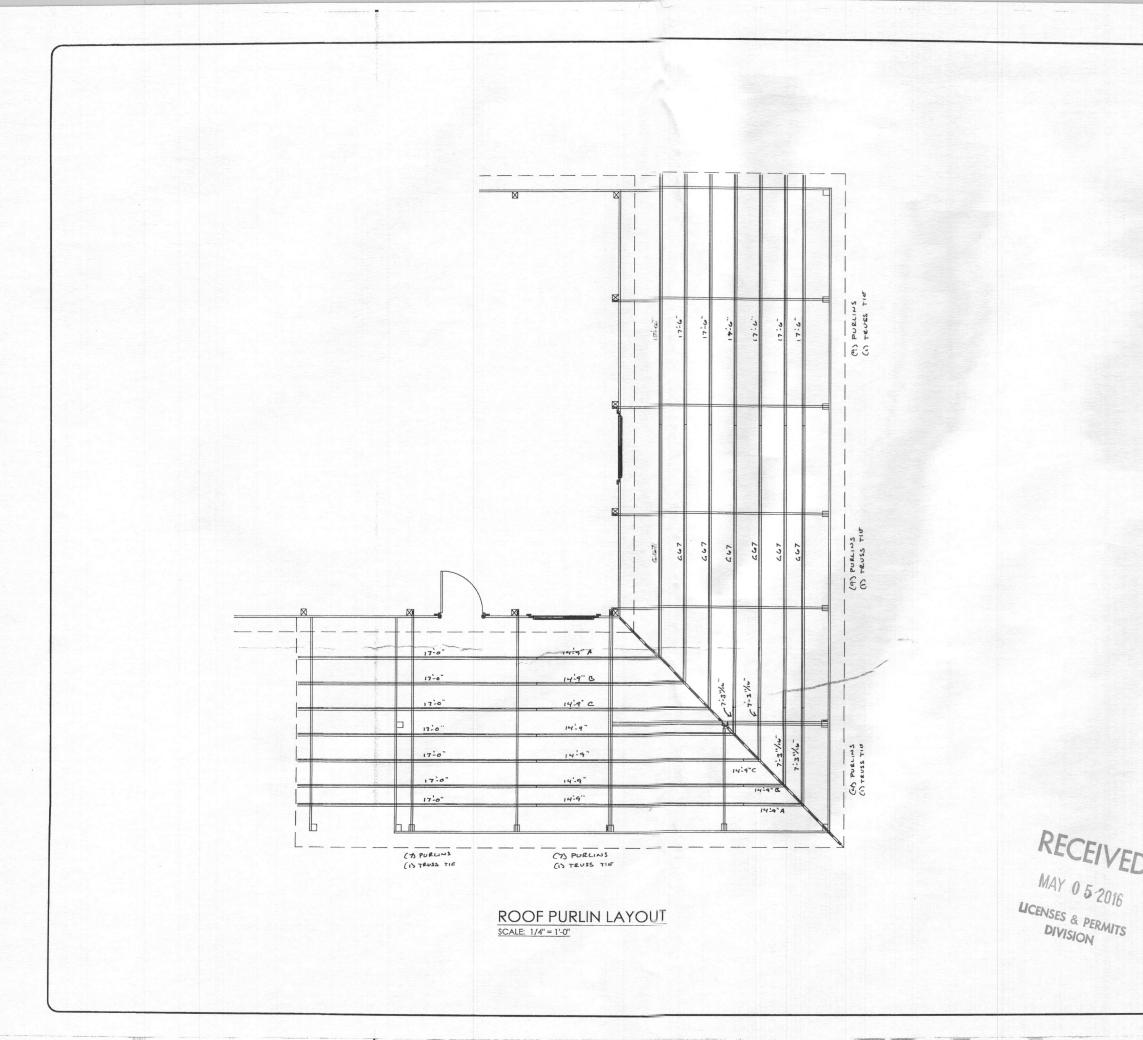\$5 of \$5



OFFICE: GETTYSBURG, PA JOB NO. 064-048366



BUILDINGS, INC.

BRUCE MENZ

MORTON BUILDINGS, INC. P.O. BOX



| DRAWN BY: | LB |
|---------------|-----------|
| DATE: | 4/29/2015 |
| CHECKED BY: | |
| DATE: | |
| REVISED DATE: | |
| REVISED DATE: | _ |
| REVISED DATE: | |
| REVISED DATE: | _ |

SCALE: AS NOTED SHEET NO. S6 OF S6

END BRACE & E.C.E./UPRIGHT CUT SHEET -- PLAIN END &/OR SLIDING DOOR END

(For 2x4 Purlins)

30 Ft. Wide (SC)

3 /12 Roof Slope

6' 0" Sidewall Corner Bay

Brace Angle Board Length Cut Length END BRACE & E.C.E. LENGTHS AT A COLUMN

(5 3/16)112

N/A

E.C.E. (Max.) 4'-10'/2" (2) F759

7' 4-1/2" End Column Location

Note* 2

END BRACE & E.C.E. LENGTHS AT JAMB COLUMNS (SLIDING DOOR #1)

Brace Angle Board Length Cut Length E.C.E. (Max.) E.C.E. (Sent)

Note*

END BRACE & E.C.E./UPRIGHT LENGTHS ABOVE SLIDING DOOR #1. DOOR HEIGHT = GTH +: 0.0 IN.

Brace Angle Board Length Cut Length

Upright (Max.) Upright (Sent)

Note*

END BRACE & E.C.E. LENGTHS AT JAMB COLUMNS (SLIDING DOOR #2)

Brace Angle Board Length Cut Length E.C.E. (Max.) E.C.E. (Sent)

Note*

END BRACE & E.C.E./UPRIGHT LENGTHS ABOVE SLIDING DOOR #2. DOOR HEIGHT = GTH +: 0.0 IN.

Brace Angle Board Length Cut Length

Upright (Max.) Upright (Sent)

Note*

*Notes

1 = Brace runs from top of column.

2 = Brace runs from 2" above top of column for clearance due to angle of brace (less than a 3/12 slope).

3A = Brace runs from bottom of sliding door track girt.

4A = Brace runs from grade to heel height for sliding door.



| | END BRACE | & E.C.E./UPRIGH | IT CUT SHEET PI | AIN END &/OF | SLIDING | DOOR END | |
|-------------------------|---------------|--|--|------------------------------------|------------|---------------------|------------|
| (For 2x4 Purlins | 3) | | | | | | |
| 30 Ft | . Wide (SC) | | 3 /12 Roof Slope | | 7' 7-1/2" | Sidewall Corner Bay | |
| END BRACE & | E.C.E. LENGTI | HS AT A COLUMN | | | | | |
| Brace Angle | | | E.C.E. (Max.) | E.C.E. (Sent) | | | Note* |
| (4 1/16) 112 | 10' | 7-113/4" | 3' 1-1/2" | F749 | 7' 4-1/2" | End Column Location | 2 |
| | | | - | - | | | |
| | | | | | | | |
| | | | | | | | |
| | | | | • | | | |
| | | | | | | | |
| | | | • | • | | | |
| | | | | | | | |
| END BRACE & Brace Angle | E.C.E. LENGTH | Sut Langth | MNS (SLIDING DOOR | | | | |
| N/A | Board Length | Cut Length | E.C.E. (Max.) | E.C.E. (Sent) | | | Note* |
| | | | | | | | |
| | | | | | | | |
| END BRACE 9 | ECE/UDDICU | T I ENCTUS ABOV | E 61 IDING DOOD #4 | DOOR DEICHT - | . CTU 0. | N. N. | |
| | Board Length | | E SLIDING DOOR #1. Upright (Max.) | | GIH+: 0.0 | J IN. | Note* |
| | | Jul Longin | Opright (Max.) | <u>oprignt (oone)</u> | | | Note |
| | | | | | | | |
| | | | | | | | |
| | | | | | | | |
| END BRACE & | E.C.E. LENGTH | IS AT JAMB COLU | MNS (SLIDING DOOR | #21 | | | |
| | Board Length | | E.C.E. (Max.) | E.C.E. (Sent) | | | Note* |
| | | | and the second s | | | | |
| | | | 425 September - 1980 Se | logiciones - es especia | | | Harris Jan |
| | | | | | | | |
| END BRACE & | E.C.E./UPRIGH | T LENGTHS ABOV | E SLIDING DOOR #2. | DOOR HEIGHT = | GTH +: 0.0 | IN. | |
| Brace Angle | Board Length | Cut Length | Upright (Max.) | | | | Note* |
| | | | | | | | |
| | | | | | | | |
| | | | | | | | |
| | | | | | | | |
| *Notes | | | | | | | |
| 1 = Brace runs fi | | | | | | | |
| | | o of column for clear sliding door track girt | ance due to angle of bre | ice (less than a 3/ | 12 slope). | | |
| | | siiding door track gin eel height for sliding | | | | | |
| | 3 3 | g.n. for onding | WV1. | | | | |



REQUIRED FOOTING WORKSHEET

(READY-MIX/STILT FOOTINGS)

Customer Name: Job Number:

MENZ 64048366

| | | | | YARDS READY | MIX |
|-----------------------------|-------------|-------------------------|--|---------------------------|-------|
| COLUMN FOOTING | G TYPE & S | SIZE | QTY. OF | UNDER & AROUND | |
| ROUND | " under | " around | FOOTINGS | EACH COLUMN | TOTAL |
| 16" dia. | 8 | 9 | Maria Maria | 0.08 | |
| 18" dia. | 8 | 9 | 15 | 0.10 | 1.50 |
| 24" dia. | 10 | 9 | | 0.20 | |
| 30" dia. | 13 | 9 | | 0.37 | |
| 36" dia. | 16 | 9 | | 0.60 | |
| 42" dia. | 20 | 9 | | 0.94 | |
| 48" dia. | 23 | 9 | | 1.33 | |
| 54" dia. | 26 | 9 | Maria de la companya | 1.83 | |
| SQUARE | | | | - | |
| 36" sqr. | 18 | 9 | | 0.79 | |
| 42" sqr. | 20 | 9 | | 1.15 | |
| 48" sqr. 23 | | 9 | | 1.66 | |
| CTR.DR.GUI | DE STUB | | | 0.08 | |
| ADJ. CTR.DR.GUIDE ST | JB 16" dia. | X4ft. deep | | 0.25 | |
| JAMB PRO | DT.(4") | | E. | 0.25 | |
| JAMB PRO | | | 84 846 | 0.33 | |
| DEADM | IEN | | | 0.25 | |
| # of different Footings for | Steel Cols | None | | | |
| | | | | | |
| | | | | | |
| | | | | | 10. |
| | | | | | |
| | | | 4.1 | | |
| VIANOVA I | | | | | |
| # of different Backfilled F | ootings - | None | | | |
| | | PONOSOP AND AND PARTIES | gija i drim Make Light Lipse by | | |
| | | | 00 | | |
| | | | | | |
| | | | 176 | | |
| | | | | | |
| | | | | | |
| | | | TOTAL Y | DS. READY MIX | 2.00 |

CONCRETE SPECIFICATIONS Concrete shall be 3000 PSI mix minimum 440 lbs cement per yard of concrete. ASTM specifications C150 must be met. Maximum cement replaced by Class C fly ash per yard is 50 lbs (replaced at 1.5 times cement removed). Aggregate must be sound crushed rock or washed gravel 1" maximum diameter. Water reducer may be added.

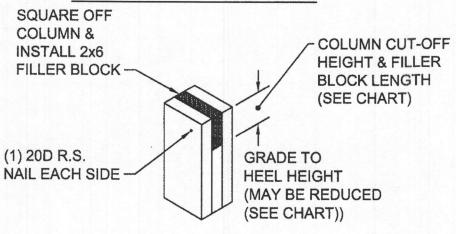
Inform the ready-mix company of a possible delay in unloading and expect additional charges for time delay of unloading.






HIP ROOF CORNER FRAMING (45° HIP)

CORNER COLUMN FILLER BLOCK



NO FILLER BLOCK

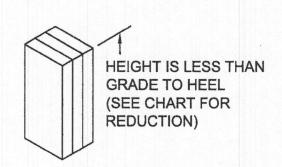

COLUMN CUT-OFF HEIGHT & FILLER BLOCK LENGTH

| RAFTER F.B./ SIZE C.C.O. | F.B./ | ROOF SLOPE | | | | | | | | | |
|-----------------------------|--------|------------|----------|----------|----------|----------|------------|----------|----------|----------|--|
| | 3/12 | 4/12 | 5/12 | 6/12 | 7/12 | 8/12 | 9/12 | 10/12 | 12/12 | | |
| 2x10 | F.B. | 3-7/8" | 3-11/16" | 3-1/2" | 3-5/16" | 3-1/16" | 2-13/16" | 2-1/2" | 2-3/16" | 2" | |
| 2810 | C.C.O. | STD. | STD. | STD. | STD. | STD. | STD. | STD. | STD. | (1/2") | |
| 2512 | F.B. | 2" | 2" | 2" | 2" | 2" | 2" | 2" | NONE | NONE | |
| 2x12 | C.C.O. | (3/16") | (3/8") | (9/16") | (13/16") | (1-1/8") | (1-7/16") | (1-3/4") | (1/8") | (15/16") | |
| 11/4 | F.B. | NONE | NONE | NONE | NONE | NONE | NONE | NONE | NONE | NONE | |
| LVL | C.C.O. | (3)" | (3-1/4") | (3-1/2") | (3-7/8") | (4-1/4") | (4-11/16") | (5-1/8") | (5-5/8") | (6-3/4") | |

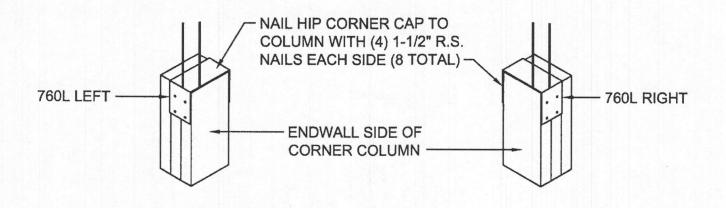
NOTES:

ALL DIMENSIONS ARE TAKEN FROM GRADE TO HEEL HEIGHT (DIM. IN () ARE BELOW STANDARD CUT-OFF. HEIGHT & ALL OTHERS ARE ABOVE STANDARD HEEL HEIGHT).

F.B. = FILLER BLOCK

C.C.O. = COLUMN CUT-OFF

760L HIP CORNER CAP INSTALLATION



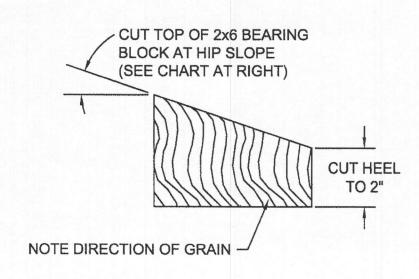
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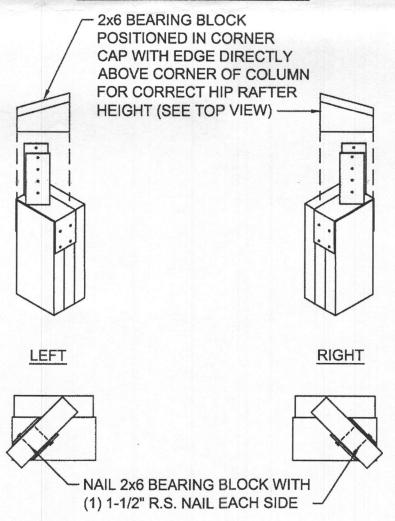
HIP ROOF CORNER FRAMING (45°)

CORNER COLUMN BEARING BLOCK



| ROOF SLOPE | HIP SLOPE |
|---------------|--------------|
| 3/12 | (2-1/8)/12 |
| 4/12 | (2-13/16)/12 |
| 5/12 | (3-9/16)/12 |
| 6/12 | (4-1/4)/12 |
| 7/12 | (4-15/16)/12 |
| 8/12 | (5-11/16)/12 |
| 9/12 | (6-3/8)/12 |
| 10/12 | (7-1/16)/12 |
| 12/12 | (8-1/2)/12 |

BEARING BLOCK INSTALLATION





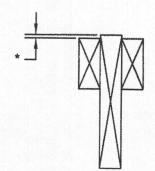
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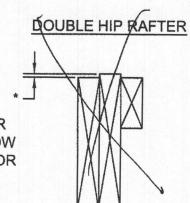
HIP ROOF LEDGERS, PURLINS & BASE TRIM

(FOR A 45° HIP ONLY)

SINGLE HIP RAFTER




*FOR A 45° HIP, POSITION (2) 2x4 LEDGERS OR 2ND HIP RAFTERS & LEDGER AT DIM. 'A' BELOW TOP OF HIP RAFTER (SEE CHART BELOW). FOR A HIP OTHER THAN 45°, 1 LEDGER MAY BE ABOVE HIP RAFTER & 1 MAY BE BELOW (SEE PLANS FOR LEDGER SETTING).




| ROOF SLOPE | 3/12 | 4/12 | 5/12 | 6/12 | 7/12 | 8/12 | 9/12 | 10/12 | 12/12 |
|------------|------|------|-------|------|-------|------|--------|-------|-------|
| DIM. 'A' | 1/4" | 3/8" | 7/16" | 1/2" | 9/16" | 5/8" | 11/16" | 3/4" | 7/8" |

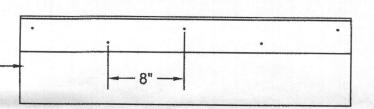LEDGER NAILING
NAIL 2x4 LEDGERS (OR 2ND HIP
RAFTER) TO HIP RAFTER WITH 10D
GUN NAILS 8" O.C., STAGGERED.—




HIP BASE V-TRIM INSTALLATION

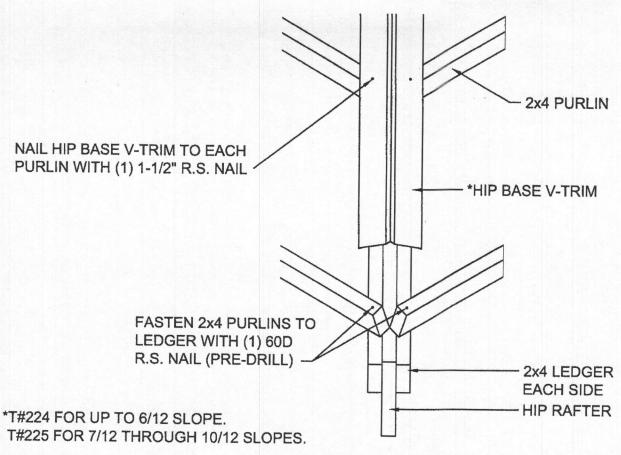

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NOTE: IF THE VENT-A-FLASH COVER IS INCLUDED YOU MUST INCLUDE THIS PAGE IN YOUR DETAILS ALSO.

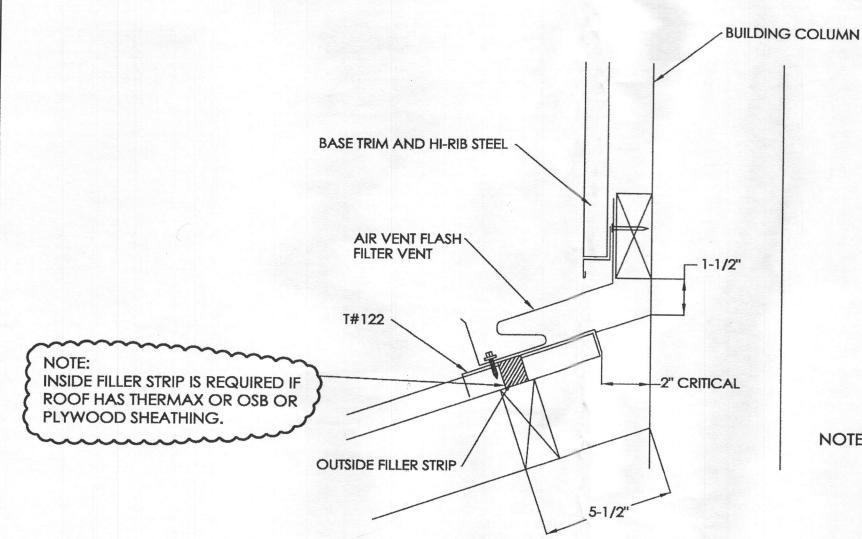THE 2" DIMENSION IS CRITICAL SINCE IT WILL MAKE SURE THE STEEL AND TRIM IS EXTENDED HIGH ENOUGH TO HELP MAKE THE SYSTEM MORE WEATHERPROOF.

LICENSES & PERMITS

VENT-A-FLASH ON STEEL HI-RIB ROOF

(STEEL HI-RIB ROOF)



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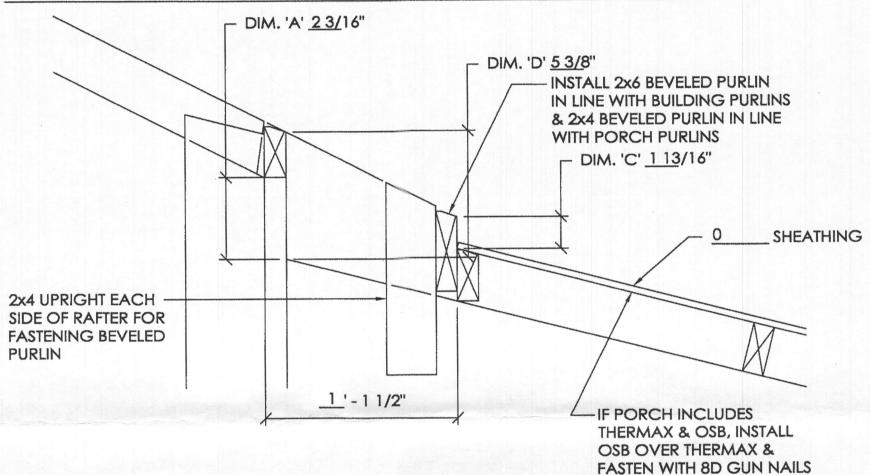
PAGE 1 OF 2 DATE: 11/07

MORTON BUILDINGS CONSTRUCTION DETAILS

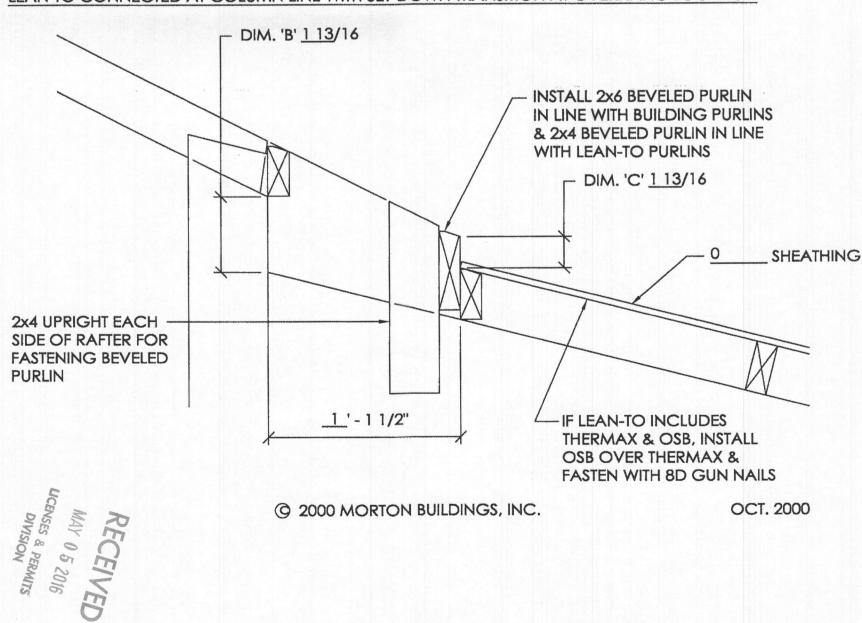
CASE 1 PORCH/LEAN-TO CONNECTION

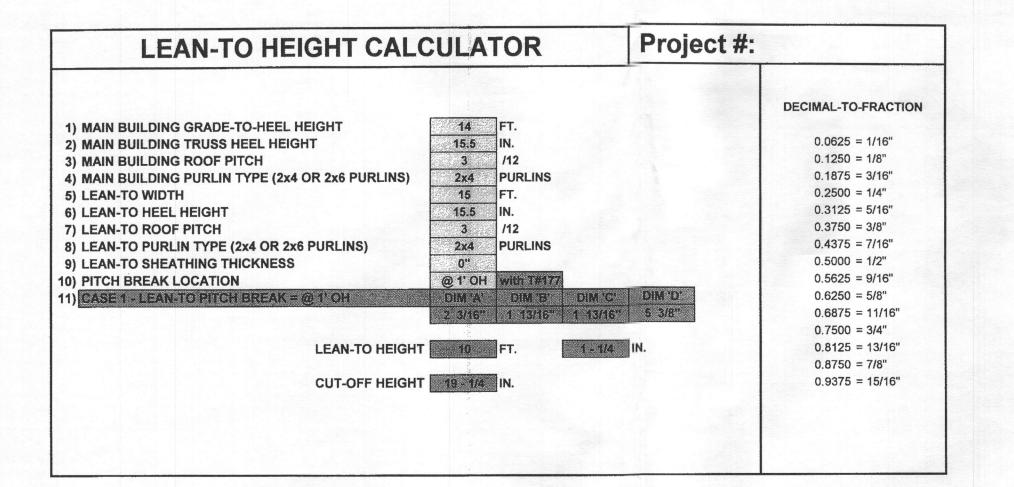
(__3__/12 BUILDING (2x4 PURLINS) TO A __3__/12 PORCH/LEAN-TO (2x4 PURLINS))

PORCH CONNECTED AT NAILER LINE WITH SET-DOWN TRANSITION AT OVERHANG LOCATION

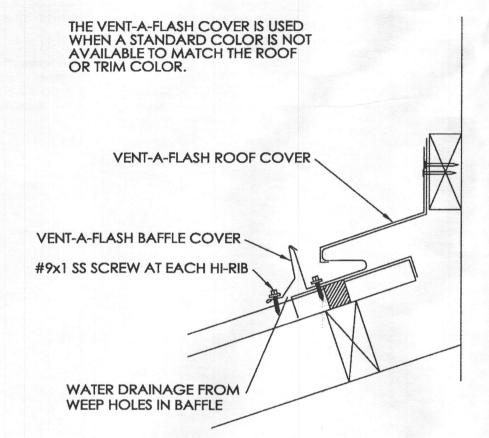


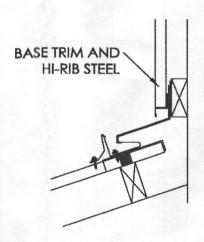
LEAN-TO CONNECTED AT COLUMN LINE WITH SET-DOWN TRANSITION AT OVERHANG LOCATION











- INSTALL THE VENT-A-FLASH SYSTEM PER STANDARD PROCEDURES.
 COVER THE ROOF WITH VENT-A-FLASH ROOF COVER. HOOK THE BOTTOM END UNDER THE LOUVERS AND FASTEN THE TOP END TO THE NAILER.
- 3. HOOK THE VENT-A-FLASH BAFFLE COVER OVER THE VENT-A-FLASH BAFFLE AND STITCH THE CRIMPED LEG TO EACH HI-RIB.

NOTE: SEE DETAIL FOR VENT-A-FLASH ON STEEL HI-RIB ROOF FOR PURLIN, STEEL, AND T#122 POSITION.

VENT-A-FLASH COVER

(STEEL HI-RIB ROOF)



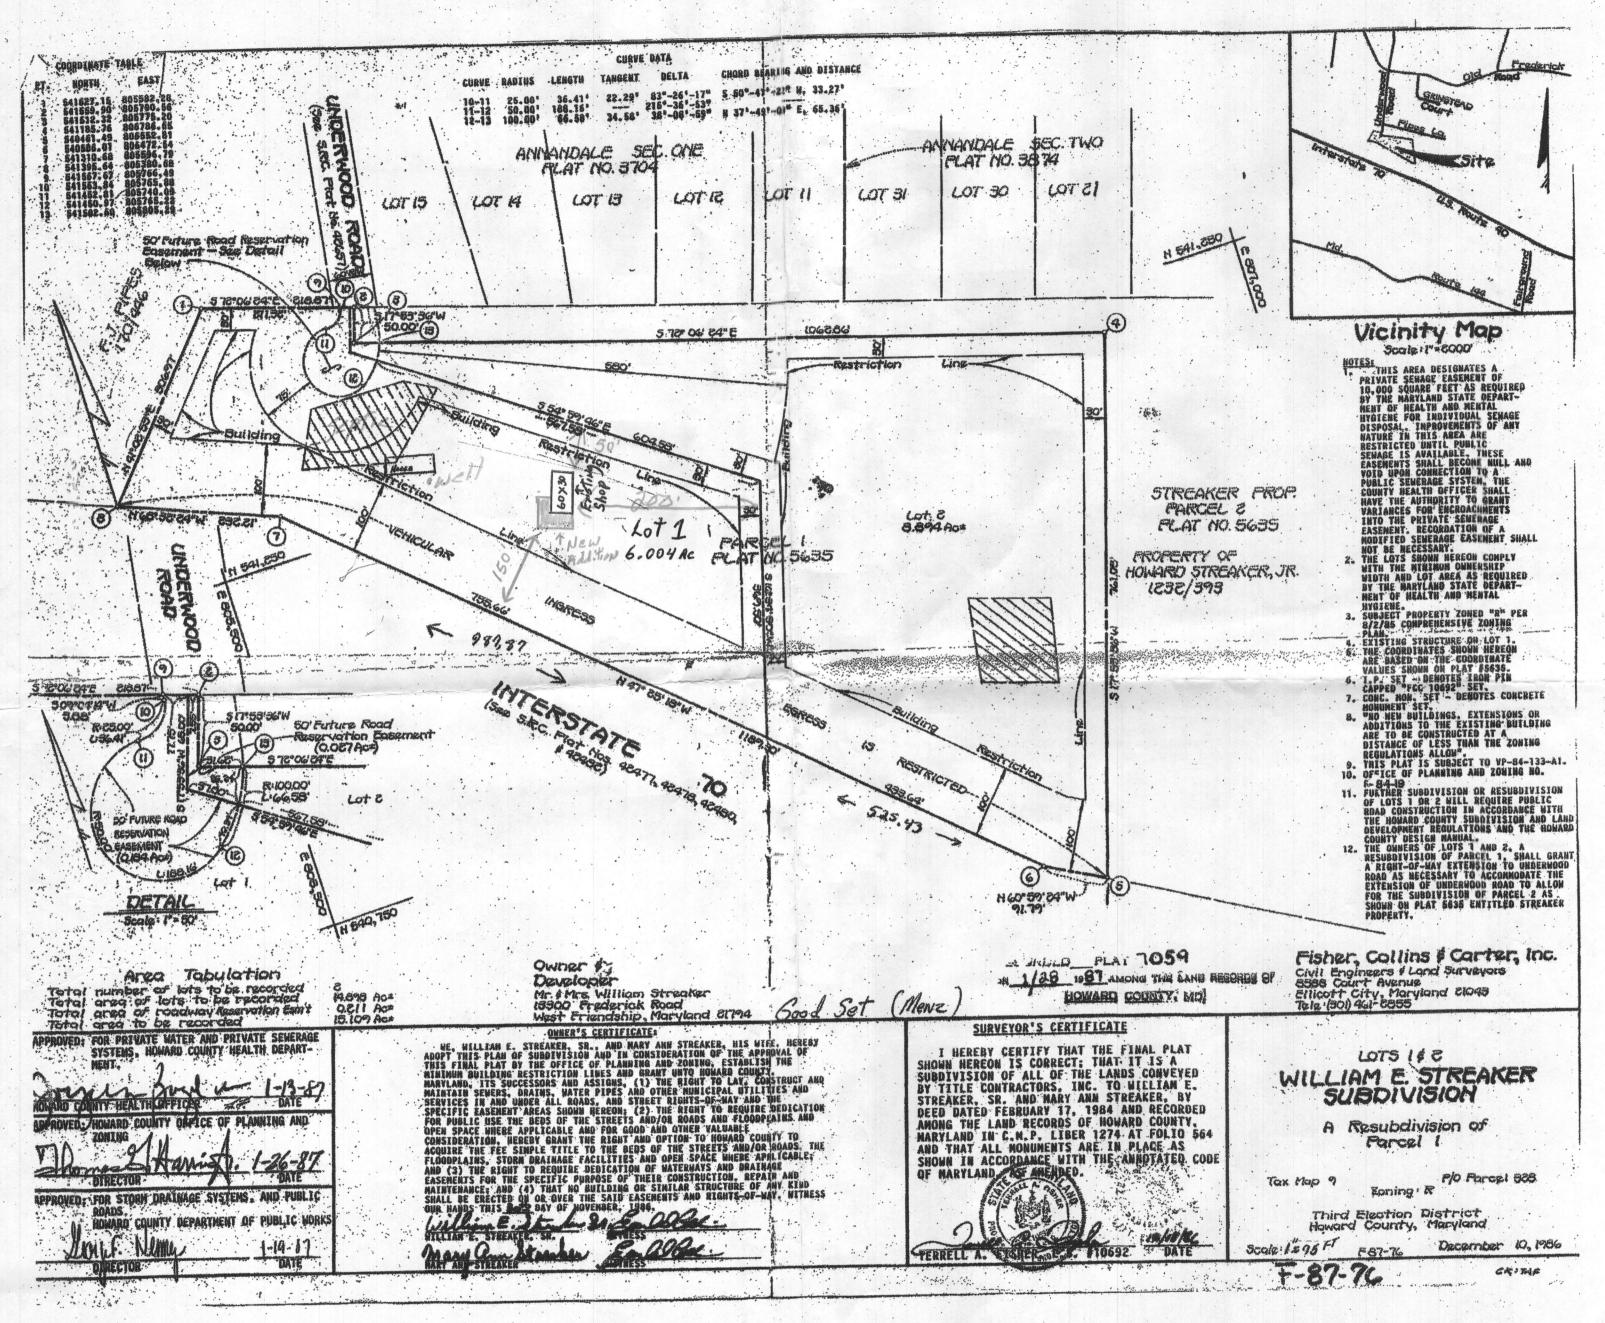
PAGE 2 OF 2

LICENSES & PERMITS



MORTON BUILDINGS, INC.

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