PERMIT NUMBER: B 2 001288

RECEIVED

APR 0 8 2021

ACCEPTED BY:



RESIDENTIAL BUILDING PERMIT APPLICATION ON

HOWARD COUNTY DEPARTMENT OF INSPECTIONS, LICENSES, AND PERMITS 3430 COURT HOUSE DRIVE, ELLICOTT CITY, MD 21043

- PHONE: (410) 313-2455 OPTION #4

		www.howard	countymd.gov	<u>/</u>			
BUILDING SITE ADD	RESS REQUIRED						
Street Address: 13001 Wa					Unit:		
City: Highland	antwright Road		State: MD			ode: 20777	
Subdivision/Village/Complex	Name:]	SDP/WP		20111	
Lot: Rev. Parcel 2	Tax Map: 40 grid 8	Parcel: 398		Grading Permit #			
THE RESIDENCE OF THE PARTY OF T	The second second	1 di cei: 330		Grading Fernite #			
DESCRIPTION OF WO		roposed Use: Artist st	dia		Ection	ated Cost: \$25,000.00	
Existing Use: Residential Trade Work to Be Completed	0			ectrical Plun		None	,
			VACK) • EIE	ctrical - Fiun	noing u	Notie	
Construction of new a	rtist studio over exist	ing garage.	40,000				
PROPERTY OWNER I	NEODMATION 85	2///050					
		QUIRED			Drims	any Residence: Vos	□ No
Owner(s) Name(s) (As it app		cier			Pilitio	ary Residence: Yes	L) NO
Owner's Street Address: 130	out wainwright Ku		State: MD		7in C	ada: 20777	
City: Highland		Email: 1:-4-			Zip C	ode: 20777	
Phone: (202) 841-6664 APPLICANT NAME	DECUTOED THOUSE		exler@gmail			702	
	REQUIRED - INDIVID	OUAL WHO SIGNS T					
Business Name: Owner	'		Contact Name	Liz Trexler			
Street Address: 13001 Wa	inwright Ka		State: MD		7in C	odo: 20777	
City: Highland		Email: Linta			Zip C	ode: 20777	
Phone: (202) 841-6664 CONTRACTOR INFOR	MATION REQUIRE		exler@gmail	.com			
Business Name: Owner	MATION REQUIRE	<i>D</i>					
Licensee's Name: Liz Trex	lor		License #:				
Street Address: 13001 Wa			License w.				
City: Highland	illiwright Nu		State: MD		Zin C	ode: 20777	
Phone: (202) 841-6665		Email: liztr	exler@gmail	com	Lzip C	ode. 20111	
ARCHITECT/ENGINE	ER INFORMATION	The second secon	The second second		UF		
Business Name:	IN IN OKNATION I	NOTITIONE WITO	Name: Micha				
Street Address: 5650 Ten	Oaks Road						
City: Clarksville			State: MD		Zip C	ode: 21029	
Phone:	-0.	Email:					
BUILDING CHARACT	ERISTICS REQUIR	ED					
Primary Structure: ■ SF Dw			Home Multi	-Family Dwelling (MF*)	Condo: ☐ Yes ■ N	10
Utilities: ■ Electric □ G	Gas Water Supply: I	□ Public ■ Private	(Well)	Sewage Disposal:	□ Public	■ Private (Septic)	
Heating System: Electric	□ Natural Gas ■ Propa	ne 🗆 Other:	F	Roadside Tree Pro	ject: 🗖 No	☐ Yes: #	
Sprinkler System: NFPA		FPA 13D □ None	Fire Alarn	m System: □ Ye	s No	□ Voice Evac	
ADDITIONAL RESIDE		N (PLEASE SELEC	CT/COMPLETE	ALL THAT APA	PLY)	į.	
Model Name & Options:							
# of Bedrooms (SF):	# of efficiency units (MF*)	: # of 1 BR (MF*):	# of 2 BR (MF*):		# of 3 BR (MF*):	
# Rooms:	# Full Baths:		# Half Baths:		# Fi	replaces:	
Garage/Carport Info: □ At	tached Garage Detacl	hed Garage Integ	ral Garage 🛘	Carport 🗖 No	one		
Basement/Foundation Info:		st & Pier 🔲 Unfinish	ned Basement	☐ Finished Base	ment: 🗖 Ful	or D Partial	
		nd Fl Width:	2 nd Fl Depth:	Bsmt	Width:	Bsmt Depth:	
Energy Method: ■ Prescript	tive D Performance D U	A Alternative	Gross Area:		sq ft Occu	piable Area:	sq ft
AGREEMENT/ DISCA	LIMER REQUIRED						
	ARD COUNTY WHICH ARE APPLICABLES THE GRANTS COUNTY OF FICIALS	LE THERETO; (4) THAT HE/SHE	E WILL PERFORM NO 1	WORK ON THE ABOVE	REFERENCED PRO TING THE WORK	PERTY NOT SPECIFICALLY DESC	CRIBED IN
FOR OFFICE USE ON	LY						
AGENCIES REQUIRED/APPR				A. A. Maria			
				H.O.	Hyens		
□ PR [□ DPZ	☐ DED		Health 5/	10/21	☐ SHA ☐ C	LID

SUBMITTAL FEES:

PAYMENT:

Oswald, Hank

From:

Oswald, Hank

Sent:

Monday, May 10, 2021 10:49 AM

To:

liztrexler@gmail.com

Subject:

B21001288_13001 Wainwright Road_Art Studio

Hi Ms. Trexler:

Good morning. I just have 2 questions about your building permit for the proposed art studio over the existing garage.

- 1.) Will the bathroom be a half or full bathroom? Page S1.01 shows a full bath w/ tub, but all other pages show a half bathroom.
- 2.) Will the art studio be used as a business or will it remain private?

Thanks in advance for your time.

Hank

Hank Oswald, L.E.H.S.
Howard County Health Department
Bureau of Environmental Health
Well & Septic Program
8930 Stanford Boulevard
Columbia, MD 21045
(410) 313 - 1786
hoswald@howardcountymd.gov

Oswald, Hank

From:

lizzie trexler < liztrexler@gmail.com>

Sent:

Monday, May 10, 2021 3:42 PM

To:

Oswald, Hank

Subject:

Fwd: B21001288_13001 Wainwright Road_Art Studio

Attachments:

Trexler(BOH Comments)-Rev Struct.pdf; Trexler(BOH Comments)-Rev Struct.pdf

[Note: This email originated from outside of the organization. Please only click on links or attachments if you know the sender.]

Mr. Oswald,

Thank you for your recent email concerning my application for a building permit. I would like to offer the following in response to your comments.

- 1. The layout shown on the architectural drawings is correct. Bathroom is a half bath. There is no need for a tub or other large wash basin as the wash sink in the studio is more than sufficient for needed cleanups, etc. I have attached revised structural plans which have been corrected to reflect the proper layout should you need them.
- 2. Studio is to be used for private, personal hobby purposes.

I hope this addresses your concerns. If you need any additional information or if you have any additional questions please let me know.

Thanks again

Liz Trexler

From: "Oswald, Hank" < hoswald@howardcountymd.gov>

Date: May 10, 2021 at 10:48:51 AM EDT

To: liztrexler@gmail.com

Subject: B21001288 13001 Wainwright Road_Art Studio

Hi Ms. Trexler:

Good morning. I just have 2 questions about your building permit for the proposed art studio over the existing garage.


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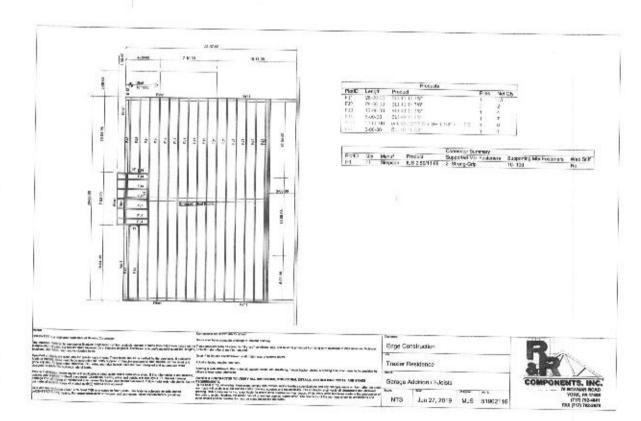
Hank Oswald, L.E.H.S.
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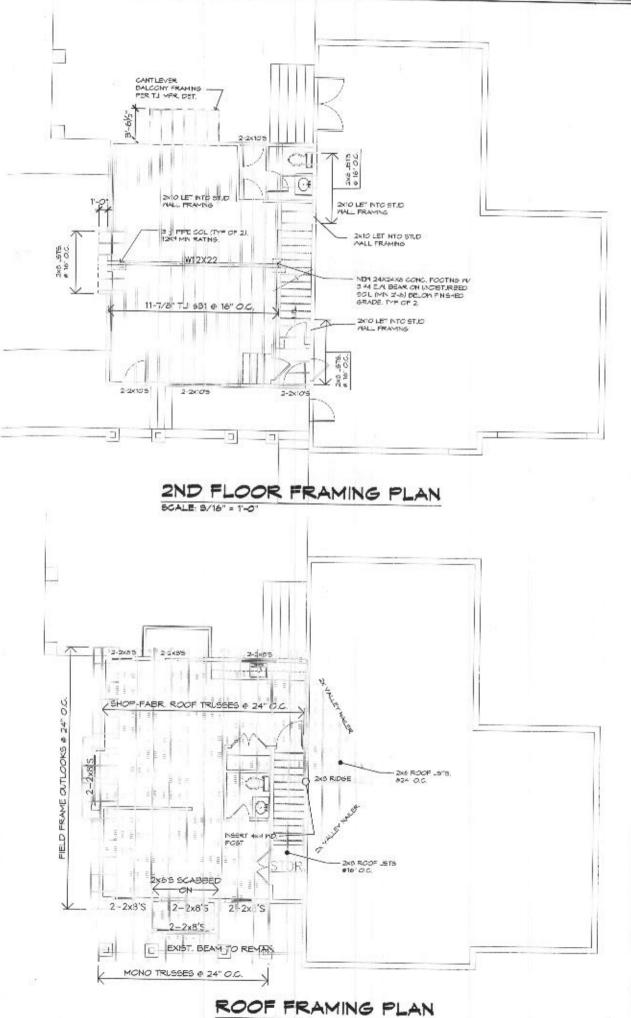
The Control of Control



ROOF TRUSS DIAGRAM



FLOOR FRAMING DIAGRAM

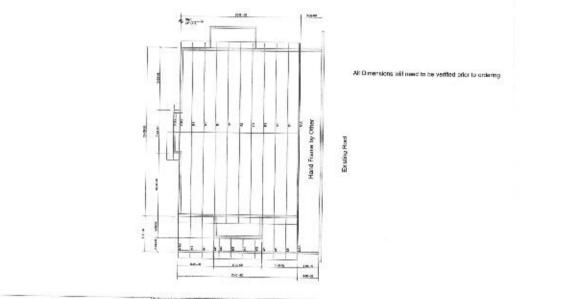

SCALE: 9/16" = 1'-0"

CONBULTANTS

ALL SQUARE




PROJECT.

TREXLER RESIDENCE

15001 MANRIGHT RO


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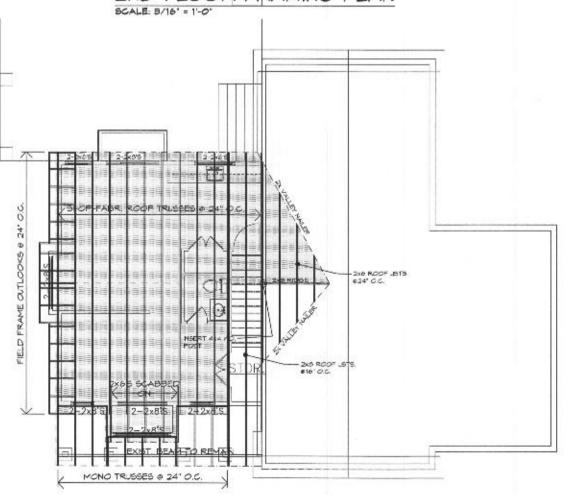
TRUSS DETAIL FRAMING

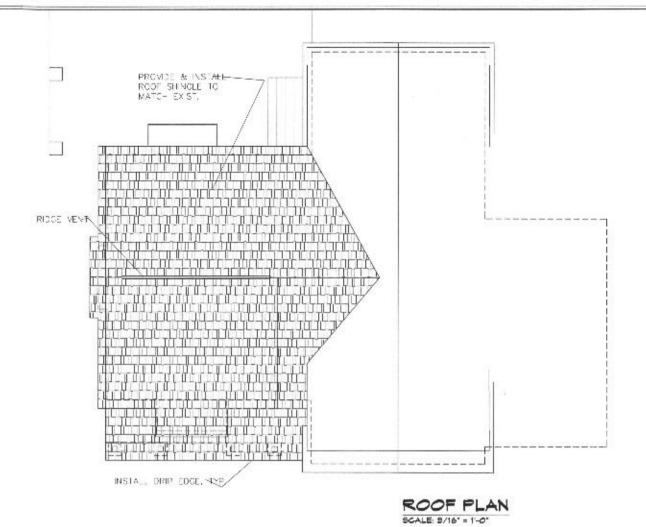

ROOF DETAIL NOTES

- 1. TYPICAL ROOF SLOPE SHALL BE 7:12 UNLESS NOTED. ROOF DORMERS SHALL BE AS NOTED ON THE PLAN.
- 2. LOOKOUTS SHALL BE 2 X 4 NOMIMAL SPACED 24" O/C AND SHALL BE PLACED WITH THE LONG DIMENSION (3 1/2") VERTICAL. ALL LOOKOUTS SHALL START AT FIRST INBOARD TRUSS AND PASS OVER THE GABLE WALL FRAMING.
- 3. ROOF SHEATHING SHALL BE 5/8" APA RATED SHEATHING AND SHALL BE PLACED WITH THE LONG DIMENSION HORIZONTAL. CLIPS SHALL BE PROVIDED AT MID SPAN BETWEEN ALL TRUSSES.
- ALL SHEATHING PANELS SHALL SPAN AT LEAST TWO SUPPORTS AND ALL PANEL EDGES SHALL BE SPACED A MINIMUM OF 48" FROM OTHER EDGES.
- 5. SHEATHING SHALL BE PLACED TO ALLOW FOR CONTINUOUS VENTILATION AT THE RIDGE.
- 6. SHEATHING SHALL OVERLAP FACIA BOARD AT ALL GABLES, EAVES AND EDGES.
 - a. ALL ROOF COVERINGS SHALL BE APPLIED IN ACCORDANCE WITH 2018 IRC AND THE MANUFACTURERS INSTALLATION INSTRUCTIONS.
 - b. APPROVED ICE BARRIERS SHALL BE PLACED AT ALL EAVES, VALLEYS, WALLS, CHIMNEYS AND VENTS PER 2018 IRC AND MANUFACTURERS RECOMENDATIONS.
 - c. ALUMINUM OR OTHER APPROVED CORROSION RESISTANT FLASHINGS AND COUNTER FLASHINGS SHALL BE PROVIDED AT ALL BASE, CAP, VALLEY, SIDEMALL, CHIMNEY, VENT AND OTHER ROOF PENETRATIONS PER CODE.
 - d. DRIP EDGES SHALL BE INSTALLED AT ALL EAVES AND RAKE EDGES.



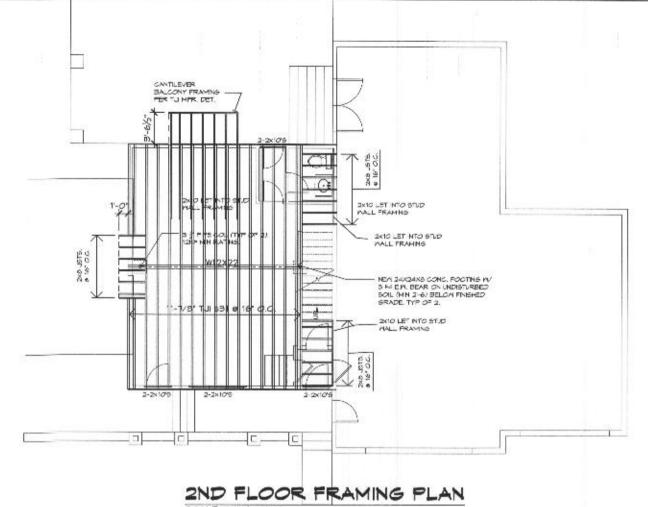

ROOF FRAMING PLAN

SCALE: B/16" = 1'-0"

CONSULTANTS:

ALL SQUARE



PROJECT

TREXLER RESIDENCE

ISOCI PANEIGHT RO

REVISIONS. CANER REVEN G2 WITH REVIEW PROJECT NO CAD DWG FILE: GARAGE ADDITION-TRINGING DRAWN BY: SNYRDLEY CHK DI BY: MAB COPYRIGHT: M SUTLER 302 FRAMING

51.01


PLAN



TE: J- .- + KS
COL: ... TIVE

ARCHITECTURE PI L: CTION MANAGEMENT

CONSULTANTS:

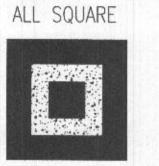

I CERTIPY THAT THESE DOCUMENTS WERE PREPARED OR APPROVED BY ME, AND THAT I AM A DULY LICENSED UNDER THE LANS OF THE STATE OF MARYLAND, LICENSE NO. 8950, EXPIRATION DATE 11-5-2020.

PROJECT:

TREXLER

CRAFTS STUDIO RENOVATIONS

13001 WAINRIGHT RD HIGHLAND, MD

REVISIONS								
MARK	DATE	DESCRIPTION						
01	1/21/19	OWNER REVIEW						
02	9/17/19	FINAL PERMIT						
03	09/15/21	PERMIT						
	Tital							
100								
1000								
	13314							

PROJECT NO: 12-045-18

CAD DWG FILE: GARAGE ADDITION-TREXLER DWG

DRAWN BY: SNYRDLEY

CHK'D BY: MAB

M BUTLER 2021

SHEET TITLE

SITE PLAN

C1.00

GENERAL NOTES

- 1. The work shall be performed in strict accordance with all applicable federal, state, and local codes and ordinances and specifically in accordance with the ordinances and requirements of the Howard County, MD.
- Mork shall include all labor, assemblies, and finish work including all parts and materials necessary to make a complete, in-place, properly working and finished installation.
- All work shall be carried out in accordance with accepted first-class construction practices.
- All materials used in the construction of the improvements indicated herein shall be new unless otherwise approved by the Owner.
- 5. The Contractor shall schedule work to avoid interruptions to the ongoing normal operations elsewhere on the property. All disruptive work shall be scheduled and coordinated with the Owner.
- 6. Work shall be protected at all times to preclude damage by persons or weather. All damaged work shall be restored to a new condition before final acceptance. Any part of the existing building defaced, removed or altered in accomplishing the work under this contract shall be replaced or repaired to match the surrounding area in texture, color, finish and dimensions.
- 7. The contractor shall examine the drawings, specifications and visit the job site and fully inform himself of all existing conditions and work required by the drawings and specifications before submitting his bid. The Contractor shall also include in their bid any additional Items of construction that may be required due to existing site conditions whether or not indicated on the drawings. Maiver of responsibility or request for additional payment based on lack of knowledge of existing conditions at the site will not be accepted or considered.
- 8. Contractor shall field measure all distances and clearances prior to commencement of new work or ordering materials. Any deviations to the contract documents shall be reported to the Owner prior to proceeding with that portion of work. Drawings are not to be scaled for dimensions or sizes. Verify all dimensions in the field.
- 9. Prior to proceeding with any work that may result in additional cost or additional time to the project, the Contractor shall determine the additional cost or time (or if the exact cost or time cannot be determined, the Contractor shall make his most reasonable estimate and an estimate of the worst case) and submit the additions to the Owner for approval. Should the Contractor fall to advise the Owner prior to proceeding with the work, additional cost or time will not be approved.
- 10. This contractor shall coordinate all his work with the Owner for the exact location of chases, furring spaces, dropped ceilings, structure penetrations, painting, etc.
- 11. All dimensions are to be stud face of partitions, face of masonry, face of concrete or centerline of structural steel, unless otherwise noted.
- 12. All dimensions and descriptions on construction drawings are complementary. Any work shown or referred to on any construction document shall be provided as though required by all related documents. Most stringent requirements shall apply. Any discrepancies between the drawings shall be clarified with the Owner before proceeding.
- 13. The contractor shall secure and pay for all permits (excluding building permit), fees, licenses and inspections necessary for a proper completion of all work required by these documents.
- 14. All equipment and materials shall be installed in strict conformance with the manufacturer's recommendations.
- 15. All notes on the drawings shall be assumed to be typical unless otherwise noted on the drawings or specifications.
- 16. Do not alter, load or penetrate the existing structure in any manner which may comprise its integrity.
- 17. All surfaces are intended to be finished unless otherwise noted on the drawings or specifications. Any surface not clearly defined or indicated to be finished in the finish schedule shall be of the same material and finish as surfaces of areas of similar use elsewhere in the project.
- 18. Clean-up: Remove all construction debris daily and as required to maintain a clean environment and to prevent the possibility of accident or fire. Coordinate all removal work with Owner if required.
- 19. Contractor shall paint all new wall surfaces to match existing wall color. Where the blending of old and new finishes occurs in the middle of a single plane paint all surfaces, new and existing, where work has occurred to nearest corner or break.
- 20. After completion of project and immediately prior to final inspection of the work, Contractor shall clean all new and existing surfaces of dust, debris, loose construction material and equipment.
- 21. Remove all construction debris daily and as required to maintain a clean environment and to prevent the possibility of accident or fire. Coordinate all removal work with Owner.
- 22. This contractor shall guarantee the entire installation to be free from defects for one year from the date of acceptance by the owner. Any defects occurring during the guarantee period shall be corrected at no additional cost to the owner.

TREXLER RESIDENCE

13001 WAINWRIGHT RD, HIGHLAND, MD

PROPOSED SCOPE OF WORK

REMOVE EXTG GARAGE ROOF AND CONSTRUCT NEW SECOND LEVEL TO CONTAIN AN ARTS AND CRAFTS STUDIO. NEW SPACE SHALL BE FULLY CONDITIONED UTILIZING EXTG HVAC UNIT IN THE GARAGE. ELECTRIC SERVICES TO BE PROVIDED FROM EXISTING SERVICE GARAGESERVICE PANELS.

PROJECT INFORMATION

BUILDING CODE INFORMA	TION		
CONTROLLING CODES		Edition	
INT'L BUILDING CODE	IBC	2018	
INT'L RESIDENTIAL CODE	IRC	2018	
INT'L MECHANICAL CODE	IMC	2018	
INT'L ENERGY CONSER'N C	IECC	2018	
LIFE SAFETY CODE	LSC	2018	
USE GROUP		R	
TYPE OF CONSTRUCTION		5 B	
BUILDING AREA			
Existing Structure	SF	2,136	

PROJECT DESIGN CRITERIA

< 115 MPH

SEVERE

30"

MDD-HEAVY

SLIGHT

+ 13° F

YES

2,500 PSF

L/D PSF

100/40

40/12

30/10

20/10

7-Oct

30/15

60/15

40/10

DESIGN A

L/180

L/240

H/180

L/360

L/240

L/120

MAX ALLOWABLE LOT COVERAGE

ACCESSORY BUILDING

RR District over 2 ac

GENERAL

WIND SPEED

. TOPOGRAPHIC EFFECTS

. WIND BORNE DEBRIS ZONE

. SPECIAL WIND REGION

SUBJECT TO DAMAGE FROM

SEISMIC CATEGORY

. WEATHJERING

. FROST DEPTH

ENERGY CLIMATE ZONE

ICE BARRIER UNDERLAY REQ'D

MEAN ANNUAL TEMPERATURE

SOIL CLASSIFICATION DATA

ASSUMED BEARING CAPACITY

ROOMS (OTHER THAN SLEEPING)

INTERIOR WALLS AND PARTITIONS

FLOORS AND PLASTERER CEILINGS

ALL OTHER STRUCTURAL MEMBERS

. WITH PLASTER OR STUCCO FINISH

WINTER DESIGN TEMP

. TERMITE

FLOOD HAZARDS

AIR FREEZING INDEX

STRUCTURAL LOADS

SLAB ON GRADE

SLEEPING ROOMS

STAIRS

DECKS

BALCONIES

DEFLECTION

RAFTERS

. SLOPE > 3/12

. SLOPE < 3/12

EXTERIOR WALLS


. WITH BRITTLE FINISH


. WITH FLEXIBLE FINISH

ATTIC WY STORAGE

ATTIC WO STORAGE

. DECAY

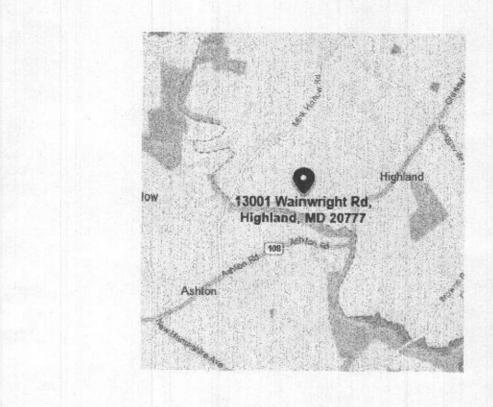

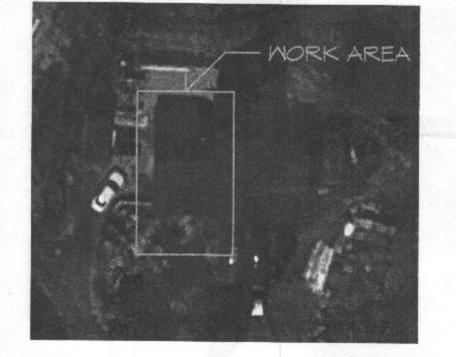

VICINITY MAP

SATELITE VIEW

SYSTEMS

PROPOSED CONSTRUCTION

OUTLINE SPECIFICATIONS

FLOOR SYSTEM

1. PRE- ENGINEERED 11 7/8" JOISTS @ 16" OIC RATED FOR SPANS INDICATED ON THE DRAWING. TJI OR EQUAL.
2. 3/4" TONGUE AND GROOVE ADVANTECH PANELS GLUED AND FASTENED TO JOISTS INSTALLED PER

MANUFACTURERS REQUIREMENTS
3. MINIMUM R-38 FIBERGLASS INSULATION

MALLS

1. EXTERIOR WALLS-


- a. 2X6 CONSTRUCTION
- b. 1/2" EXTERIOR SHEATHING APPLIED CONTINUOUSLY
- TO FRAMING.
 c. AIR/MOISTURE BARRIER PER CODE
- d. MINIMUM R-20 FIBERGLASS INSULATION
- e. 30 YEAR FIBER CEMENT LAP SIDING
- 2. INTERIOR WALLSa. 2X4 CONSTRUCTION @ COMMON INTERIOR
- b. 2X6 CONSTRUCTION @ STAIRWAY
- c. 1/2" GMB EACH SIDE (5/8X @ STAIRMAY)

ROOF

- PRE-ENGINEERED WOOD TRUSSES SPACED 24" O/C.
 ROOF SHEATHING MINIMUM 5/8" APA RATED SHEATHING.
- 3. LOOKOUTS SHALL BE 2 X 4 (LLV) NOMIMAL SPACED 24"
 OIC
- MINIMUM R-38 FIBERGLASS INSULATION
 ARCHITECTURAL GRADE 30 YEAR ASPHALT SHINGLES.
- 6. ALUMINUM GUTTERS AND DOWNSPOUTS

WINDOWS & DOORS

- 1. ANDERSON SERIES 400 MINDOMS
- 2. SAFETY GLAZED WHERE REQUIRED.

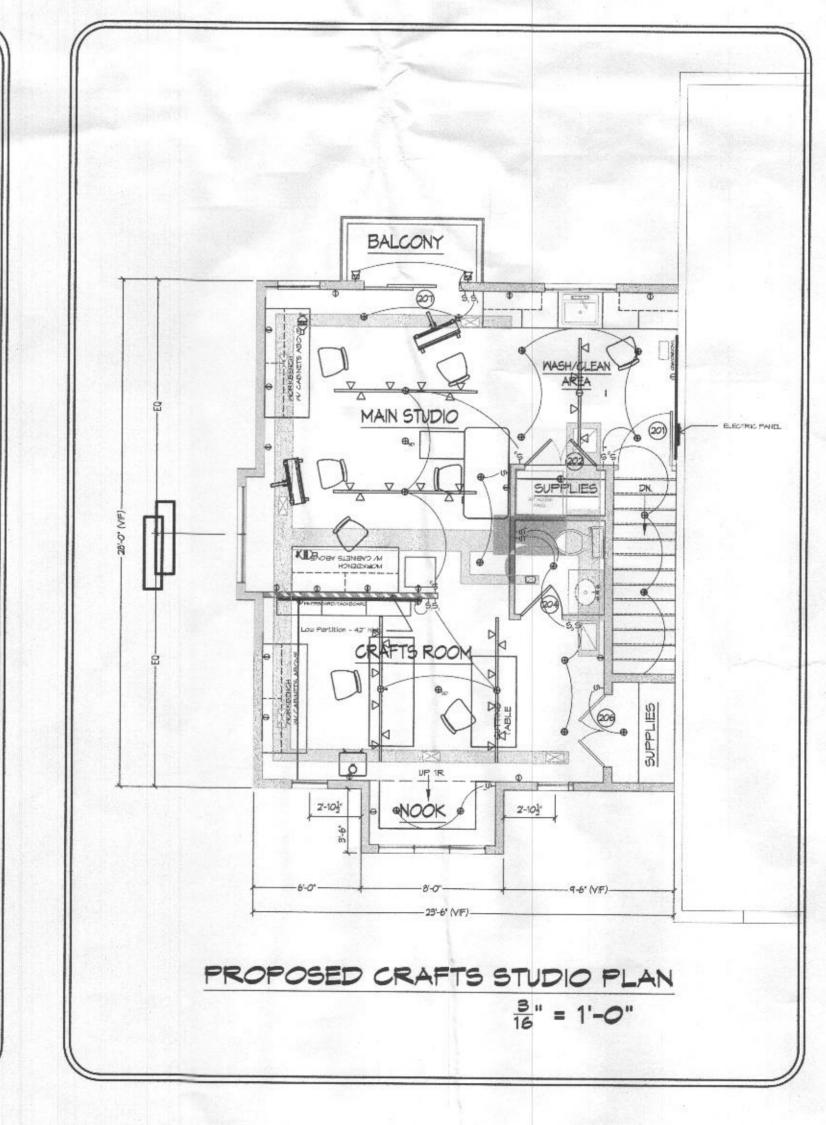


TENOAKS

240.876-4295 410-531-5037 (F)

CONSULTANTS:

ALL SQUARE

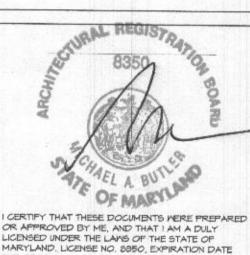

PROJECT:

TREXLER

CRAFTS STUDIO RENOVATIONS
13001 WAINRIGHT ROAD

HIGHLAND, MD

REVISIONS

MARK DATE DESCRIPTION

01 1/21/19 OWNER REVIEW 02 3/17/19 FINAL REVIEW 03 9/17/19 PERMIT PROJECT NO: 12-045-18 CAD DWG FILE: GARAGE ADDITION-TREXLER DWG DRAWN BY: SNYRDLEY CHK'D BY: MAB M BUTLER 2019 COPYRIGHT:

SHEET TITLE

PROJECT

A1.00



Plot Date: 03/15/21

GENERAL NOTES:

- REFER TO THE ARCHITECTURAL DRAWINGS FOR ADDITIONAL SLEEVES, ANCHORS, OPENINGS ETC. NOT SHOWN ON THE STRUCTURAL PLANS.
- 2. ALL MATERIALS SHALL BE IN CONFORMANCE WITH THE LATEST EDITION OF THE ASTM SPECIFICATIONS NOTED IN THE STRUCTURAL NOTES BASED ON THE DATE NOTED ON THE CONSTRUCTION DOCUMENTS.
- 3. THIS PROJECT HAS BEEN DESIGNED FOR THE WEIGHTS OF THE MATERIALS INDICATED ON THE DRAWINGS AND FOR THE LIVE LOADS INDICATED IN THE DESIGN DATA ABOVE. IT IS THE CONTRACTOR'S RESPONSIBILITY TO PROVIDE ADDITIONAL SHORING AND BRACING FOR THE STRUCTURE IF ACTUAL CONSTRUCTION LOADS EXCEED THE DESIGN LOADS.
- 4. ALL DIMENSIONS AND NOTES SHALL SUPERCEDE ALL SCALE REFERENCES ON THE
- 5. ALL WORK SPECIFIED HEREIN SHALL BE INSPECTED IN ACCORDANCE WITH THE CURRENT BUILDING CODE AND ALL LOCAL ORDINANCES.
- 6. UNLESS OTHERWISE NOTED, ALL REFERENCES TO THE CONTRACTOR APPLY TO THE GENERAL CONTRACTOR AND TO ALL SUBCONTRACTORS.
- 7. THIS PROJECT IS SUBJECT TO SITE VISITS BY THE ARCHITECT WHEN REQUESTED BY THE ARCHITECT'S CLIENT.
- 8. THE CONTRACTOR SHALL COMPLY WITH ANY EXISTING STATE AND APPLICABLE COUNTY OR CITY REGULATIONS AND LEGISLATION REGARDING THE CONTROL OF POLLUTION AS IT APPLIES TO THE WORK.

CONTRACTOR RESPONSIBILITIES:

- ALL MATERIALS, CONSTRUCTION TECHNIQUES AND PRACTICES IN ARCHITECTURAL, STRUCTURAL, MECHANICAL, PLUMBING, FIRE PROTECTION, AND ELECTRICAL WORK SHALL CONFORM TO THE APPLICABLE CODES AND REGULATIONS OF THE STATE AND IT'S LOCAL JURISDICTION AS WELL AS ALL APPLICABLE INDUSTRY STANDARDS
- 2. PERMITS AND TESTS: THE CONTRACTOR SHALL OBTAIN AND PAY FOR ALL REQUIRED PERMITS AND TEST IN CONJUNCTION WITH THE PROJECT.
- INSURANCE: THE CONTRACTOR SHALL OBTAIN AND PAY FOR INSURANCE COVERAGE FOR THE PROTECTION OF LIFE AND PROPERTY.
- 4. CLARIFICATION: IF THE CONTRACT DRAWINGS ARE FOUND TO BE UNCLEAR, AMBIGUOUS, OR CONTRADICTORY, THE CONTRACTOR MUST REQUEST CLARIFICATION FROM THE ARCHITECT BEFORE PROCEEDING WITH THAT PART OF THE PROJECT WORK.
- 5. BEFORE SUBMITTING TO BID, THE CONTRACTOR SHALL VISIT THE PREMISES AND BECOME FAMILIAR HIMSELF WITH THE EXISTING CONDITIONS AND THE EXTENT OF WORK REQUIRED TO COMPLETE THE PROJECT.
- THE CONTRACTOR SHALL PROTECT FROM DAMAGE ALL ADJACENT AREAS AND PROPERTIES.
- THE CONTRACTOR SHALL SUBMIT SAMPLES OF THE FINISH MATERIALS FOR APPROVAL
- CONTRACTOR, SUBCONTRACTORS AND MATERIAL SUPPLIERS SHALL VERIFY ALL
- DIMENSIONS AND CONDITIONS AT THE SITE. THE WORK PRESENTED IN THIS SET OF PLANS REPRESENTS COMPLETION OF THE BUILDING AS SHOWN IN ITS ENTIRETY. CONTRACTOR SHALL BE RESPONSIBLE FOR OBTAINING ALL
- BUILDING & OCCUPANCY PERMITS RELATED TO THIS PROJECT AND ITS COMPLETION. 10. THE CONTRACTOR SHALL PERFORM ALL WORK AS SHOWN ON THE DRAWINGS AND SHALL BE RESPONSIBLE FOR ALL WORK.
- 11. ALL WORK SHALL COMPLY WITH THE INTERNATIONAL RESIDENTIAL CODE, 2015, AND WITH LOCAL AMENDMENTS
- 12. ALL WORK SHALL COMPLY WITH THE LATEST EDITION OF THE LIFE SAFETY CODE (NFPA #101), LOCAL AND STATE FIRE CODES AND LATEST IRC 2015.
- 13. DEMOLITION AND REMOVAL AS REQUIRED SHALL BE DONE BY THE CONTRACTOR. 14. CONTRACTOR SHALL MOVE DEBRIS, MATERIALS, ETC. TO ALLOW ADEQUATE ACCESS TO
- OTHER SUBCONTRACTORS. 15. CONTRACTOR SHALL PROVIDE A TEMPORARY DUMPSTER FOR TRASH REMOVAL THROUGHOUT CONSTRUCTION.
- 16. CONTRACTOR SHALL PROPERLY DISPOSE OF ALL DEBRIS IN ACCORDANCE WITH LOCAL ORDINANCES & REGULATIONS.

GENERAL CONSTRUCTION DATA & NOTES

DESIGN LOADS	LIVE	DEAD
FIRST FLOOR	40 psf	10 psf
SECOND FLOOR	30 psf	10 psf
ATTIC	20 psf	10 psf
ROOF	30 psf	10 psf
DECK/BALCONY	40 psf	10 psf

LUMBER:

 LUMBER SHALL COMPLY WITH THE REQUIREMENTS OF THE AMERICAN INSTITUTE OF TIMBER CONSTRUCTION AND THE NATIONAL FOREST PRODUCTS ASSOCIATION'S NATIONAL DESIGN SPECIFICATION FOR WOOD CONSTRUCTION. LUMBER FOR JOISTS, RAFTERS, BEAMS, POSTS, STUD BEARING AND EXTERIOR STUD WALLS SHALL BE SOUTHERN PINE #2 OR APPROVED EQUIVALENT WITH THE FOLLOWING MINIMUM REQUIREMENTS:

fb = 1250 psi

fv = 175 psi

fc = 565 psi (PERPENDICULAR TO GRAIN)

E = 1,600,000 psi MAXIMUM MOISTURE CONTENT = 19%, KILN DRIED.

2. PLYWOOD SHALL BE EXTERIOR GRADE, IDENTIFIED WITH THE APA GRADE-TRADEMARK OF THE AMERICAN PLYWOOD ASSOCIATION, AND SHALL BE INSTALLED IN ACCORDANCE WITH APA LISTED SPAN RATING AND THE PROJECT SPECIFICATIONS.

WOOD FRAMING:

1. STUD BEARING AND EXTERIOR STUD WALLS SHALL BE CONTINUOSLY BRIGDED WITH WOOD BLOCKING AT MID-HEIGHT (BETWEEN FOOR AND CEILING). ALL DOUBLE STUDS SHALL BE NAILED TO EACH OTHER AT 8 INCH MAXIMUM SPACING, FULL HEIGHT. BRACE EXTERIOR BUILDING CORNERS IN STUD WALLS WITH DIAGONALLY PLACED METAL STRAPS OR PLYWOOD SHEATHING NAILED OR SCREWED TO STUDS.

ROOF TRUSSES:

- ROOF TRUSSES SHALL BE DESIGNED BY THE TRUSS MANUFACTURER FOR THE SPAN, CONFIGURATION AND LOADING CONDITIONS INDICATED ON THE DRAWINGS. SUBMIT COMPLETE SHOP DRAWINGS AND CALCULATIONS INCLUDING TRUSS LOADING DIAGRAMS. FRAMING PLANS, BEARING, BRIDGING AND CONNECTION DETAILS FOR REVIEW PRIOR TO FABRICATION OF TRUSSES. IN LIEU OF STRESS DIAGRAMS MANUFACTURER'S TEST DATA MAY BE SUBMITTED SHOWING THE ALLOWABLE CAPACITY OF THE MEMBERS. SEE THE "CONTRACTOR RESPONSIBILITIES" AND "SUBMITTAL" NOTES FOR ADDITIONAL
- 2. THE DESIGN AND DETAIL OF ALL TRUSSES SHALL MEET THE REQUIREMENTS OF F.H.A. G4541.1 DESIGN CRITERIA FOR TRUSSED RAFTERS, THE "NATIONAL SPECIFICATION FOR STRESS GRADE LUMBER AND ITS FASTENINGS", AND ALL APPLICABLE BUILDING CODES.
- 3. ROOF TRUSSES SHALL BE FABRICATED WITH TOOTHED METAL PLATES DESIGNED AND INSTALLED PER THE TRUSS PLATE INSTITUTE SPECIFICATIONS. TRUSSES SHALL BE FABRICATED WITH HYDRAULICALLY PRESSED, 16 GAUGE, TOOTHED METAL PLATES OR 20 GAUGE, STEEL GUSSET NAILING PLATES. ALL CONNECTIONS SHALL BE CAPABLE OF TRANSMITTING THE DESIGN STRESSES PLUS ALL ECCENTRICITIES.
- 4. ALL ROOF TRUSSES SHALL BE CONNECTED TO TOP PLATES WITH APPROVED HURRICANE
- 5. DESIGN OF HURRICANE CLIPS BASED ON TRUSS REACTIONS IS THE RESPONSIBILITY OF THE WOOD TRUSS MANUFACTURER AND SPECIALTY ENGINEER.
- 6. THE HURRICANE CLIP DESIGN MUST ACCOMMODATE A 300 POUND PER LINEAL FOOT WIND LOAD LATERAL REACTION ALONG THE TOP OF WALLS.
- THE ROOF TRUSS IS CONSIDERED A SYSTEM AND STABILITY OF THE ROOF TRUSS SYSTEM ABOVE THE ELEVATION OF THE TRUSS SUPPORTS IS THE RESPONSIBILITY OF THE ROOF TRUSS MANUFACTURER. TRUSS MANUFACTURER IS RESPONSIBLE FOR THE DESIGN AND DETAILING OF ALL TEMPORARY AND PERMANENT BRIDGING REQUIRED FOR THE STABILITY OF THE ROOF TRUSS SYSTEM.
- 8. WHERE MULTIPLE TRUSSES ARE INDICATED ON THE DRAWINGS OR REQUIRED BY THE TRUSS ENGINEER, THE TRUSSES SHALL BE MECHANICALLY FASTENED OR NAILED TO EACH OTHER IN ORDER FOR THE GIRDER MEMBERS TO SHARE THE SUPERIMPOSED LOADS INCLUDING LOADS FROM HEADERS FRAMING INTO THE GIRDER.
- THE ROOF TRUSSES SHALL NOT BE CUT OR DRILLED UNLESS SO AUTHORIZED, IN WRITING. BY THE TRUSS MANUFACTURER.

BRACED WALL CONSTRUCTION:

- 1. EACH EXTERIOR WALL SHALL BE CONTINUOUSLY SHEATHED WITH APPROPRIATELY RATED WOOD SHEATHING.
- 2. PROVIDE 48" PERFORATED STRAPS @ 4' O/C TO SECURE NEW FLOOR AND WALL SYSTEM TO EXISTING EXTERIOR WALL BELOW.
- 3. REAR WALL NARROW WALL CONDITIONS: PROVIDE AND INSTALL 2 HOLD-DOWN ANCHORS AT EACH CONDITION AND AT BOTH BEDROOM FLOOR LEVEL AND MAIN FLOOR LEVEL PER IRC 2018 602.10.4, TABLE R602.10.3(2). AT MAIN FLOOR, EMBED ANCHOR RODS IN EXP. SLEEVE SET IN EPOXY-FILLED HOLES DRILLED THROUGH SILL PLATE AND INTO EXISTING FOUNDATION WALL. HOLD-DOWN ANCHORS BY SIMPSON STRONG-TIE OR EQ.
- 4. ALL ROOF FRAMING SHALL BE FASTENED TO EXTERIOR WALL WITH HOLD-DOWN ANCHORS BY SIMPSON STRONG-TIE OR EQ.

WOOD FRAMING:

- PROVIDE STIFFENERS, BRACING BACKUP PLATES, BLOCKING AND OTHER ITEMS OF CONCEALED CONSTRUCTION IN STUD WALLS TO SUPPORT PLUMBING FIXTURES, BATHROOM ACCESSORIES WALL HUNG CABINETS AND OTHER EQUIPMENT.
- 2. ALL WOOD IN CONTACT WITH MASONRY OR CONCRETE SHALL BE PRESSURE TREATED
- 3. ALL NEW FLOOR JOISTS BEARING INTO EXISTING WALLS MUST HAVE SOLID BEARING.
- 4. ALIGN TOP OF NEW FRAMING FLUSH WITH TOP OF EXISTING. 5. DOOR AND WINDOWS.
- 6. INSTALL NEW DOORS AS CALLED FOR ON THE DRAWINGS.
- 7. PROVIDE AND INSTALL NEW WINDOWS AS CALLED FOR ON ELEVATION DRAWINGS.
- 8. FINISHES
- 9. NEW SIDING SHALL BE SELECTED BY OWNER.
- 10. NEW ASPHALT SHINGLES SHALL BE SELECTED BY OWNER.
- 11. ALL NEW EXTERIOR WALLS TO BE FRAMED WITH 2X6 STUDS 16" O.C. WITH R-21 BATT INSULATION AND FINISHED WITH 1/2" GYPSUM BD. AT INTERIOR FACE, UNLESS OTHERWISE
- 12. ALL NEW NON-RATED INTERIOR PARTITIONS TO BE 2X4'S AT 16" O.C. FINISHED WITH 1/2" GYPSUM BD. BOTH SIDES.
- 13. ALL GYP. BD. WALLS TO RECEIVE PRIMER PLUS TWO COATS OF LATEX PAINT. COLOR TO BE SELECTED BY OWNER.
- 14. INSTALL HARDWOOD, CARPET AND CERAMIC TILE WHERE CALLED FOR ON DRAWINGS. COLOR TO BE SELECTED BY OWNER. PROVIDE UNDERLAYMENT GRADE SUBFLR AS SHOWN ON DRAWINGS
- 15. PROVIDE THRESHOLD BETWEEN HARDWOOD AND CERAMIC TILE. PROVIDE MARBLE THRESHOLD AT DOOR TO BATHROOMS.
- 16. PROVIDE CARPET IN ALL BEDROOMS, AND ADJACENT CLOSETS, UNLESS OTHERWISE NOTED

SPECIALITIES:

- . SUPPLY CLOSETS TO HAVE 5 STACKED WIRE MESH SHELVES TO FIT SIZE OF CLOSET.
- 2. PROVIDE THE FOLLOWING FULL BATH ACCESSORIES:
 - a. RECESSED MEDICINE CHEST WITH MIRROR DOOR WI TWO ADJUSTIBLE SHELVES
 - b. 2 TOWEL HOLDER,
 - c. TOILET PAPER HOLDER,
 - d. RECESSED SOAP DISH,

GENERAL MEP DATA & NOTES

MECHANICAL - ELECTRICAL - PLUMBING:

- THE CONTRACTOR SHALL BE RESPONSIBLE FOR ESTABLISHING THE LOCATION OF EXISTING UTILITIES, IF ANY, PRIOR TO ANY EXCAVATION, OR DEMOLITION.
- 2. THE CONTRACTOR SHALL BE RESPONSIBLE FOR INSTALLING ALL UTILITIES, SUCH AS WATER, SEPTICISEMER, GAS, ELECTRICAL AND PHONE SERVICES TO THE BUILDING AND FOR ANY UPGRADING THAT MAY BE NECESSARY.

- 1. ALL MECHANICAL WORK TO BE DONE BY A CERTIFIED MECHANICAL CONTRACTOR LICENSED IN THE STATE OF MARYLAND.
- 2. THE CONTRACTOR SHALL VERIFY THE SIZE AND LOCATION OF ALL OPENINGS, BULKHEADS AND CHASES REQUIRED FOR CLEARANCE AND INSTALLATION OF MECHANICAL DUCTS, COORDINATE WITH OTHER SUBCONTRACTORS, AND NOTIFY OWNER OF ANY CONFLICT. CONCEAL ALL DUCTWORK IN CHASE OR BETWEEN JOISTS UNLESS OTHERWISE SPECIFIED.

INSULATE ALL DUCTS IN UNHEATED AREAS.

1. ALL THE PLUMBING WORK SHALL BE DONE BY A CERTIFIED PLUMBING CONTRACTOR LICENSED IN THE STATE OF MARYLAND.

ALL PLUMBING FIXTURES (EXCEPT WATER CLOSETS) SHALL RECEIVE HOT AND COLD WATER SUPPLY.

- ALL ELECTRICAL WORK SHALL BE DONE BY A CERTIFIED ELECTRICAL CONTRACTOR LICENSED IN THE STATE OF MARYLAND.
- 2. THE CONTRACTOR SHALL FURNISH ALL LABOR, MATERIALS, EQUIPMENT AND SERVICES NECESSARY FOR THE CONSTRUCTION OF A COMPLETE AND FULLY FUNCTIONING
- 3. ALL LABOR AND MATERIALS, ALTHOUGH NOT SPECIFICALLY MENTIONED, BUT NECESSARY FOR THE COMPLETION OF WORK AND THE SUCCESSFUL OPERATION OF THE ELECTRICAL SYSTEMS, SHALL BE SUPPLIED AS IF SPECIFICALLY INDICATED.
- 4. ALL WORK SHALL CONFORM TO THE REQUIREMENTS OF THE LATEST EDITION OF THE NATIONAL ELECTRIC CODE, LOCAL BUILDING CODE, AND ALL APPLICABLE CODES.
- MATERIALS AND EQUIPMENT INSTALLED AS PART OF THE PERMANENT INSTALLATION SHALL BE NEW UNLESS OTHERWISE INDICATED AS SPECIFIED, AND SHALL BE APPROVED BY THE UNDERWRITERS LABORATORIES, INC. FOR INSTALLATION IN EACH PARTICULAR CASE WHERE STANDARDS HAVE BEEN ESTABLISHED.
- 6. THE CONTRACTOR SHALL OBTAIN ALL NECESSARY PERMITS AND CERTIFICATES OF INSPECTION. ALL FEES AND CHARGES ASSOCIATED SHALL BE PAID BY THE CONTRACTOR. THE CERTIFICATES OF INSPECTION SHALL BE DELIVERED TO THE OWNER BEFORE FINAL PAYMENT IS MADE.
- THE CONTRACTOR SHALL GUARANTEE IN WRITING ALL MATERIAL, EQUIPMENT AND WORKMANSHIP FOR A MINIMUM PERIOD OF ONE YEAR FROM DATE OF ACCEPTANCE BY THE OWNER OF SUBSTANTIAL COMPLETION.

1. PRE-ENGINEERED 11 7/8" JOISTS @ 16" O/C RATED FOR SPANS INDICATED ON

2. 3/4" TONGUE AND GROOVE ADVANTECH PANELS GLUED AND FASTENED TO

b. 1/2" EXTERIOR SHEATHING APPLIED CONTINUOUSLY TO FRAMING.

JOISTS INSTALLED PER MANUFACTURERS REQUIREMENTS

OUTLINE SPECIFICATIONS

THE DRAWING. TJI OR EQUAL

3. MINIMUM R-38 FIBERGLASS INSULATION

C. AIR/MOISTURE BARRIER PER CODE

e. 30 YEAR FIBER CEMENT LAP SIDING

b. 2X6 CONSTRUCTION @ STAIRWAY

4. MINIMUM R-38 FIBERGLASS INSULATION

6. ALUMINUM GUTTERS AND DOWNSPOUTS

1. ANDERSON SERIES 400 WINDOWS

2. SAFETY GLAZED WHERE REQUIRED.

d. MINIMUM R-20 FIBERGLASS INSULATION

a. 2X4 CONSTRUCTION @ COMMON INTERIOR

1. PRE-ENGINEERED WOOD TRUSSES SPACED 24" O/C.

2. ROOF SHEATHING MINIMUM 5/8" APA RATED SHEATHING.

5. ARCHITECTURAL GRADE 30 YEAR ASPHALT SHINGLES.

3. LOOKOUTS SHALL BE 2 X 4 (LLV) NOMIMAL SPACED 24" O/C

c. 1/2" GWB EACH SIDE (5/8X @ STAIRWAY)

FLOOR SYSTEM

WALLS

1. EXTERIOR WALLS-

2. INTERIOR WALLS-

WINDOWS & DOORS

a. 2X6 CONSTRUCTION



PARTIAL FRONT ELEVATION

2 PARTIAL FRONT ELEVATION



B PROPOSED CRAFTS STUDIO PLAN

CONSULTANTS:

ALL SQUARE



I CERTIFY THAT THESE DOCUMENTS WERE PREPARED OR APPROVED BY ME, AND THAT I AM A DULY MARYLAND, LICENSE NO. 8850, EXPIRATION DATE

TREXLER RESIDENCE

CRAFTS STUDIO RENOVATIONS 13001 WAINWRIGHT ROAD HIGHLAND, MD 20777

REVISIONS MARK DATE DESCRIPTION 01 3/17/19 REVIEW 02 9/17/19 FINAL REVIEW 03 03/15/21 PERMIT


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PROJECT


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NOTES



COLLABORATIVE

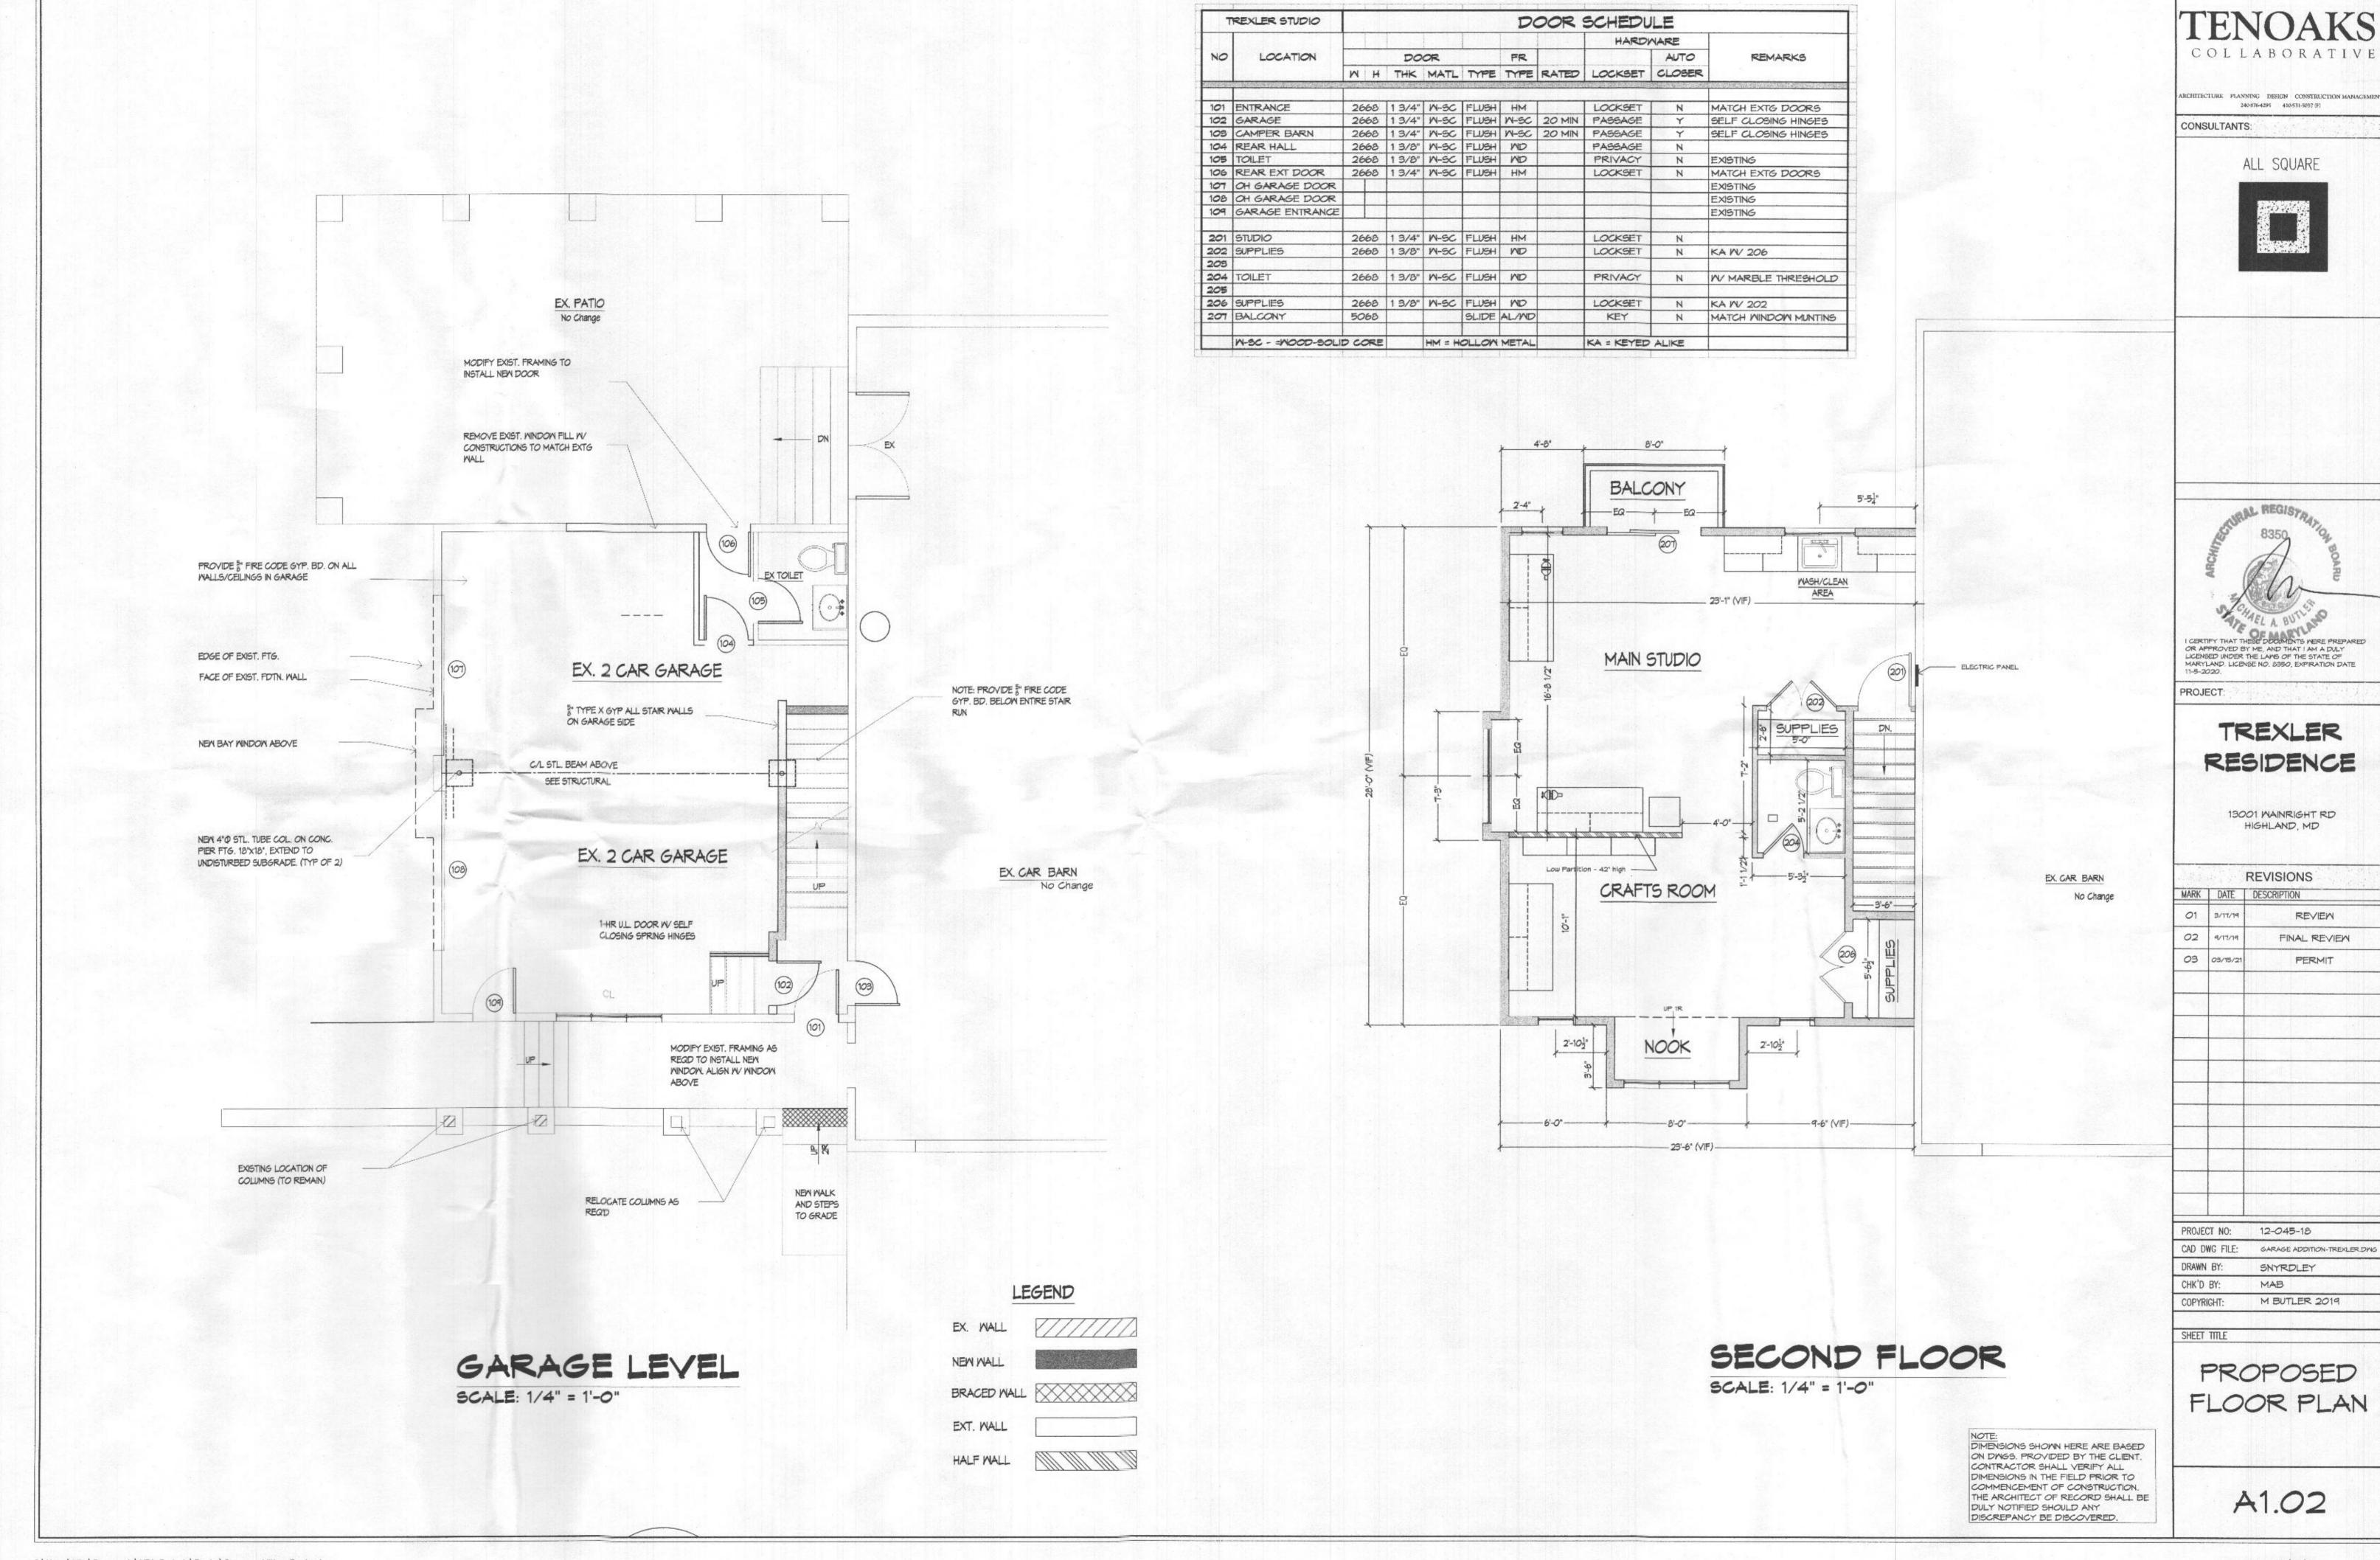


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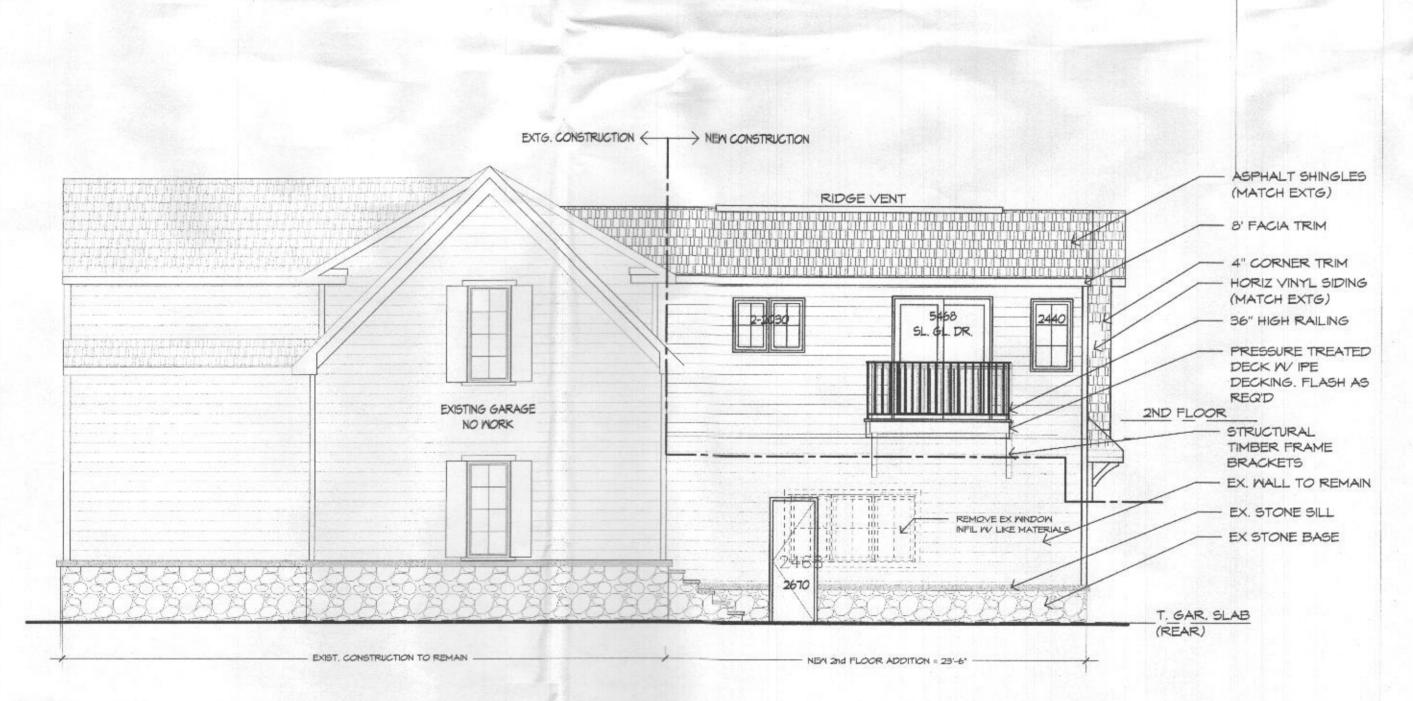
PROPOSED FLOOR PLAN

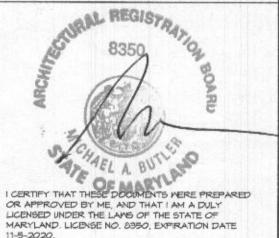


LEFT SIDE ELEVATION SCALE: 8/16" = 1'-0"



FRONT ELEVATION
SCALE: 8/16" = 1'-0"

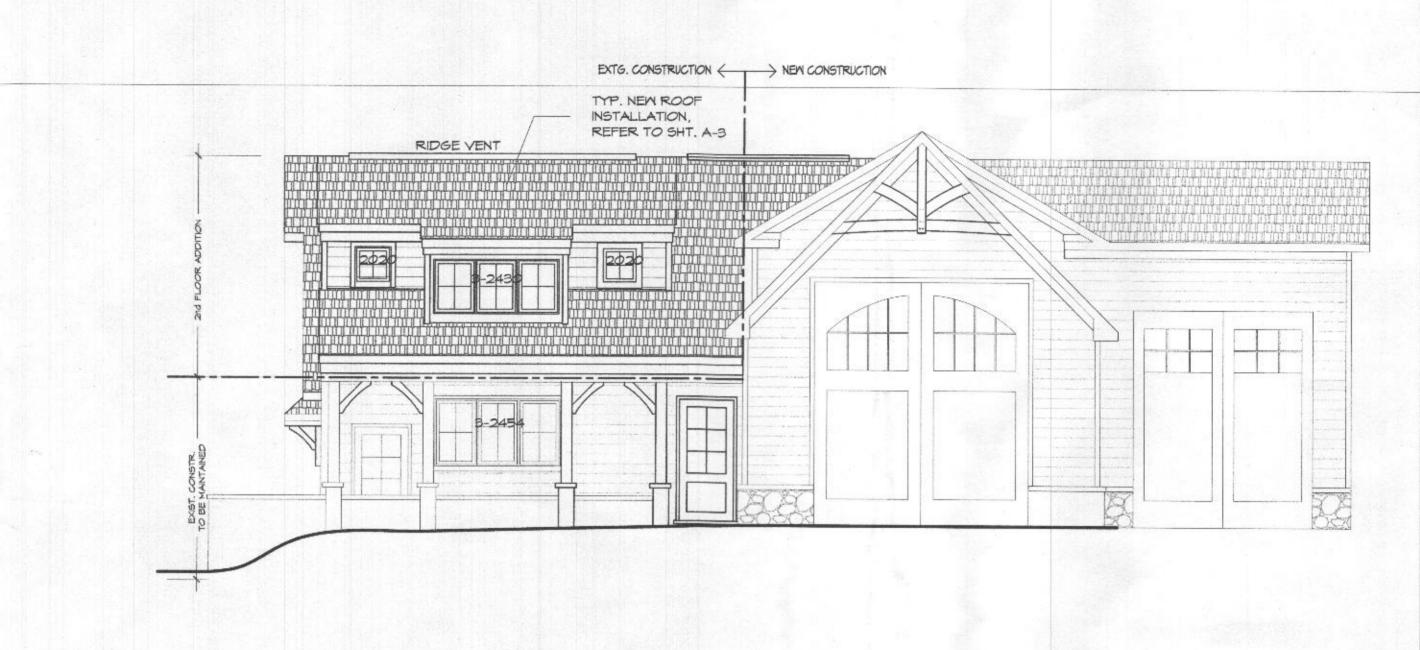

REAR ELEVATION SCALE: 3/16" = 1'-0"

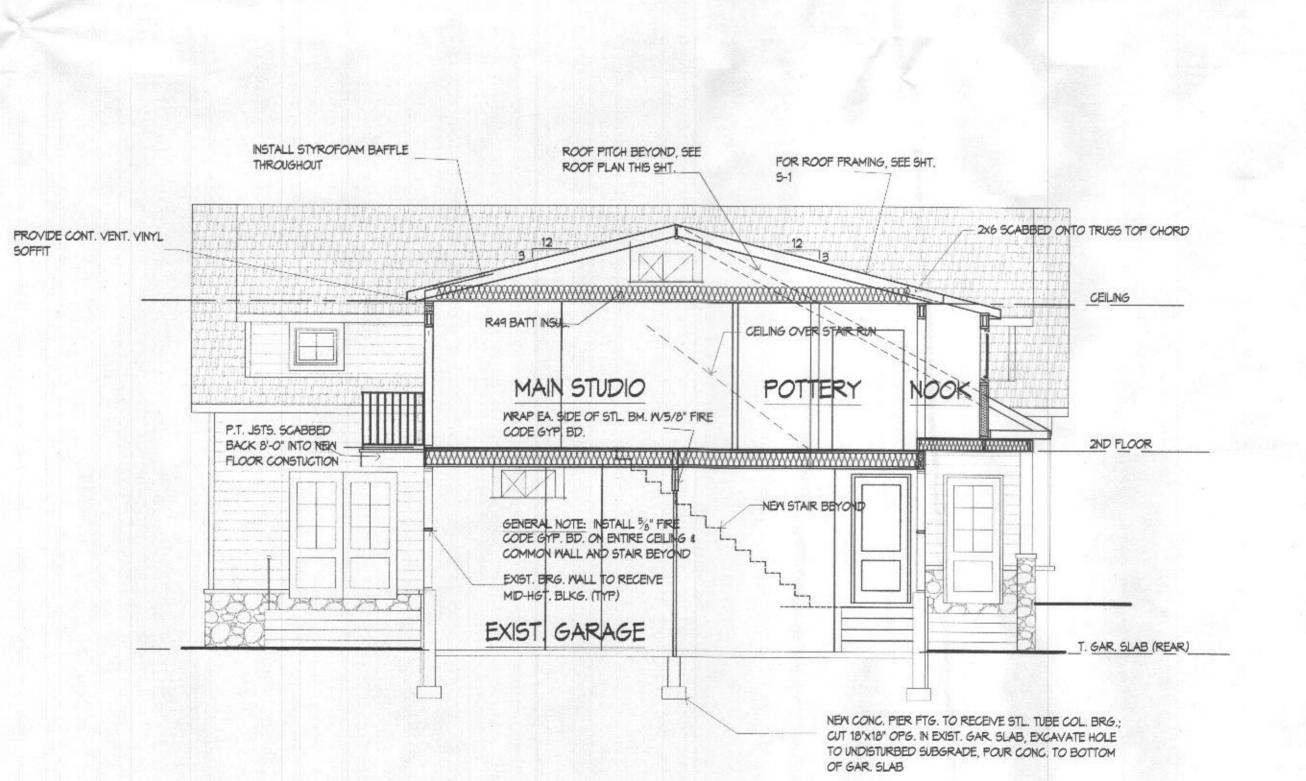

BUILDING SECTION SCALE: 3/16" = 1'-0" TENOAKS

ARCHITECTURE PLANNING DESIGN CONSTRUCTION MANAGEMENT 240-876-4295 410-531-5037 (F)

CONSULTANTS:

ALL SQUARE





PROJECT:

TREXLER


13001 WAINRIGHT RD HIGHLAND, MD

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MARK	DATE	DESCRIPTION				
01	1/21/19	OWNER REVIEW				
02	3/17/19	FINAL REVIEW				
03	03/15/21	PERMIT				
PROJE	CT NO:	12-045-18				
CAD D	WG FILE:	GARAGE ADDITION-TREXLER,D				
DRAWN	BY:	SNYRDLEY				
CHK'D	BY:	MAB				
COPYR	GHT:	M BUTLER 2021				

ELEVATIONS


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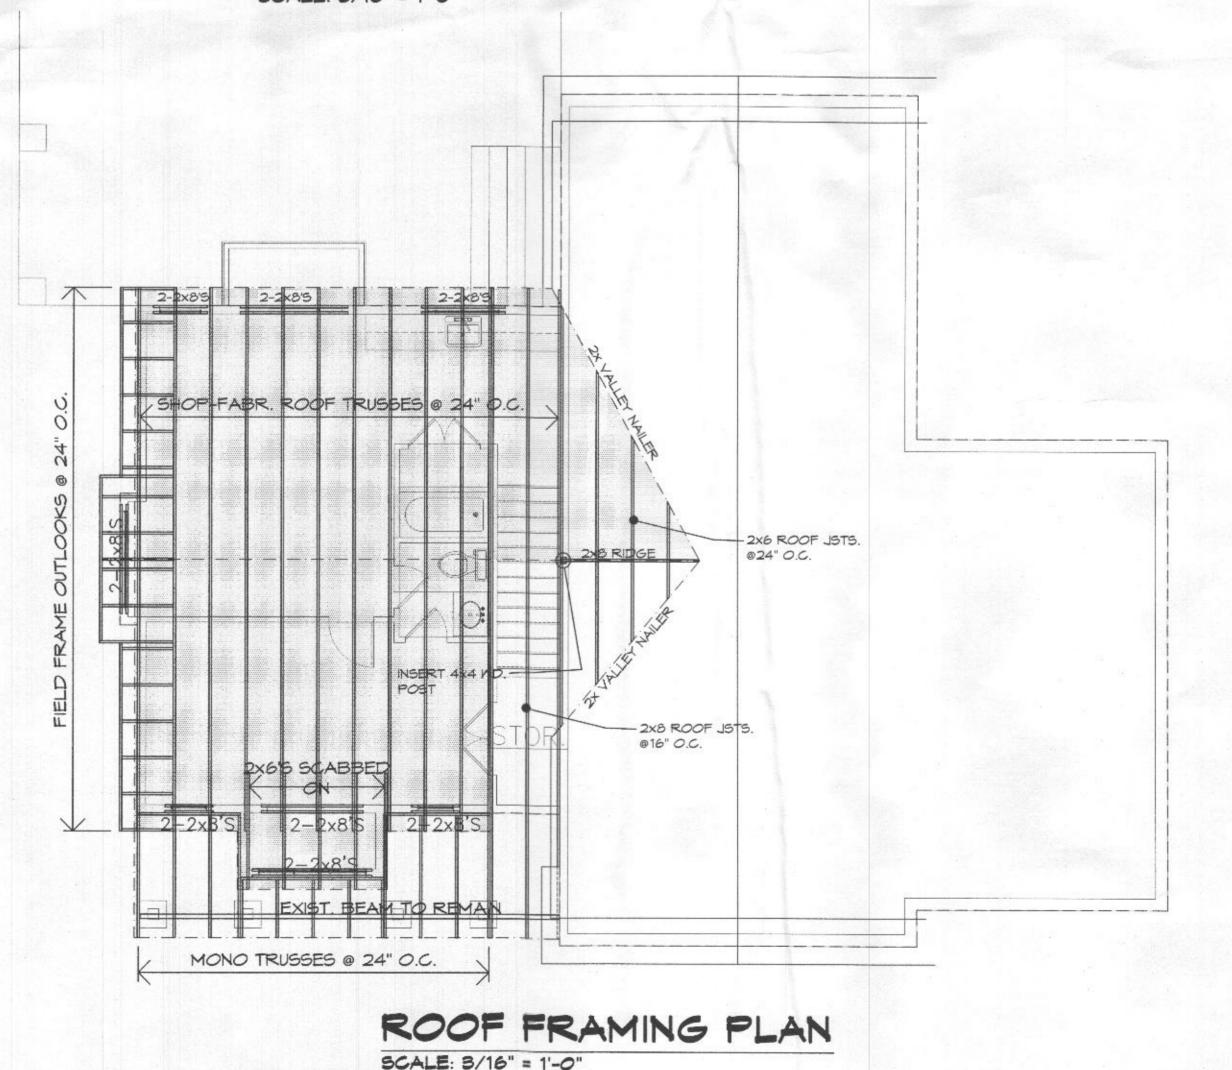


ROOF DETAIL NOTES

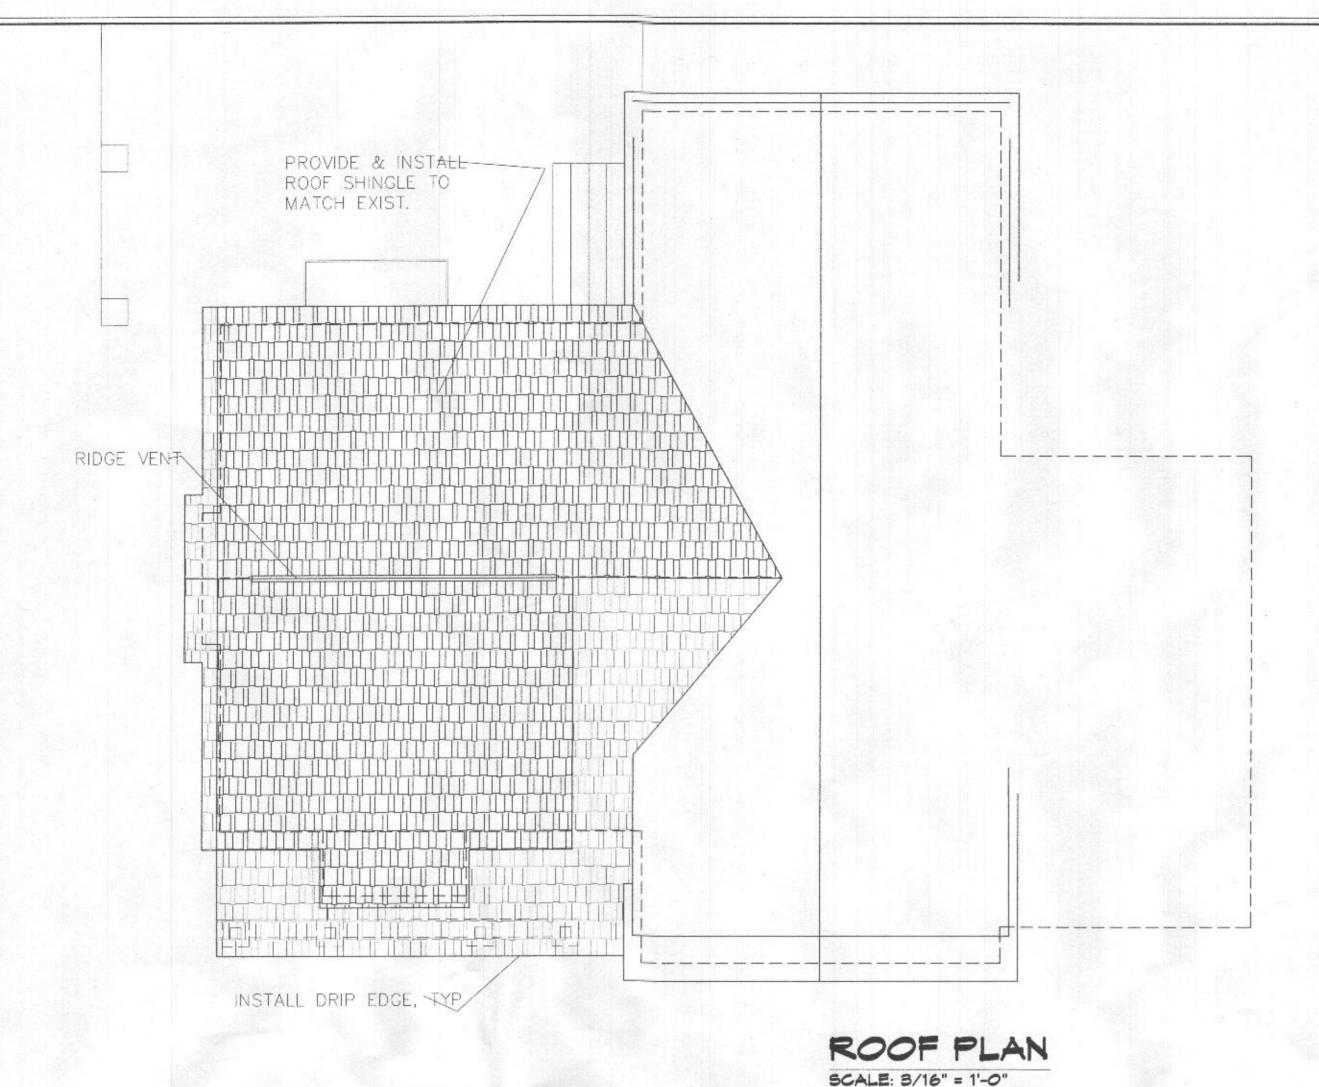- 1. TYPICAL ROOF SLOPE SHALL BE 7:12 UNLESS NOTED. ROOF DORMERS SHALL BE AS NOTED ON THE PLAN.
- 2. LOOKOUTS SHALL BE 2 X 4 NOMIMAL SPACED 24" O/C AND SHALL BE PLACED WITH THE LONG DIMENSION (3 1/2") VERTICAL. ALL LOOKOUTS SHALL START AT FIRST INBOARD TRUSS AND PASS OVER THE GABLE WALL FRAMING.
- 3. ROOF SHEATHING SHALL BE 5/8" APA RATED SHEATHING AND SHALL BE PLACED WITH THE LONG DIMENSION HORIZONTAL. CLIPS SHALL BE PROVIDED AT MID SPAN BETWEEN ALL TRUSSES.
- 4. ALL SHEATHING PANELS SHALL SPAN AT LEAST TWO SUPPORTS AND ALL PANEL EDGES SHALL BE SPACED A MINIMUM OF 48" FROM OTHER EDGES.
- 5. SHEATHING SHALL BE PLACED TO ALLOW FOR CONTINUOUS VENTILATION AT THE RIDGE.
- 6. SHEATHING SHALL OVERLAP FACIA BOARD AT ALL GABLES, EAVES AND EDGES.
 - a. ALL ROOF COVERINGS SHALL BE APPLIED IN ACCORDANCE WITH 2018 IRC AND THE MANUFACTURERS INSTALLATION INSTRUCTIONS.
 - b. APPROVED ICE BARRIERS SHALL BE PLACED AT ALL EAVES, VALLEYS, WALLS, CHIMNEYS AND VENTS PER 2018 IRC AND MANUFACTURERS RECOMENDATIONS.
 - c. ALUMINUM OR OTHER APPROVED CORROSION RESISTANT FLASHINGS AND COUNTER FLASHINGS SHALL BE PROVIDED AT ALL BASE, CAP, VALLEY, SIDEWALL, CHIMNEY, VENT AND OTHER ROOF PENETRATIONS PER CODE.
- d. DRIP EDGES SHALL BE INSTALLED AT ALL EAVES AND RAKE EDGES.



2ND FLOOR FRAMING PLAN SCALE: 8/16" = 1'-0"

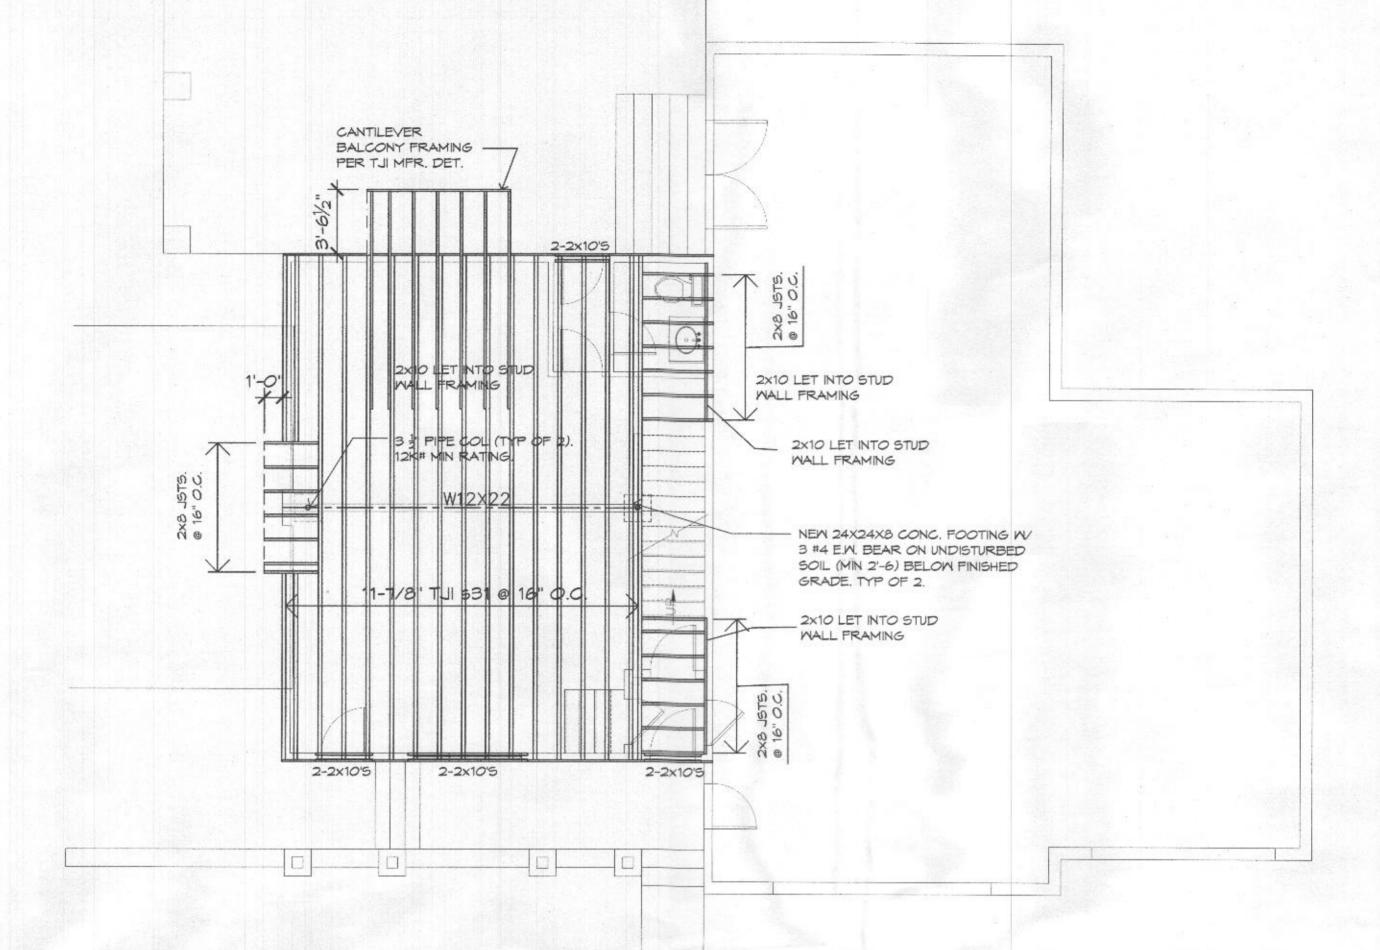



CNUAKS

BICHITECTURE PLANNING DESIGN CONSTRUCTION MANAGEM 240-876-4295 410-531-5037 (F)

CONSULTANTS:

ALL SQUARE

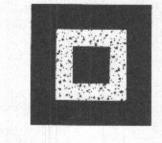

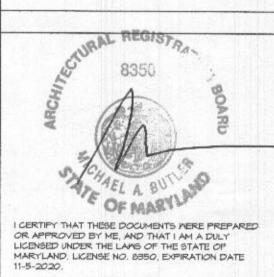

PROJECT:

TREXLER

13001 WAINRIGHT RD HIGHLAND, MD

REVISIONS								
MARK	DATE	DESCRIPTION						
01	1/21/19	OWNER REVIEW						
02	3/17/19	REVIEW						
03	03/15/21	PERMIT						
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PROJECT NO: 12-045-18

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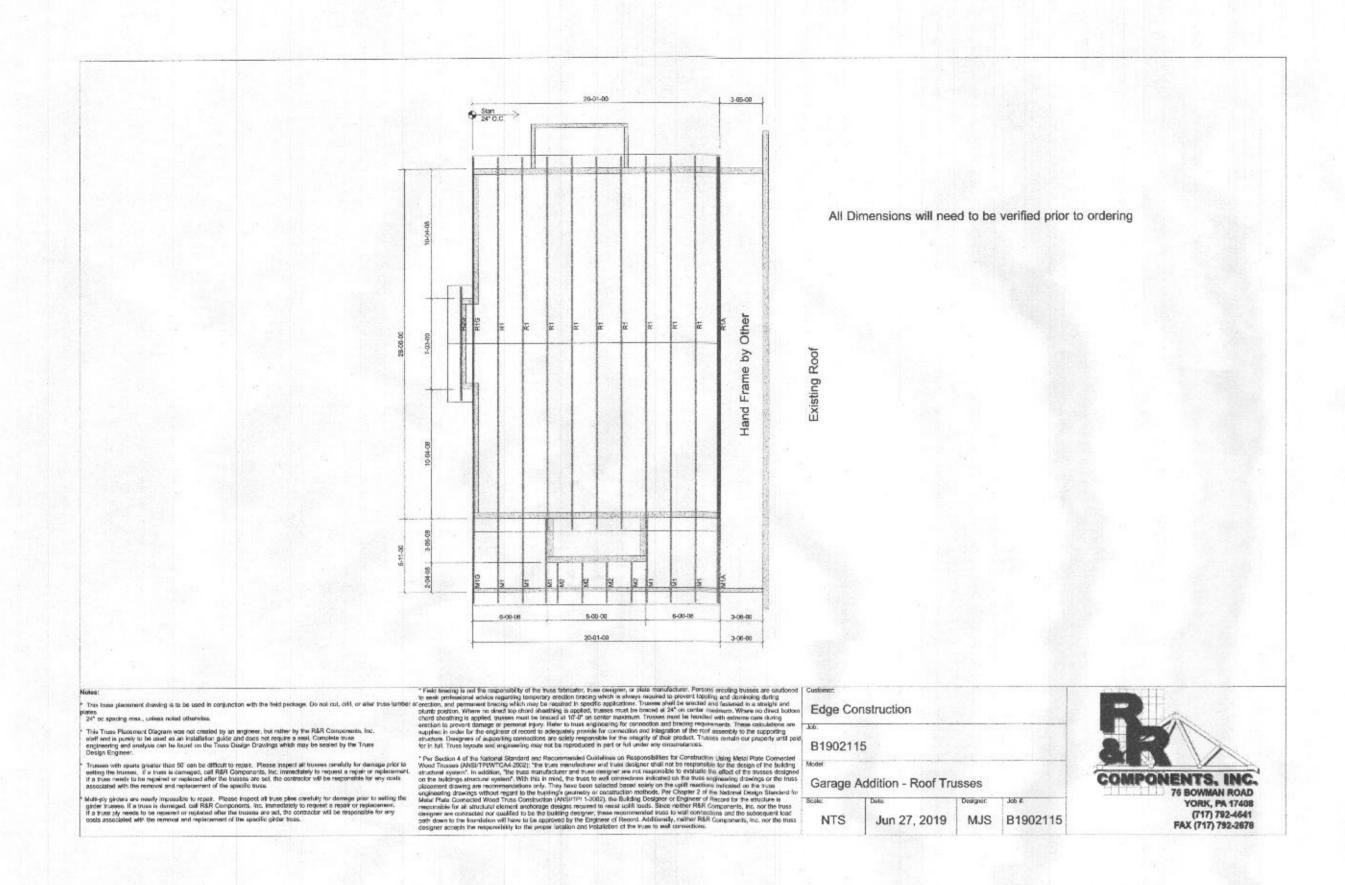
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CHK'D BY: MAB


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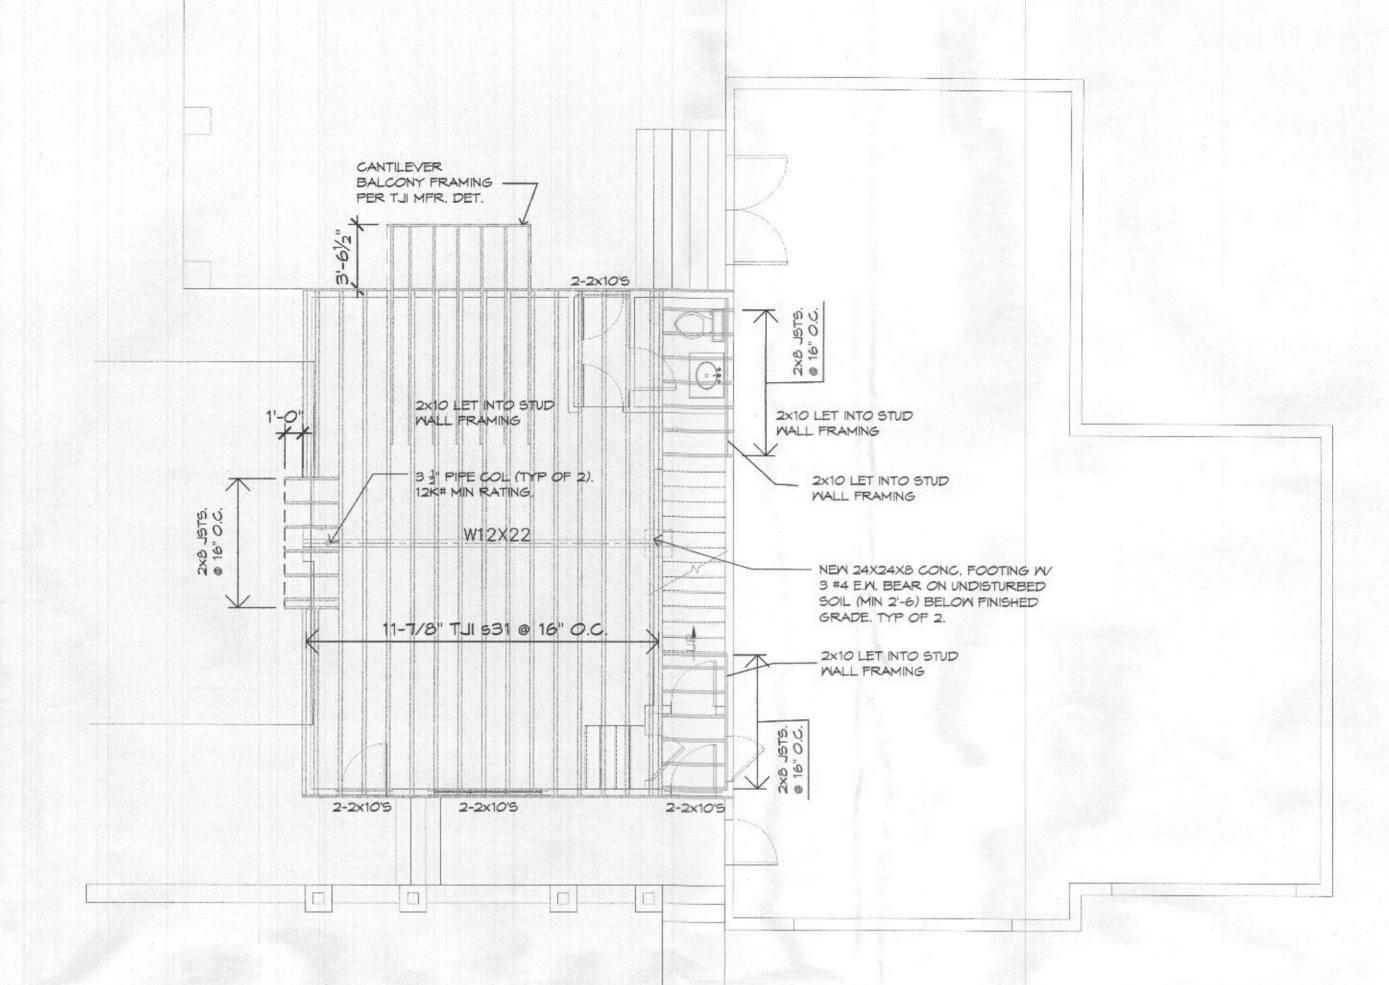
FRAMING




ROOF TRUSS DIAGRAM



FLOOR FRAMING DIAGRAM No Scale

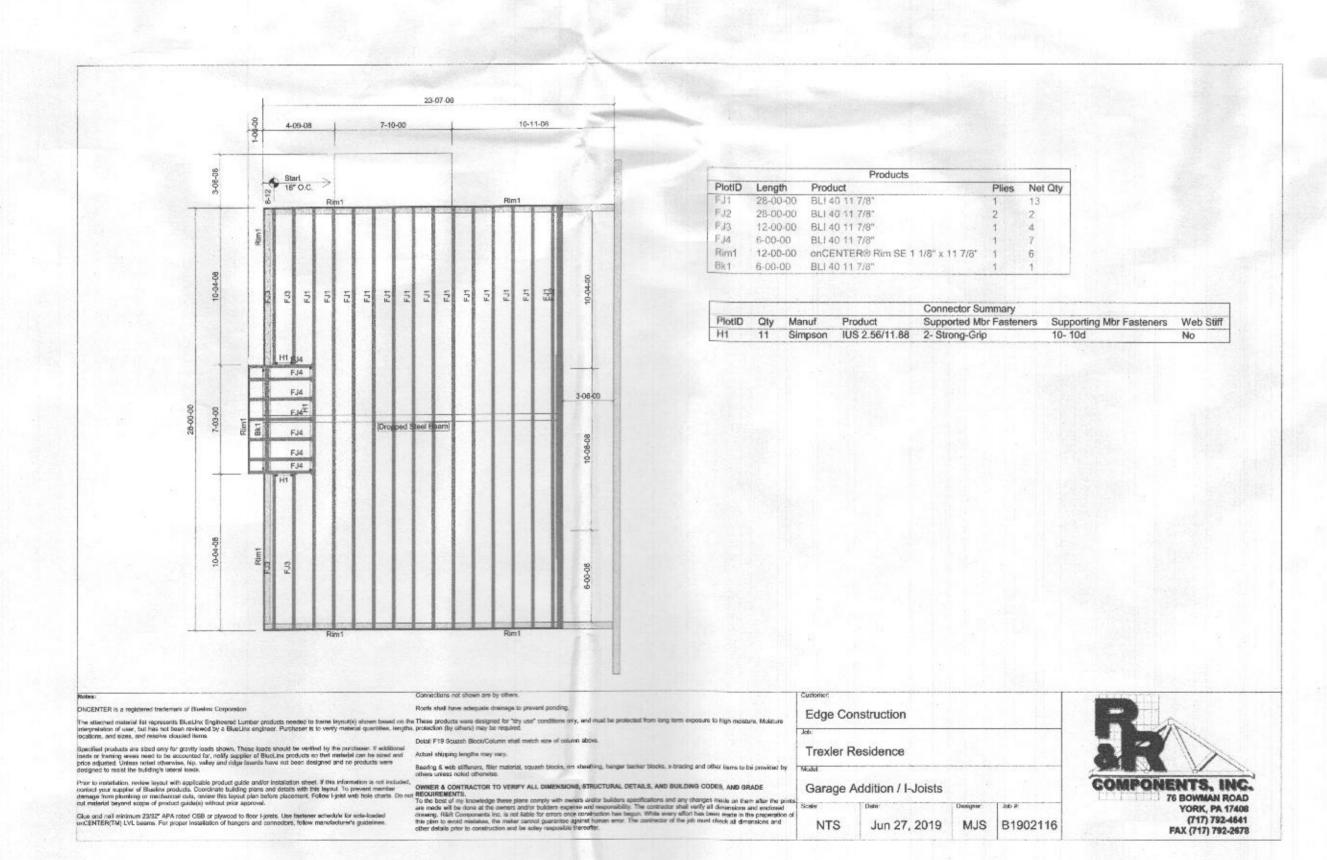

2ND FLOOR FRAMING PLAN

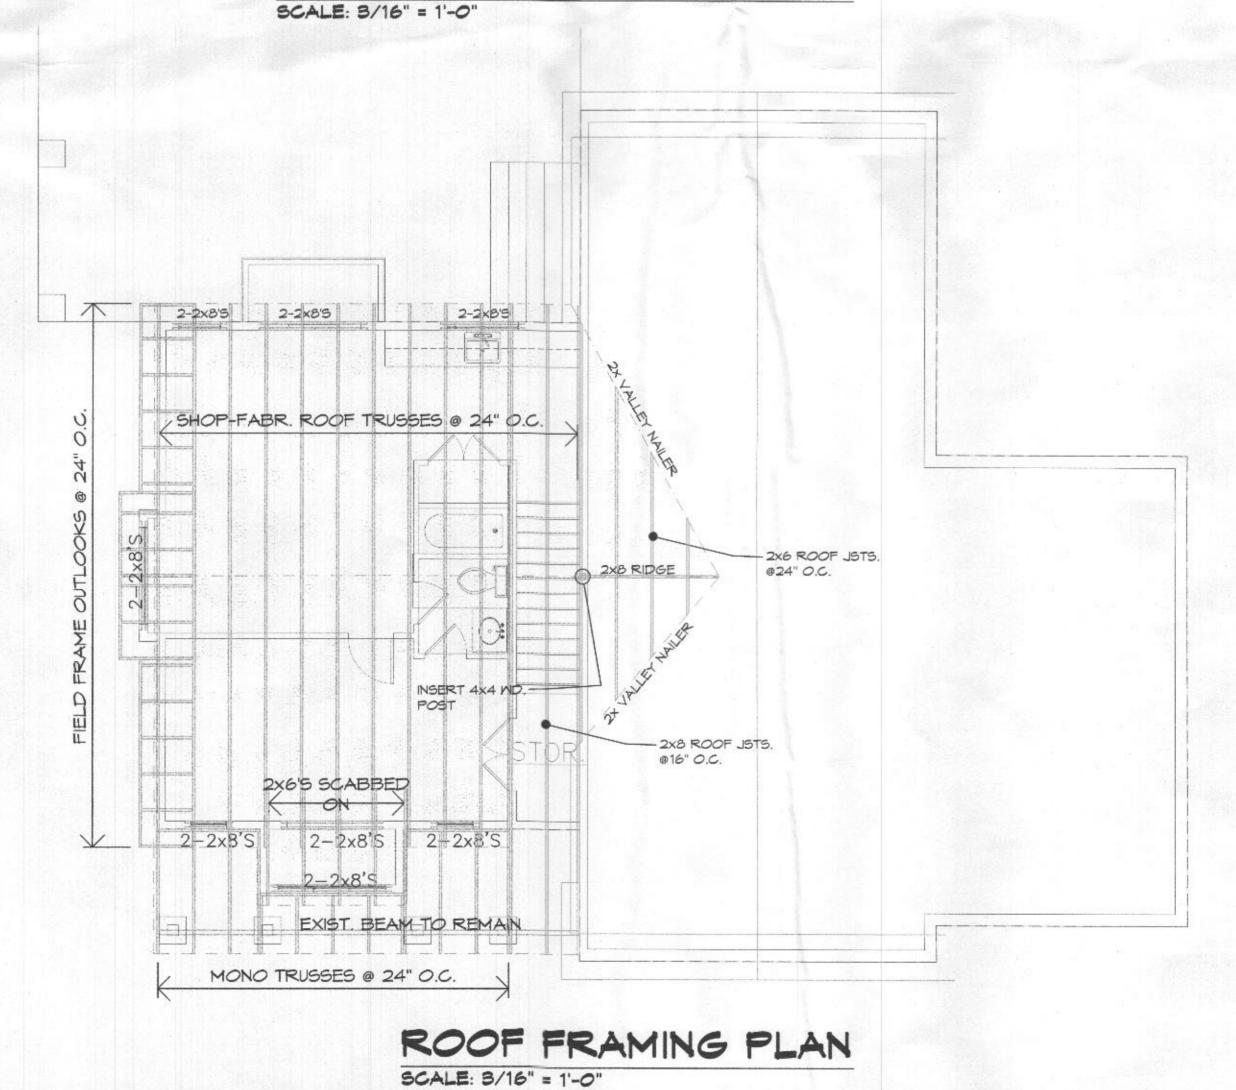

ARCHITECTURE PLANNING DESIGN CONSTRUCTION MANAGEME

ALL SQUARE





PROJECT:

TREXLER RESIDENCE

13001 WAINRIGHT RD HIGHLAND, MD


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03	03/15/21	PERMIT				
PROJE	CT NO:	12-045-18				
	WG FILE:	GARAGE ADDITION-TREXLER, DWG				
DRAWN	BY:	SNYRDLEY				

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SHEET TITLE

TRUSS DETAIL FRAMING



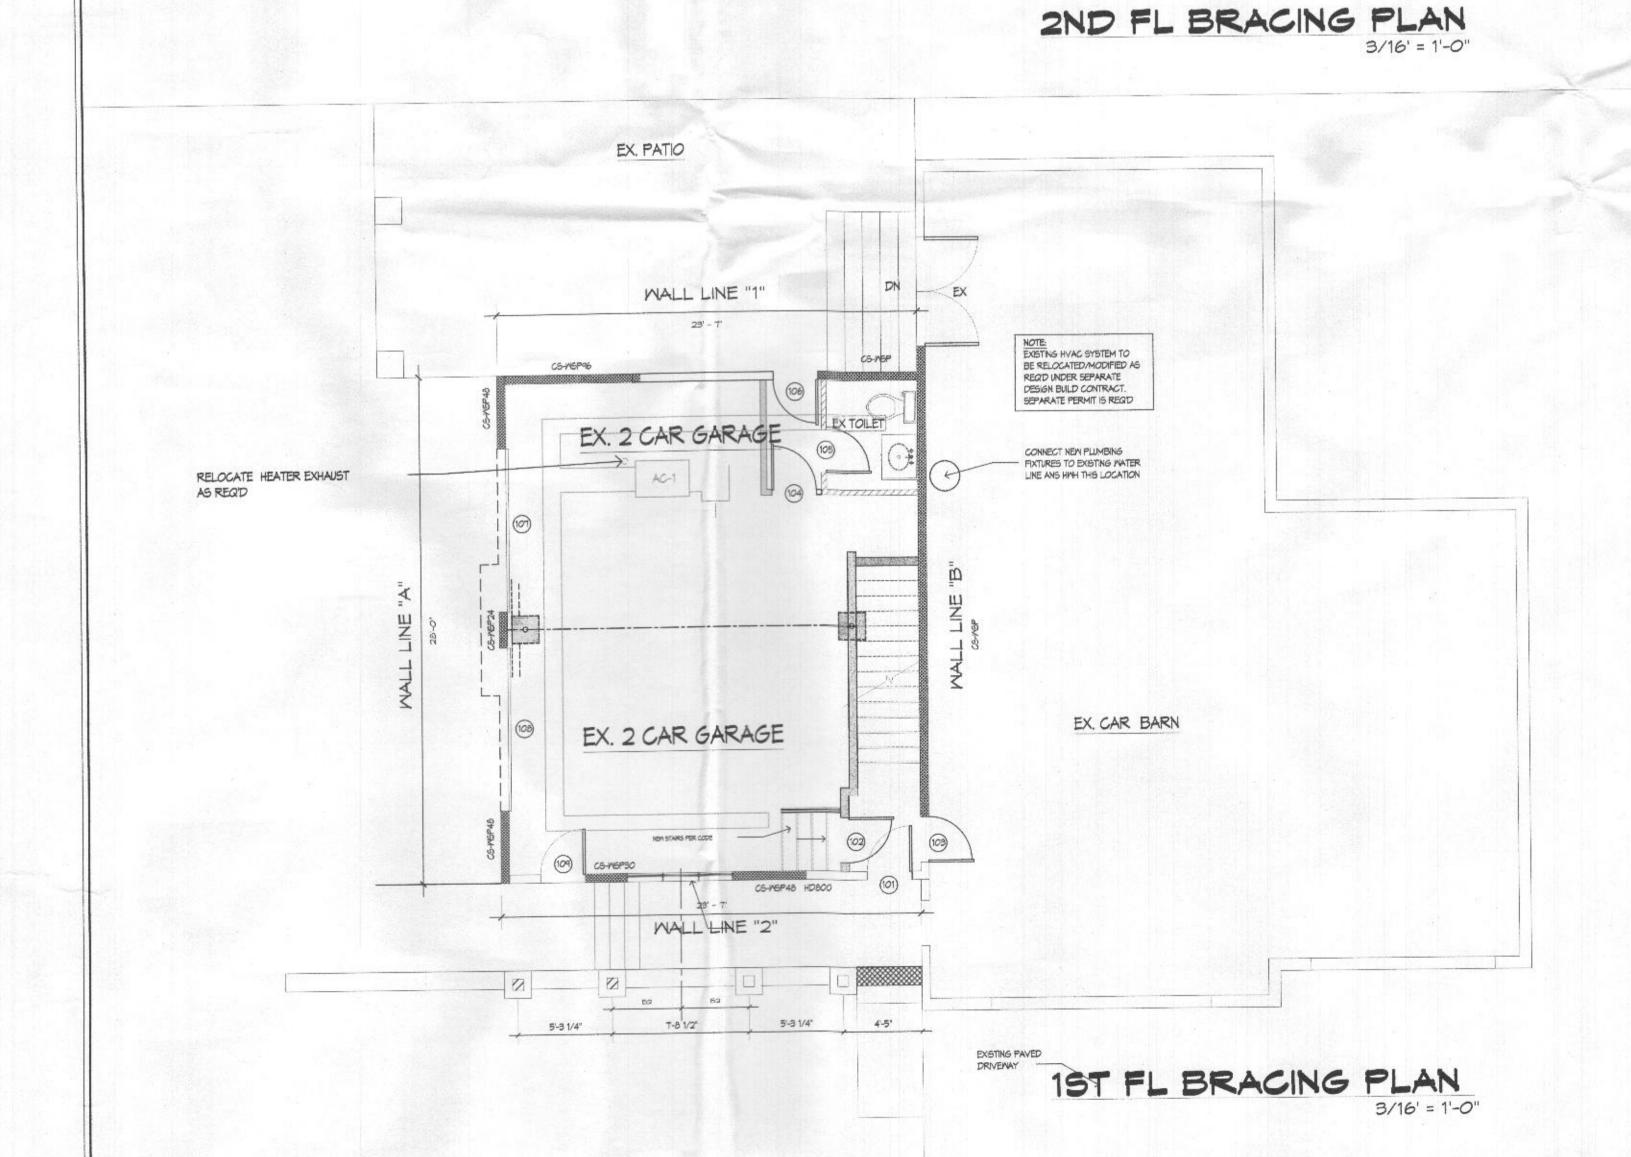


BRACING CALCULATIONS & ANALYSIS

Trexter- 2nd floor studio addition

APA Wall Bracing Calculator Project Report

Home/Building Plan Name SDC (Seismic Design Category) Wind Speed Wind Exposure Category

13001 Wainwright Rd., Highland, MD BASED ON 2018 IRC 1-2 FAMILY A-C EXPOSURE B Total Number of Stories Mean Roof Height less than 30 ft.

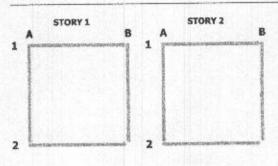

Total Wall Line Length: 28' 0"

BI 9' CS-WSP 4'0" 8'0" 4 6"/12" B2 9' CS-PF 2'0" 8'0" 2 3"/3" grid

Include proper PF or ABW details on the plans.

WALL LINE ELEVATION VIEW

Total Wall Line Length: 28' 0"

B2 9' CS-WSP 5'0" 6'8" 5 6"/12"


Total Wall Line Length: 23" 6"

8:	1		82							
Story	Wall	Bracine Method			Bracing mount	Selsmic Factors	Seismic Bracing Amount	Required Bracing	Qualified Bracing	Bracing Status
1st Story	1	CS-WS	SP 0.9	3	4	Exempt	Exempt	4	21	Compliant
		Une ment	Wall Height	Bracing Method	Segment Length	Adjacen Opening Height	Seement	Nalls	Tension Tie	Hold Down
	E	31	9'	CS-WSP	15' 6"	6' 8"	15.5	6"/12"		
	E	32	9'	CS-WSP	5' 6"	6' 8"	5.5	6"/12"		

BRACED WALL CONSTRUCTION:

EXISTING EXTERIOR WALL BELOW.


- 1. CONSTRUCT ALL WALLS TO BE BRACED AS SHOWN ON THE DRAWINGS AND ACCORDING TO SECTION R 602.10 OF THE INTERNATIONAL RESIDENTIAL CODE (IRC) AND IN ACCORDANCE WITH THE BRACING ANALYSIS ABOVE.
- 2. ALL BRACED WALL PANELS SHALL BE CONSTRUCTED ACCORDING TO IRC TABLE 602.10.4.
- 3. EACH EXTERIOR WALL SHALL BE CONTINUOUSLY SHEATHED (CS) WITH APPROPRIATELY RATED WOOD SHEATHING. 4. PROVIDE 48" PERFORATED STRAPS @ 4' OIC TO SECURE NEW FLOOR AND WALL SYSTEM TO
- 5. ALL ROOF FRAMING SHALL BE FASTENED TO EXTERIOR WALL WITH HOLD-DOWN ANCHORS BY SIMPSON STRONG-TIE OR EQ.

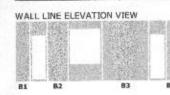

WALL LINE PLAN VIEW B1 82 83 84

Story	Wall Line	Bracing Method			d Bracing Amount	Selsmic Factors		nic Bracing Lmount	Required Bracing	Qualified Bracing	Bracing Status
1st Story	2	CS-WS	P 0.93	1.	4	Exempt	E	Exempt	4	10	Compliant
		Line	Wall Height	Bracing Method	Segme Lengt		ning	Qualified Segment	Nails	Tension Tie	Hold Down
	E	31	9'	CS-WSP	2' 2	6'	8"	0	6"/12"		
	E	32	9'	CS-WSP	3, 0	6'	8"	3	6"/12"		
	E	33	9'	CS-WSP	7' 0	" 6'	8*	7	6"/12"	STUDIES -	800
		94	9'	CS-WSP	11.4	. 6'	8"	0	6"/12"		

Include proper 800lb HD details for IRC placement rules on the plans.

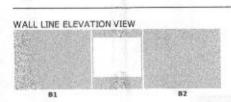

Total Wall Line Length: 28' 0"

Wall Line Wall Bracing Segment Height Method B1 8' CS-WSP 10' 6" 5' 4" 10.5 6'/12" B2 8' CS-WSP 10' 6" 5' 4" 10.5 6"/12"




Total Wall Line Leigth: 28' 0"

8' CS-WSP 28' 0"

Total Wall Line Length: 23' 6"

Story	Wall Line	Bracine Method			nd Bracing Amount	Seismic :	Selsmic Bracing Amount	Required Bracing	Qualified Bracing	Bracing Status
2nd Story	1	CS-WS	P 0.0	53	2.71	Exempt	Exempt	2.71	11	Compliant
	Wall Segn		Wall Height	Bracing Method	Segment Length	Adjacem Opening Height		Nails	Tension Tle	Hold Down
	В	1	8'	CS-WSP	1' 2*	5' 4"	0	6"/12"		
	В	2	8*	CS-WSP	3' 0"	6' 8"	3	6*/12"		800
	В	3	8"	CS-WSP	4' 0"	6' 8"	4	6"/12"		
	В	4	8'	CS-WSP	4' 0"	2' 8"	4	6"/12"		

include proper 800lb HD details for IRC placement rules on the plans.

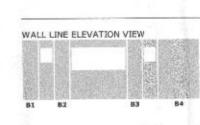

WALL LINE PLAN VIEW

82		83	84							
Story	Wall	Bracing Method	Wind			Seismic S Factors	elsmic Bracing Amount	Required Bracing	Qualified Bracing	Bracing Status
d Story	2	CS-WSP	0.63		2.71	Exempt	Exempt	2.71	11.84	Compliant
	Wall Segn		Wall leight	Bracing Method	Segment Length	Adjacent Opening Height	Qualified Segment	Nalls	Tension Tie	Hold Down


Wall Line Segmen		Bracing Method	Segment Length	Opening Height	Qualified Segment	Nalis	Tension	Hold Down
B1	8'	CS-WSP	2' 2"	2' 0"	2.17	6"/12"		
B2	8'	CS-WSP	2' 0"	3' 0"	2	6"/12"		
В3	8'	CS-WSP	2" 0"	3' 0"	2	6"/12"		
B4	8'	CS-WSP	5' 8"	2' 0"	5.67	6"/12"		

CONSULTANTS:

ARCHITECTURE PLANNING DESIGN CONSTRUCTION MANAGEME

ALL SQUARE



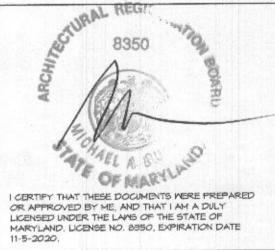

PROJECT:

TREXLER RESIDENCE

13001 WAINRIGHT RD HIGHLAND, MD

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MARK	DATE	DESCRIPTION
01	1/21/19	OWNER REVIEW
02	3/17/19	FINAL REVIEW
03	23/15/21	PERMIT
PROJECT	r NO:	12-045-18

BRACING PLAN

DRAWN BY: SNYRDLEY


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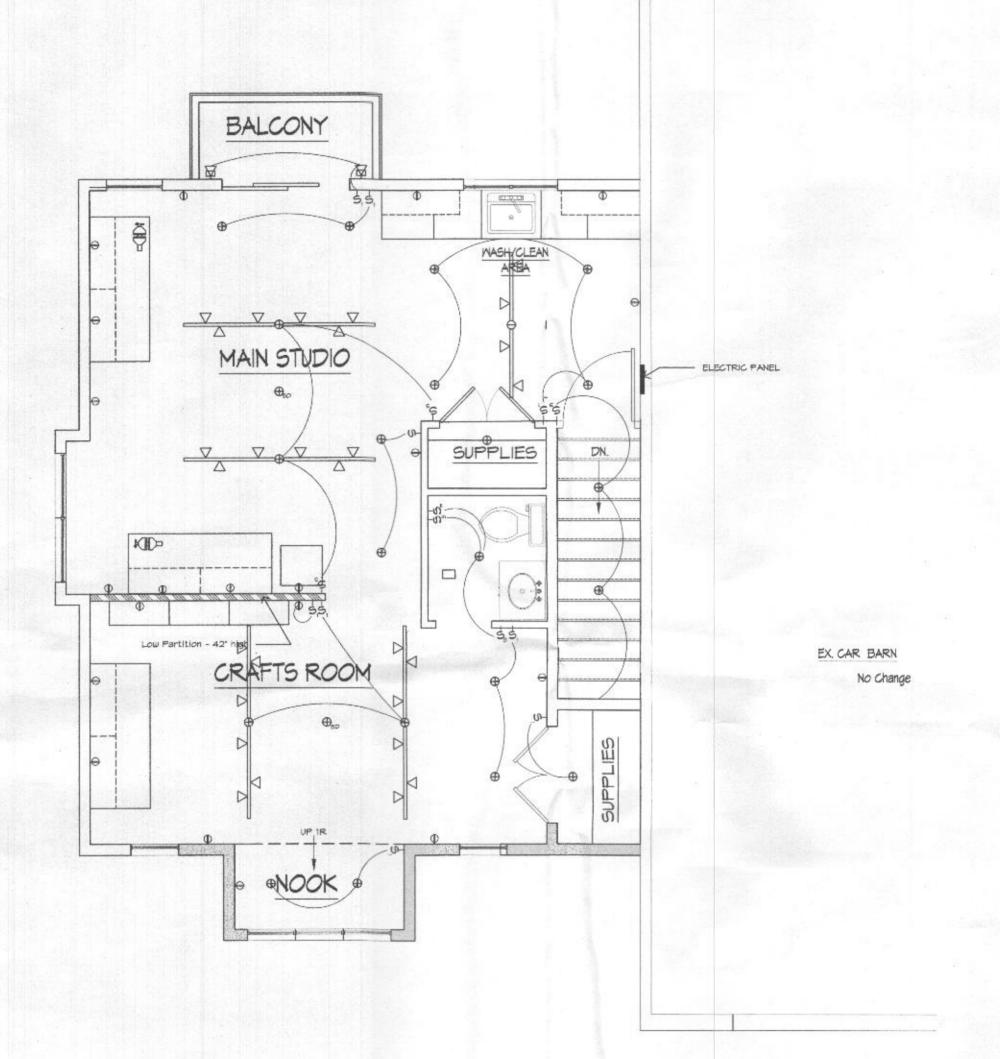
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SHEET TITLE



SCHEMATIC MECHANICAL LAYOUT

NOTE:
LAYOUT AND SIZING OF HVAC SYSTEM SHOWN ABOVE IS FOR DIAGRAMATIC
PURPOSES ONLY. ALL EQUIPMENT AND DUCTWORK SIZING TO BE BY
MECHANICAL CONTRACTOR, SEPARATE PERMIT IS REQUIRED FOR THIS WORK.

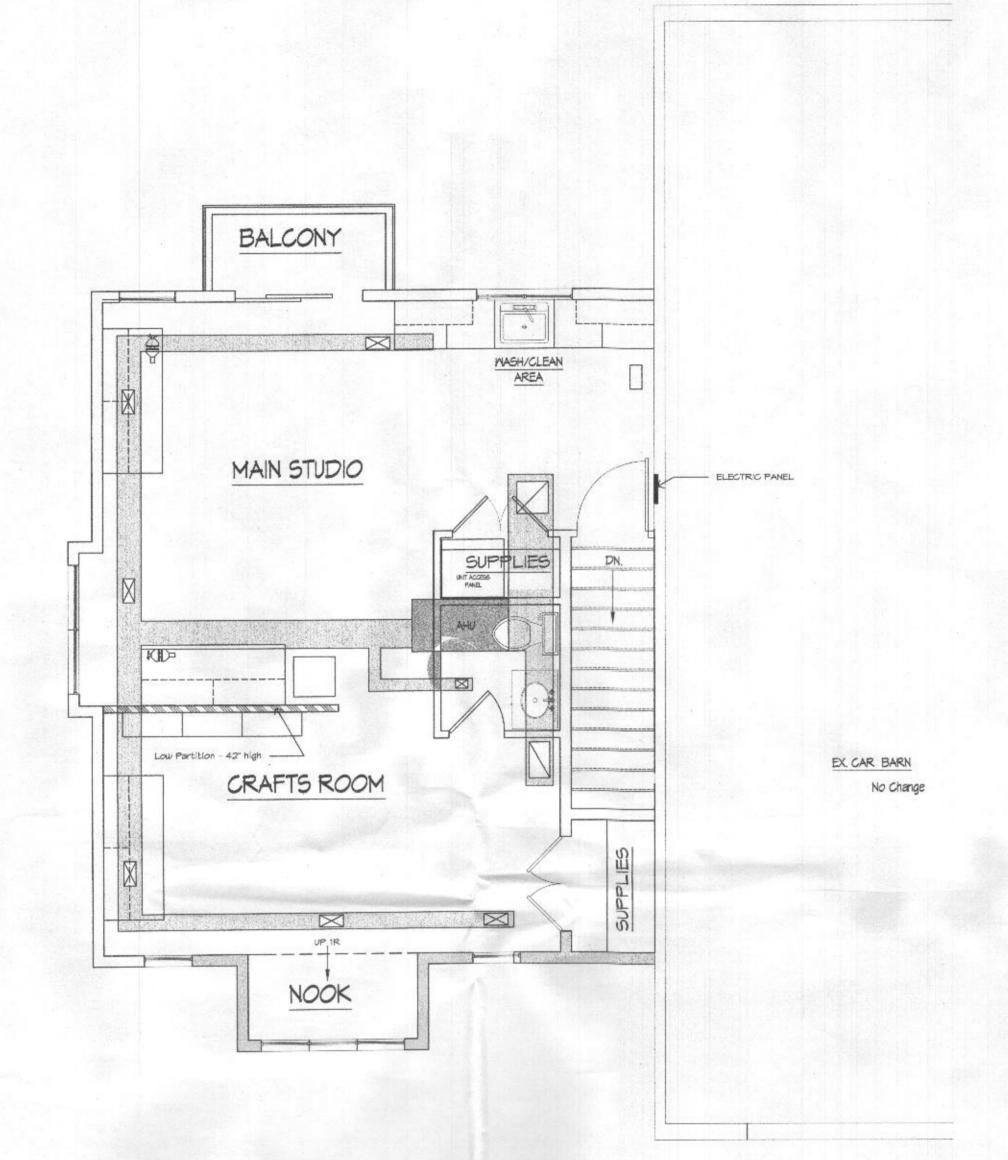

ELECTRICAL/LIGHTING LAYOUT


TE: 1- .- KS
COL ... TIVE

ARCHITECTURE PI L T I ICTION MANAGEMEN

CONSULTANTS:

ALL SQUARE



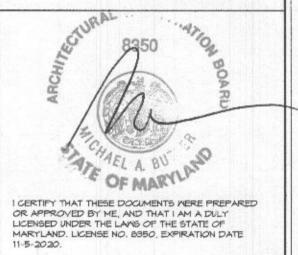

PROJECT:

TREXLER RESIDENCE CRAFTS STUDIO RENOVATIONS

13001 WAINWRIGHT ROAD HIGHLAND, MD 20777

MARK DA	TE DE	SCRIPTION
01 10/1	5/18	OWNER REVIEW
02 12/2	18/18	FINAL REVIEW
03 03/	15/21	PERMIT
	-12	
		heid self

PROJECT NO:	12-045-18
CAD DWG FILE:	GARAGE ADDITION-TREX
DRAWN BY:	SNYRDLEY
CHK'D BY:	MAB
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SHEET TITL

PROPOSED FLOOR PLAN

EM1.00