

Maura J. Rossman, M.D., Health Officer

### **Bureau of Environmental Health**

8930 Stanford Boulevard, Columbia, MD 21045 Main: 410-313-2640 | Fax: 410-313-2648 TDD 410-313-2323 | Toll Free 1-866-313-6300 www.hchealth.org

Facebook: www.facebook.com/hocohealth

RECEIPT D	DATE: 3292 ONSITE SEWAGE DISPOSAL SYSTEM P 568815		
APPROVAL D	DATE: 10/1/21 PERMIT: CONSTRUCTION A		
PROPERTY ADDRESS: 6505 MARE COURT, DAYTON, MD 21036			
SUBDIVISION	: WILLOWSHIRE LOT: 12 TAX ID: 03-603000		
CONTRACTOR: CHAVIS ENTERPRISES & SEPTIC SERVICES EMAIL: Ryan@chavisenterprisesllc.com			
CONTRACTOR ADDRESS: 23 EAST ELLENDALE, BEL AIR, MD 21014 PHONE: (410)838-3007			
PROPERTY OWNER: TOLL MID-ATLANTIC LP COMPANY, INC EMAIL: Sriley1@tollbrothers.com			
OWNER ADDRESS: 250 GIBRALTER ROAD, HORSHAM, PA 19044 PHONE: (410)872-9165			
SEPTIC TANK SIZE (GALLONS): 2000 TANK MANUFACTURER: Back River Pre-Cast, LLC			
PUMP MODEL: n.a. PUMP SIZE n.a. PUMP TANK CAPACITY: n.a.			
DISTRIBUTION SYSTEM:   GRAVITY PRESSURE DOSED BEDROOMS:   APPLICATION RATE: 1.2			
	LINEAR FEET REQUIRED: 88 INLET DEPTH: 2.5		
TRENCHES:	TRENCH WIDTH: 3 MAXIMUM BOTTOM DEPTH: 8.0		
	MINIMUM SPACE BETWEEN TRENCHES: 11 EFFECTIVE AREA BEGINNING DEPTH: 4.0		
LOCATION:	PER APPROVED SITE PLAN. SEWAGE DISPOSAL AREA AND TANK LOCATIONS MUST BE STAKED BY LICENSED SURVEYOR PRIOR TO PRE-CONSTRUCTION INSPECTION.		
NOTES:  INSTALL CLEANOUT IN SHC.  SET DISTRIBUTION BOX AT BEGINNING OF UPPER TRENCH, AND ORIENT SEPTIC TANK TO REDUCE THE ANGLES BETWEEN THE SEPTIC TANK AND DISTRIBUTION BOX			
ISSUED BY:	R BRICKER ISSUE DATE: EXPIRATION DATE:		
NOTE: CONTRACTOR MUST SCHEDULE A PRE-CONSTRUCTION INSPECTION PRIOR TO BEGINNING ANY INSTALLATION			
NOTE: CONTRACTOR MUST SCHEDULE AN INSPECTION AND GAIN APPROVAL OF ALL COMPONENTS PRIOR TO COVERING			
NOTE: STONE MUST BE APPROVED BY HEALTH DEPARTMENT AND GRAVEL TICKET MUST BE AVAILABLE FOR REVIEW.			
NOTE: WATERTIGHT TANKS REQUIRED			
NOTE: ALL PARTS OF SEPTIC SYSTEM SHALL BE AT LEAST 100 FEET DOWNGRADIENT FROM ANY WATER WELL  NOTE: MANHOLE RISERS REQUIRED ON ALL SEPTIC TANKS AND PUMP CHAMBERS			
NOTE: AN ELECTRICAL PERMIT IS REQUIRED FOR INSTALLATION OF ANY ELECTRICAL COMPONENTS OF THE SYSTEM			
NOTE: MDE RECOMMENDS SEPTIC TANKS, BAT, AND OTHER PRETREATMENT UNITS BE PUMPED AT A FREQUENCY ADEQUATE TO ENSURE THAT SOLIDS ARE NOT DISCHARGED TO THE DISPOSAL AREA			

NEITHER THE HOWARD COUNTY COUNCIL NOR THE HEALTH DEPARTMENT IS RESPONSIBLE FOR THE SUCCESSFUL OPERATION OF ANY SYSTEM.

PERMITTEE RESPONSIBLE FOR OBTAINING FINAL APPROVAL ON THIS PERMIT. CALL 410-313-1771 TO SCHEDULE INSPECTIONS.

NOT TO SCALE 11'≈36'	TRENCH/DRAINFIELD DATA
A 27' A	WIDTH INLET BOTTOM
(A) R(a) 17-02/4 // (A)	3' 2.5' 8'
ne' /// //	NUMBER OF TRENCHES 2
45/// //	TOTAL LENGTH _ 90'
// //45'	ABSORPTION AREA 270 so ft tsidewa
	DISTRIBUTION BOX LEVEL 185
	DISTRIBUTION BOX BAFFLE US
2/12	
27 - 34.	DISTRIBUTION BOX PORT
/ 107	
129'/	
	SEPTIC TANK DATA SEPTIC TANK 1 LEVEL
96/49//	
/ 10 /	MANUFACTURER Babylon
	CAPACITY 2000 GAL
	SEAM LOC
/ 42'	TANK LID DEPTH 1.5
	BAFFLES inlet + outlet
	BAFFLE FILTER
1-9	MANHOLE LOC in let + outlet 6" PORT LOC
8*	WATERTIGHT TEST
	SLOTTED YES
Ec. House	DATE ON LID 2-26-21
/90'	PUMP/SEPTIC TANK LEVEL
	MANUFACTURER
	CAPACITYGAL
	SEAM LOC
	TANK LID DEPTH
61'	BAFFLES
a de la companya de l	BAFFLE FILTER
/ 60'	MANHOLE LOC
18 //	6" PORT LOC
W 40-17-0234	WATERTIGHT TEST
	SLOTTED
ROAD NAME	DATE ON LID
PRE-CONSTRUCTION:	
4/6/21 Laid out 2×45' trenches on contour accordi	in to day of
1/19	y part of
INSTALLATION: 4/7/21 Tank Set, d-box set and 2x45 frem	iches constructed. Re-inspect
for sever line inlet baffle and SHC 88 8/9/21	SL constructed. Hole in
Foundation drilled too low Reins for SHC. (57)	10/1/21 SAC covered by
	100 STE COVERED DU
plumber. Contractor ran water from house into tank	SIX
The properties A. The contraction of the contractio	10/1/21
FINAL INSPECTOR Jusen / homes . DATE OF APPRO	VAL 10/1/21 .

#### PROFESSIONAL CERTIFICATION: I HEREBY CERTIFY THAT THESE DOCUMENTS WERE PREPARED BY ME OR UNDER MY RESPONSIBLE CHARGE, AND THAT I HOUSE OPTIONS: AM A DULY LICENSED PROFESSIONAL LAND SURVEYOR UNDER THE LAWS OF THE STATE OF MARYLAND, LICENSE NO. 21328, EXPIRATION DATE 1/8/23. HOUSE TYPE: RIDGEVIEW (MODERN FARMHOUSE) OPTION NO. 017 WALK-OUT BASEMENT OPTIONAL DROP ZONE LUXURY COVERED DECK OPTION NO. 263081 OPTION NO. 263168 DOUBLE WIDE TURN AROUND PAD FOR DRIVEWAY OPTION NO. 90012001 -TENTION EASEMEN? INITIAL TRENCH DATA BOTTOM MAX. DEPTH (8') TRENCH 1 (T1): 43.75 LF. GROUND ABOVE = 460.70' INV. IN = 458.20' BOTTOM TRENCH = 454.70' TRENCH 2 (T2): 43.75 L.F. N 69'05'06" GROUND ABOVE = 459.40' INV. IN = 456.90'BOTTOM TRENCH = 451.40' 1'' = 2000'TAX MAP 27, GRID 18 GENERAL NOTES: S (40,362 SQ. FT.) GROUND ABOVE 1. ZZZTHESE AREAS DESIGNATE A PRIVATE SEWAGE AREA OF AT LEAST 10,000 SQUARE FEET AS REQUIRED BY THE MARYLAND DEPARTMENT OF THE ENVIRONMENT FOR INDIVIDUAL SEWAGE DISPOSAL, IMPROVEMENTS OF ANY NATURE IN THIS AREA ARE RESTRICTED UNTIL PUBLIC SEWAGE IS AVAILABLE. THESE AREAS SHALL BECOME NULL AND VOID UPON CONNECTION TO A PUBLIC SEWAGE SYSTEM. THE COUNTY HEALTH OFFICER SHALL HAVE THE AUTHORITY TO GRANT VARIANCES FOR ENCROACHMENTS UNTO THE PRIVATE SEWAGE AREA. RECORDATION OF A MODIFIED SEWAGE AREA SHALL NOT BE NECESSARY. (DW4) 2. EXISTING WELLS, SEPTIC SYSTEMS, AND SEWAGE DISPOSAL AREAS WITHIN 100' OF THE PROPERTY AND THOSE WELLS WITHIN 200' DOWN GRADIENT OF EXISTING OR PROPOSED SEPTIC SYSTEMS OR SEWAGE DISPOSAL AREAS HAVE BEEN SHOWN 3. ANY CHANGES TO A PRIVATE SEWAGE AREA SHALL REQUIRE A REVISED #1.55 PERCOLATION CERTIFICATION PLAN. 4. BUILDING SETBACKS (B.R.L.'s) SHOWN HEREON PER SITE DEVELOPMENT PLAN RIDGEVIEW (MODERN FARMHOUSE) SETBACK DISTANCES SHOWN HEREON AS "±" HAVE AN ACCURACY OF ±0.1' FOOT. W=473.67' GF=473.00' TW=466.67 5. ANY CHANGES TO THE LOCATIONS OR DEPTHS TO ANY COMPONENTS MUST BE BF=465.13' GF=466.00 APPROVED BY THE ENGINEER AND THE HOWARD COUNTY HEALTH DEPARTMENT PRIOR TO INSTALLATION. A REVISED SITE PLAN MAY BE REQUIRED. INITIAL SYSTEM TRENCH DETAIL (T1) AND (T2) 7300 6. THE MAXIMUM EARTH COVER OVER THE TANK IS THREE (3) FEET. GREATER EARTH (NOT TO SCALE) COVER WILL REQUIRE A HEAVY LOAD BEARING TANK. 7. THE LOT SHOWN HEREON COMPLIES WITH THE MINIMUM OWNERSHIP, WIDTH, AND LOT AREA AS REQUIRED BY THE MARYLAND STATE DEPARTMENT OF THE GROUND ABOVE 11. THE EXISTING TOPOGRAPHY SHOWN HEREON IS FROM HOWARD COUNTY GIS AND A TOPOGRAPHIC SURVEY PREPARED BY BOHLER ENGINEERING ON 08/25/15 AND REVISED ON 09/03/15. BL-FAMIL 2000-9 allow to Gray ity Drain field HO-17-0234 MARE COURT 1ST REPLACEMENT SYSTEM 475 TRENCH DETAIL (T3) BUILDING RESTRICTION LINE SEPTIC TANK GROUND ELEV=461.80\* WELL LOCATION PLAN VIEW TOP OF TANK=460.80" TOP OF WALL GARAGE FLOOR PROPOSED DWELLING LOT 12 BASEMENT FLOOR GROUND ABOVE 470 PASSED PERC LOCATION 470 SEWAGE DISPOSAL SYSTEM DATA (5 BDRM): FAILED PERC LOCATION FF. ELEV. SEPTIC RESERVE AREA PROPOSED INVERT AT FOUNDATION WALL: 461.02' =468.00 111 1. EX. GRADE OVER TANK: 461.80° PROPOSED GRADE OVER TANK: 461.80' WELL BOX AREA INVERT IN: 460.10' INVERT OUT: 459.80' PROPOSED TREE BASEMENT SEWER SERVICE PROPOSED TREE SECTION A-A 465 465 2. DISTRIBUTION BOX PROPOSED TREE PROPOSED PROVIDED BY EJECTOR PUMP EXISTING GRADE OVER TANK: 461.70' SEPTIC TANK TOP=460.80" PROPOSED GRADE OVER TANK: 461.70' 6" PVC ROOF DRAIN INV.-453.10" INVERT IN: 459.70' INVERT OUT: 459.40' DISTRIBUTION WELL LOCATION CERTIFICATION: BACK RIVER PRE-CAST, LLC P.O. Box 325 (Byrolen, MD. 25371 419-433-3394 office 419-533-4116 fbx 3. INITIAL TRENCH DESIGN (5 BORM x 150 GPD/BDRM = 750 GPD) 750 GPD + 1.2 APP. RATE = 625 SF 460 460 USE 3' WIDE TRENCH WITH 66" GRAVEL BELOW PIPE THE EXISTING WELL SHOWN FOR LOT & (TAG NO. HO-17-0234) Dwg. No. 2904-20 Ho Scale Aug 11, 2008 11' MIN. SPACING BETWEEN TRENCH EDGES 625 SF $\div$ 3' WIDTH = 208.33 LF x 0.42 (SIDEWALL REDUCTION) = 87.50 LF MIN. HAS BEEN FIELD LOCATED AND IS ACCURATELY SHOWN HEREON. =458.13 111 USE 2 43.75' LONG TRENCHES = 87.50 LF ONSITE SEWAGE DISPOSAL SYSTEM DESIGN PLAN 4. 1ST REPLACEMENT TRENCH DESIGN (5 BDRM x 150 GPD/BDRM = 750 GPD) 750 GPD + 1.2 APP. RATE = 625 SF 2ND REPLACEMENT SYSTEM LOT 12 455 455 TRENCH DETAIL (T4) USE 3' WIDE TRENCH WITH 66" GRAVEL BELOW PIPE WILLOWSHIRE ENGINEERING • PLANNING • SURVEYING • ENVIRONMENTAL 12' MIN. SPACING BETWEEN TRENCH EDGES (NOT TO SCALE) 625 SF + 3' WIDTH = 208.33 LF x 0.38 (SIDEWALL REDUCTION) = 76.17 LF MIN. LIBER 18479, FOLIO 296 4" PVC — SEWER • 2.00% USE 1 76.25' LONG TRENCHES = 76.25 LF

5. 2ND REPLACEMENT TRENCH DESIGN (5 BDRM x 150 GPD/BDRM = 750 GPD)

625 SF  $\div$  3' WIDTH = 208.33 LF x 0.36 (SIDEWALL REDUCTION) = 75 LF MIN.

750 GPD ÷ 1.2 APP. RATE = 625 SF

USE 1 75' LONG TRENCHES = 75 LF

13' MIN. SPACING BETWEEN TRENCH EDGES

USE 3' WIDE TRENCH WITH 66" GRAVEL BELOW PIPE

450

SEPTIC SYSTEM PROFILE

SCALE = HORIZONTAL: 1"=50"

VERTICAL: 1"=5"

**ESE CONSULTANTS** 

2,000 GALLON SEPTIC TANK 2-Compartment

Stock Item [Approx. 19,900 lbs]

PLAT NO. 25503

ELECTION DISTRICT No. 5


HOWARD COUNTY, MARYLAND

ADDRESS: 6505 MARE COURT

DAYTON, MARYLAND 21036

ESE Consultants, Inc. 7164 Columbia Gateway Drive • Suite 230 • Columbia, MD 21046 T: 410-872-9105

DATE: 01/13/2021 SCALE: 1"= 30" FILE: OSDS LOT 2 CHK'D: M.J.B JOB NO: 4520 DRAWN: R.C.K

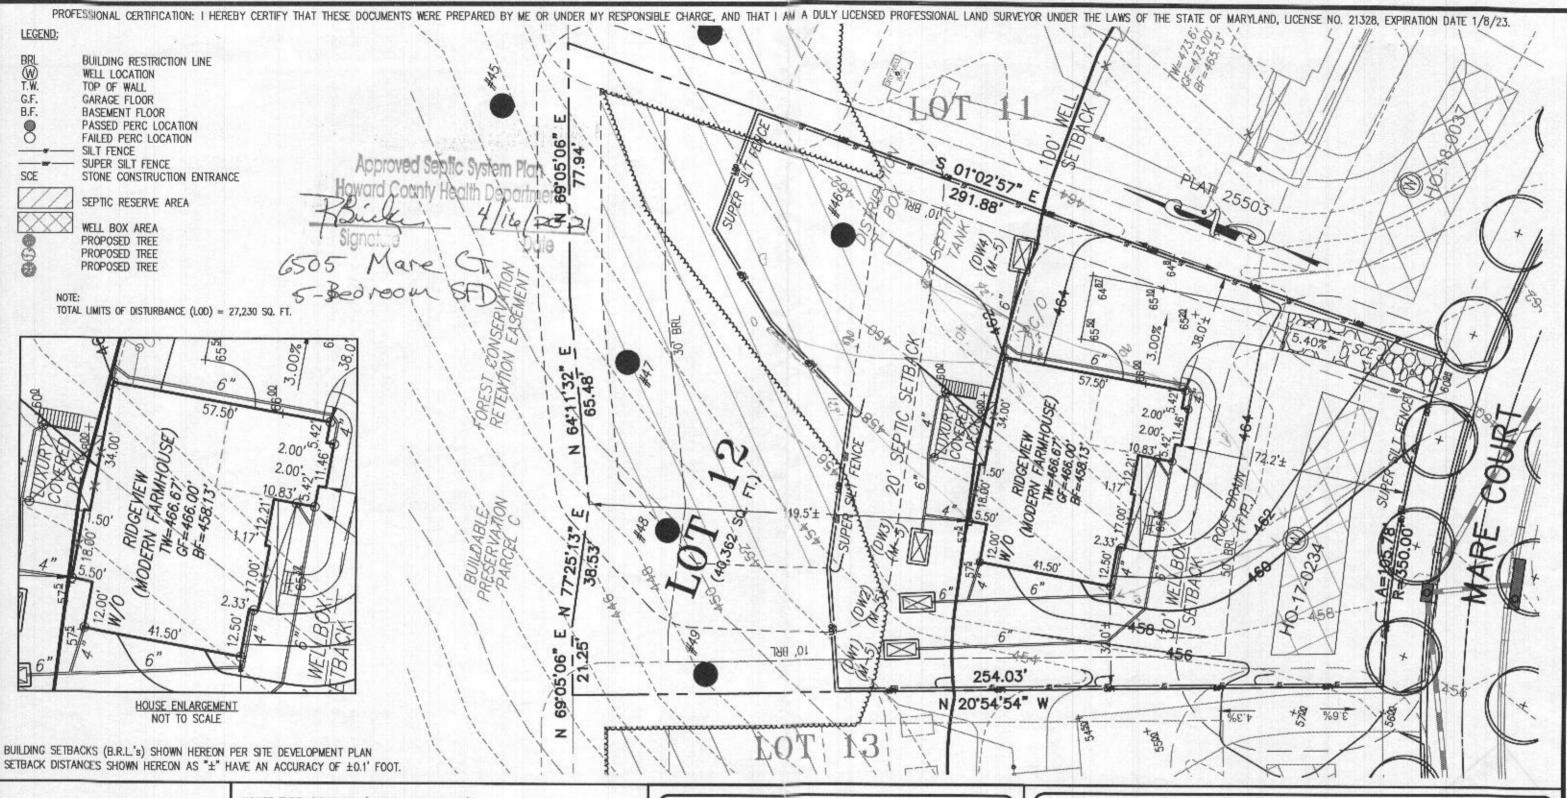



### HOUSE TYPE: RIDGEVIEW (MODERN FARMHOUSE)

WALK-OUT BASEMENT
OPTIONAL DROP ZONE
LUXURY COVERED DECK
DOUBLE WIDE TURN AROUND PAD FOR DRIVEWAY

OPTION No. 017 OPTION No. 263081 OPTION No. 263168 OPTION No. 90012001

WELL NUMBER: HO-17-0234

ADDRESS:

6505 MARE COURT DAYTON, MD 21036

## PLOT PLAN LOT 12 WILLOWSHIRE

LIBER 18479, FOLIO 296
PLAT NO. 25503
5th ELECTION DISTRICT
HOWARD COUNTY, MARYLAND

# **ESE CONSULTANTS**

INGINEERING · PLANNING · SURVEYING · ENVIRONMENT

ESE Consultants, Inc.

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DATE: 01/12/2021 CHK'D: M.J.B. SCALE: 1"= 30' JOB NO: 4520 FILE: 4520 PP Lot 12 - RIDGE, M.F. DRAWN: V.X.P. / R.C.K.